



EXISTING DIAGRAM

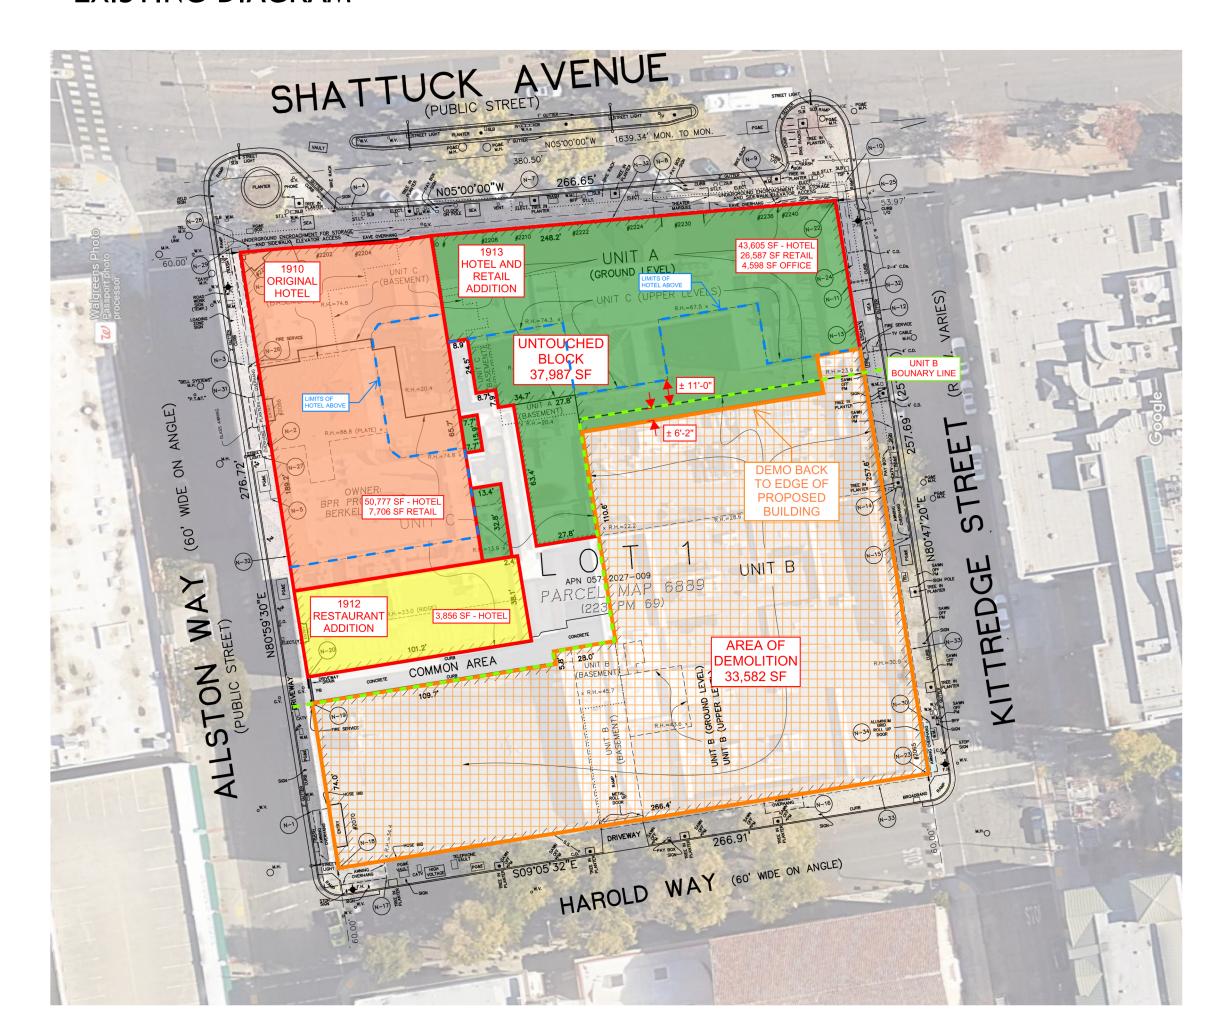

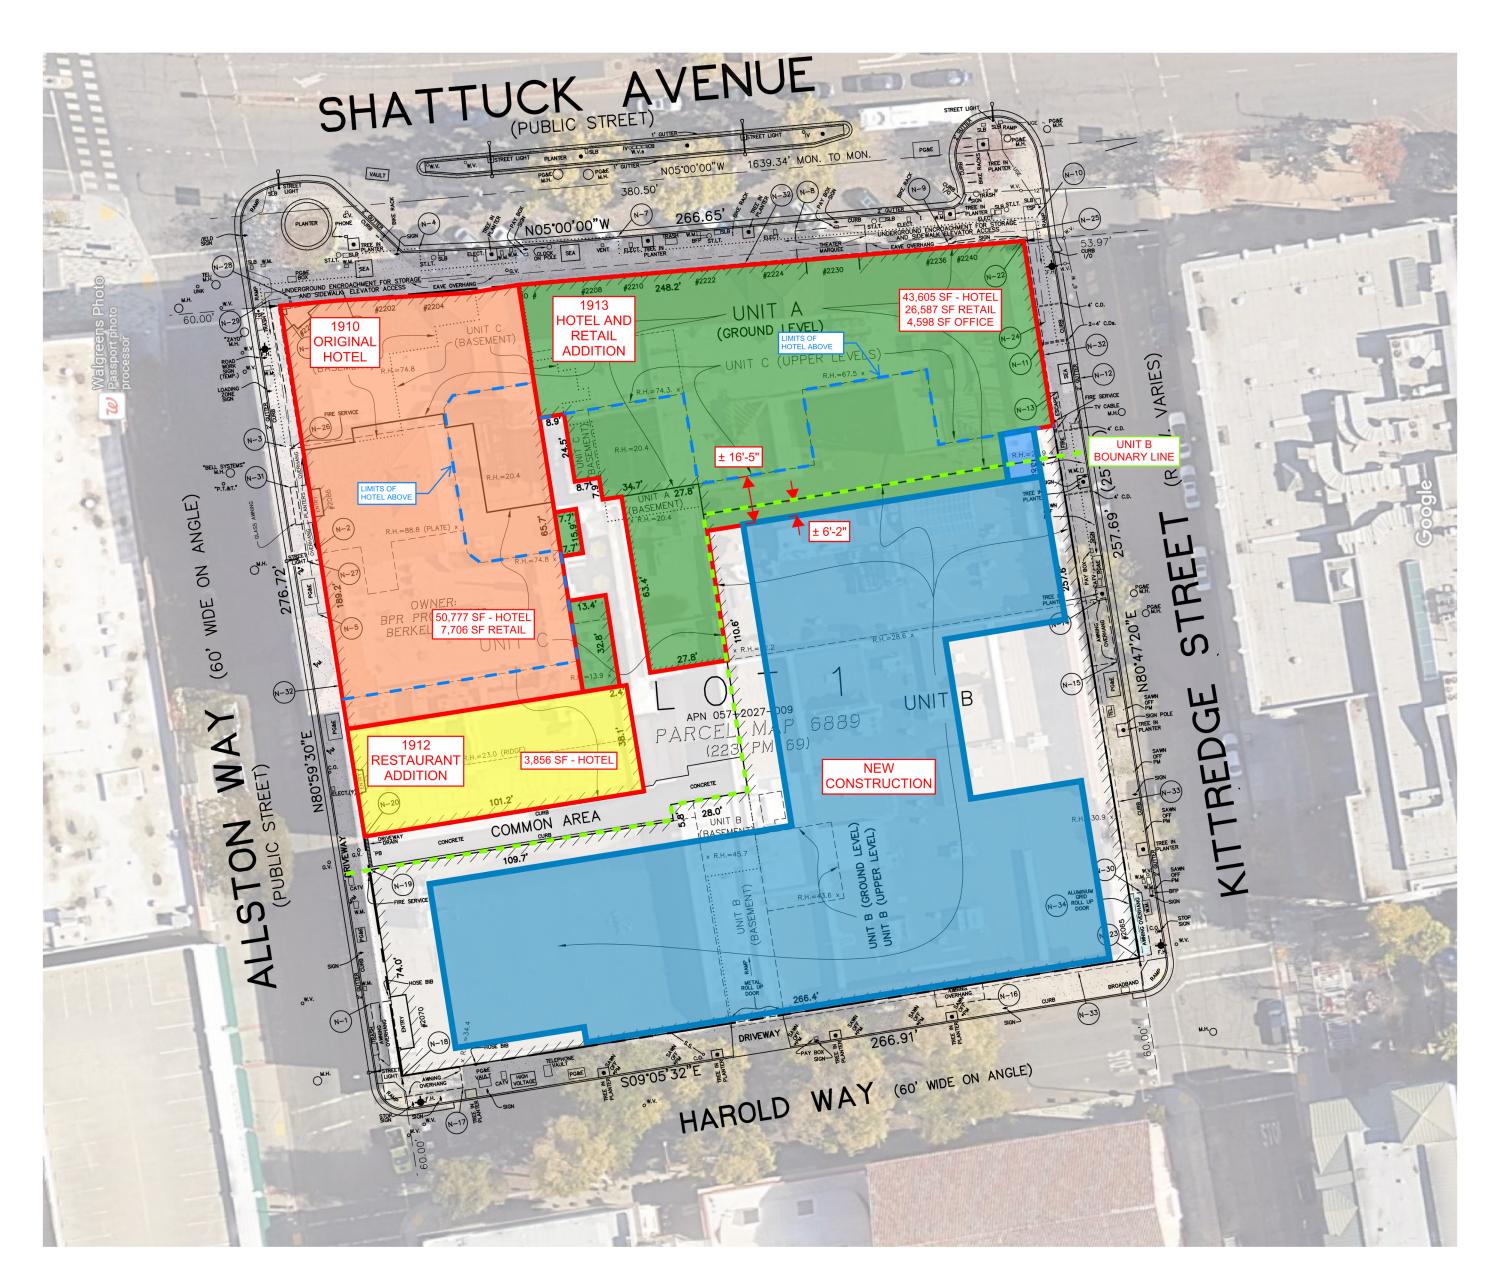

PROPOSED CONSTRUCTION DIAGRAM

PROJECT #: 121246
DRAWN BY: TF

CHECKED BY: MM

NILES BOLTON ASSOCIATES

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T 404 365 7600

www.nilesbolton.com

APPLICANT:

BILL SCHRADER

T 925 638 8782

No.	Description	Date
D	USE PERMIT	10/25/21
E	USE PERMIT RESUBMIT.	12/10/21
F	SAP	12/22/21
I	SAP RESUBMIT.	3/23/22
L	USE PERMIT RESUBMIT.	3/28/22
M	APRIL DRC MEETING	4/11/22
N	JUNE LMRKS. MEETING	5/10/22

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BERKELEY PLAZA 2065 KITTREDGE ST BERKELEY, CA 94704

SHEET TITLE:

DEMO SITE PLAN EXHIBIT

SHEET NUMBER:

1 DEMO SITE PLAN EXHIBIT A0-004 NOT TO SCALE

UNIT MIX

	Name	S1	S2-A	S2-B	S 3	MS1-A	MS1-B	NS1	A1-A	A1-B	A2-A	A2-B	A 3	B1-A	B1-B	B2-A	B2-B	B2-C	B2-D	B2-E	B3-A	в3-в	В4	B5	B6-A	B6-B	B7-A	B7−B	B8	В9	C1	C2	1	Total	
	Bedrooms	1	1	1	1	1	1	1	1	1	1	1	1	2	2	2	2	2	2	2	2	2	2	2	2	2	2	2	2	2	3	3	1	Units	Beds
	Bathrooms	1	1	1	1	1	1	1	1	1	1	1	1	2	2	2	2	2	2	2	2	2	2	2	2	2	2	2	2	2	3	3	1.5		
	Beds	1	1	1	1	1	1	1	2	2	2	2	2	4	4	4	4	4	4	4	4	4	4	4	4	4	4	4	4	4	6	6	3		
	Unit GSF	436	381	375	396	322	348	295	638	633	641	695	718	952	986	984	991	1003	993	908	1030	973	953	956	962	909	977	932	953	971	1373	1374	867		
	Floor 8	1	-	1	-	2	-	1	2	1	2	_	-	4	1	-	-	-	-	1	-	1	1	1	-	1	-	1	1	-	-	1	-	23	69
	Floor 7	1	-	1	_	2	1	1	1	1	2	_	-	4	1	1	1	-	1	-	1	-	1	1	1	-	1	-	1	1	1	1	-	27	86
	Floor 6	1	-	1	-	2	1	1	1	1	2	_	-	4	1	1	1	-	1	-	1	-	1	1	1	-	1	-	1	1	1	1	-	27	
	Floor 5	1	-	1	-	2	1	1	1	1	2	-	-	4	1	1	1	_	1	_	1	-	1	1	1	-	1	-	1	1	1	1	-	27	
	Floor 4	1	-	1	-	2	1	1	1	1	2		-	4	1	1	1	-	1	_	1	-	1	1	1	-	1	_	1	1	1	1	-	27	
	Floor 3	1	1	-	-	2	1	1	2	-	-	2	-	4	1	1	1	1	-	-	1	-	1	1	1	-	1	-	1	1	1	1	-	27	
CONC	Floor 2	1	1	-	1	2	-	1	3	-	-	_	1	4	4	-	-	-	-	-	-	1	1	1	1	-	-	-	1	-	-	_	-	23	66
	Floor 1	-	-	-	-	-	-	-	1	-	-	-	-	1	-	-	-	-	-	-	-	-	-	-	-	-	-	-	-	-	-	-	4	6	18
	Floor -1																																	-	-
T	otal Units	7	2	5	1	14	5	7	12	5	10	2	1	29	10	5	5	1	4	1	5	2	7	7	6	1	5	1	7	5	5	6	4	187	583
				T							30		1									101				_	T					L1	4		
	Unit Mix	4%	1%	3%	1%	7%	3%	4%	6%	3%	5%	1%	1%	16%	5%	3%	3%	1%	2%	1%	3%	1%	4%	4%	3%	1%	3%	1%	4%	3%	3%	3%	2%	% of	Mix
					22%						16%											54%									(5 ^용	2%		
																																			•
	1 Bedrooms	7	2	5	1	14	5	7	12	5	10	2	1	58	20	10	10	2	8	2	10	4	14	14	12	2	10	2	14	10	15	18	4	310	
В	edroom Mix	2%	1%	2%	0%	5%	2%	2%	4%	2%	3%	1%	0 응	19%	6%	3%	3%	1%	3%	1%	3%	1%	5%	5%	4%	1%	3%	1%	5%	3%	5%	6%	1%	100%	
	1						_																												•
	Total Beds	7	2	5	1	14	5	7	24	10	20	4	2	116	40	20	20	4	16	4	20	8	28	28	24	4	20	4	28	20	30	36	12	583	
	Bed Mix	1%	0%	1%	0%	2%	1%	1%	4%	2%	3%	1%	0%	20%	7%	3%	3%	1%	3%	1%	3%	1%	5%	5%	4%	1%	3%	1%	5%	3%	5%	6%	2%	100%	
	Deg MIX										10%											69%									1	1%	2%]

	S1	S2-A	S2-B	S3	MS1-A	MS1-B	NS1	A1-A	A1-B	A2-A	A2-B	A3	B1-A	B1-B	B2-A	B2-B	B2-C	B2-D	B2-E	B3-A	в3-в	B4	B5	B6-A	B6-B	B7-A	B7-B	B8	В9	C1	C2	LW-A	Total
	1	1	1	1	1	1	1	1	1	1	1	1	2	2	2	2	2	2	2	2	2	2	2	2	2	2	2	2	2	3	3	1	
	1	1	1	1	1	1	1	1	1	1	1	1	2	2	2	2	2	2	2	2	2	2	2	2	2	2	2	2	2	3	3	1.5	
	1	1	1	1	1	1	1	2	2	2	2	2	4	4	4	4	4	4	4	4	4	4	4	4	4	4	4	4	4	6	6	3	
	436	381	375	396	322	348	295	638	633	641	695	718	952	986	984	991	1003	993	908	1030	973	953	956	962	909	977	932	953	971	1373	1374	867	
loor 8	436	-	375	-	644	-	295	1,276	633	1,282	-	-	3,808	986	-	-	-	-	908	-	973	953	956	-	909	-	932	953	-	-	1,374	-	17,69
loor 7	436	-	375	-	644	348	295	638	633	1,282	-	-	3,808	986	984	991	-	993	_	1,030	-	953	956	962	-	977	-	953	971	1,373	1,374	-	21,96
loor 6	436	-	375	-	644	348	295	638	633	1,282	-	-	3,808	986	984	991	-	993	_	1,030	-	953	956	962	-	977	-	953	971	1,373	1,374	-	21,96
loor 5	436	-	375	-	644	348	295	638	633	1,282	-	-	3,808	986	984	991	-	993	-	1,030	-	953	956	962	1	977	-	953	971	1,373	1,374	-	21,96
loor 4	436	-	375	-	644	348	295	638	633	1,282	-	-	3,808	986	984	991	-	993	1	1,030	-	953	956	962	-	977	-	953	971	1,373	1,374	-	21,96
loor 3	436	381	_	-	644	348	295	1,276	-	-	1,390	-	3,808	986	984	991	1,003	-	1	1,030	-	953	956	962	1	977	-	953	971	1,373	1,374	-	22,09
loor 2	436	381	_	396	644	-	295	1,914	-	-	-	718	3,808	3,944	ı	-	-	-	-	-	973	953	956	962	1	-	-	953	-	-	-	-	17,33
loor 1	-	-	_	-	-	-	-	638	-	-	1	-	952	1	1	-	-	-	-	-	-	-	1	-	-	1	-	-	-	-	-	3,468	5,05
loor -1													_	1	I	_	_	_	_	-	-	-	-	_	_	-	_	_	_	-	-	-	-
	3,052	762	1,875	396	4,508	1,740	2,065	7,656	3,165	6,410	1,390	718	27,608	9,860	4,920	4,955	1,003	3 , 972	908	5,150	1,946	6,671	6,692	5 , 772	909	4,885	932	6,671	4,855	6,865	8,244	3,468	150,02

AREA TABLE

					Amenity /			Exterior SF				
Floors	GSF	Common	Utility	Res.	Lobby	Retail	Parking	(not in GSF)	# Units	# Parking	Efficiency	Height
Floor 8	22 , 752	3,492	452	17,740	1,068	-	-	2,946	23		78.0%	85
Floor 7	26 , 157	3 , 678	430	22,049	-	-	-	_	27		84.3%	74
Floor 6	26 , 157	3 , 678	430	22,049	-	-	-	-	27		84.3%	64
Floor 5	26 , 157	3 , 678	430	22,049	-	-	-	_	27		84.3%	54
Floor 4	26 , 157	3 , 678	430	22,049	-	-	-	_	27		84.3%	44
Floor 3	26 , 360	3 , 656	431	22,273	-	-	-	-	27		84.5%	34
Floor 2	24,111	3,630	533	17 , 590	2,358	-	-	_	23		73.0%	24
Floor 1	23,946	2,982	3,711	3 , 599	5 , 522	4,993	3,139	-	6		15.0%	14
Floor -1	19,684	884	980	-	-	-	17,820	-	-	43	0.0%	(10)
Total	221,481	29,356	7,827	149,398	8,948	4,993	20,959	2,946	187	43		

EXISTING SITE DESCRIPTION

THE USE OF THE APPROXIMATELY 95,000 SF EXISTING BUILDING INCLUDES SERVICE AND OFFICE SPACE (APPROXIMATELY 3,000 RSF) ON 4 LEVELS (BASEMENT THROUGH PARTIAL THIRD FLOOR). THERE WERE NO PREVIOUS RESIDENTIAL USES ON THE PROJECT SITE. THE ENTIRE EXISTING BUILDING AND BASEMENT WILL BE DEMOLISHED WITHIN THE PROPERTY BOUNDARY.

PROPOSED PROJECT DESCRIPTION

THE PROPOSED PROJECT IS A MIX-USED OFF-CAMPUS STUDENT HOUSING COMMUNITY THAT CONTAINS 187 UNITS (583 BEDS). THE PROJECT UNIT TYPES INCLUDE STUDIOS, 1 BEDROOM, 2 BEDROOM, 3 BEDROOM, AND LIVE/WORK UNITS.

THE BUILDING TOTALS 221,401 GSF, WHICH INCLUDES 149,398 SF OF RESIDENTIAL AREA AND 8,948 SF OF INDOOR RESIDENTIAL AMENITY AREA IN ADDITION TO 2,946 SF OF ELEVATED ROOF TERRACE AMENITY. THERE IS ALSO 4,993 SF OF GROUND LEVEL COMMERCIAL.

THE PROJECT IS DESIGNED AS TYPE-IIIA
CONSTRUCTION (WOOD) OVER TYPE-IA (PODIUM)
WITH A TOTAL OF 8 RESIDENTIAL LEVELS. A PARTIAL
BASEMENT IS ALSO PROVIDED TO HOUSE 43 PARKING
SPACES. ADDITIONALLY, THE PROJECT WILL PROVIDE
122 BIKE PARKING SPACES ON LEVEL 1.

PROJECT #: 121246

DRAWN BY: TF

CHECKED BY: MM

NILES BOLTON ASSOCIATES

3060 Peachtree Rd. N.W. Suite 600 Atlanta, GA 30305

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APPLICANT:

BILL SCHRADER

T 925 638 8782

No.	Description	Date
3	PRELIM APP SB330	7/21/21
2	SD SET	9/16/21
)	USE PERMIT	10/25/21
Ξ	USE PERMIT RESUBMIT.	12/10/21
-	SAP	12/22/21
1	USE PERMIT RESUBMIT.	3/17/22
	SAP RESUBMIT.	3/23/22
-	USE PERMIT RESUBMIT.	3/28/22
٨	APRIL DRC MEETING	4/11/22
1	JUNE LMRKS. MEETING	5/10/22
)	USE PERMIT RESUBMIT.	08/22/22

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BERKELEY PLAZA 2065 KITTREDGE ST BERKELEY, CA 94704

CA STUDENT LIVING

SHEET TITLE:

PROJECT STATS

SHEET NUMBER:


CONSTRUCTION INFORMATION

	BERKELEY PLAZA
CONSTRUCTION TYPE	5 LEVELS OF TYPE IIIA CONSTRUCTION OVER 3 LEVELS OF TYPE IA AND 1 BASEMENT LEVEL OF TYPE IA
SPRINKLER SYSTEM	NFPA 13
CLIMATE ZONE	3
SEISMIC CATEGORY	D
JURISDICTION	CITY OF BERKELEY

	BUILDING HEI	GHTS AND AREAS							
	TYPE IIIA CO	ONSTRUCTION							
	MAX ALLOWABLE S	STORIES: 5							
BUILDING HEIGHT, PER CBC TABLE	ACTUAL STORIES (A	ABOVE PODIUM): 5							
504.3 AND 504.4	MAX ALLOWABLE H	HEIGHT: 85'							
	ACTUAL HEIGHT (A	BOVE AVG GRADE):	: 84'						
BUILDING AREA, PER CBC TABLE 506.2 [At+(NS x If)]xSa	LEVEL	BLDG A AREA	BLDG B AREA	BLDG C AREA					
	4	8,441 SF	8,841 SF	8,727 SF					
	5	8,441 SF	8,841 SF	8,727 SF					
	6	8,441 SF	8,841 SF	8,727 SF					
	7	8,441 SF	8,841 SF	8,727 SF					
	8	5,268 SF	8,784 SF	8,629 SF					
TOTAL PROPOSED BUILD	ING AREA	39,032 SF	44,148 SF	43,537 SF					
At: Tabular Area per Table 506.2 SM NS: Tabular Area Factor for non Sprinkled If: Frontage Increase Sa: 2 (R Occupancy)		24,000 + (24,000 X 0) X2 =	24,000 + (24,000 X 0) X2 =	24,000 + (24,000 X 0) X2=					
TOTAL ALLOWABLE	AREA	48,000 SF	48,000 SF	48,000 SF					
	TYPE IA CO	NSTRUCTION							
	MAX ALLOWABLE S	STORIES: UNLIMITE	D						
BUILDING HEIGHT PER CBC TABLE	ACTUAL STORIES: 3	1							
504.3 AND 504.4	MAX ALLOWABLE H	HEIGHT: UNLIMITED)						
	ACTUAL HEIGHT (A	BOVE AVG GRADE):	: 34'						
BUILDING AREA, PER CBC TABLE	TOTAL ALLOWABLE AREA: UNLIMITED								
506.2	TOTAL PROPOSED AREA: 98,305 SF								

FIRE RESISTANCE RATING REQUIREMENTS FOR BUILDING ELEMENTS PER TABLE 601										
BUILDING ELEMENT	REQUIRED HO	OURLY RATING	PROVIDED HOURLY RATING							
	TYPE IA	TYPE IIIA	TYPE IA	TYPE IIIA						
PRIMARY STRUCTURAL FRAME	3	1	3	1						
EXTERIOR BEARING WALL	3	2	3	2						
INTERIOR BEARING WALL	3	1	3	1						
NON-BEARING EXTERIOR WALL	2	2	2	2						
FLOOR CONSTRUCTION	2	1	2	1						
ROOF CONSTRUCTION	1.5	1	1.5	1						

	ALL UNITS TO COMPLY WITH THE FAIR HOUSING ACT AS THE BASE SAFE
UNITS	HARBOR. ALL UNITS TO BE ADAPTABLE AND ACCESSIBLE PER CBC SECTION
	1128A.1
	ALL AREAS OF COMMERCE THAT ARE OPEN TO THE PUBLIC MUST COMPLY
PUBLIC AREAS	WITH 2010 ADA ACCESSIBILITY GUIDELINES AND CBC CHAPTER 11B
COMMON USE AREAS	ALL COMMON USE AREAS NOT OPEN TO THE PUBLIC MUST COMPLY WITH
COMMON OSE AREAS	CBC SECTION 1127A
ANS OF EGRESS	
	EXITS TO BE 1/3 DIAGONAL OF THE LENGTH OF THE MAXIMUM OVERALL
	DIAGONAL DIMENSION OF THE AREA SERVED, MEASURED ALONG THE
	SHORTEST DIRECT LINE OF TRAVEL WITHIN A ONE HOUR RATED CORRIDO
	AREAS OF REFUGE NOT REQUIRED PER CBC 1009.3 EXCEPTION 8

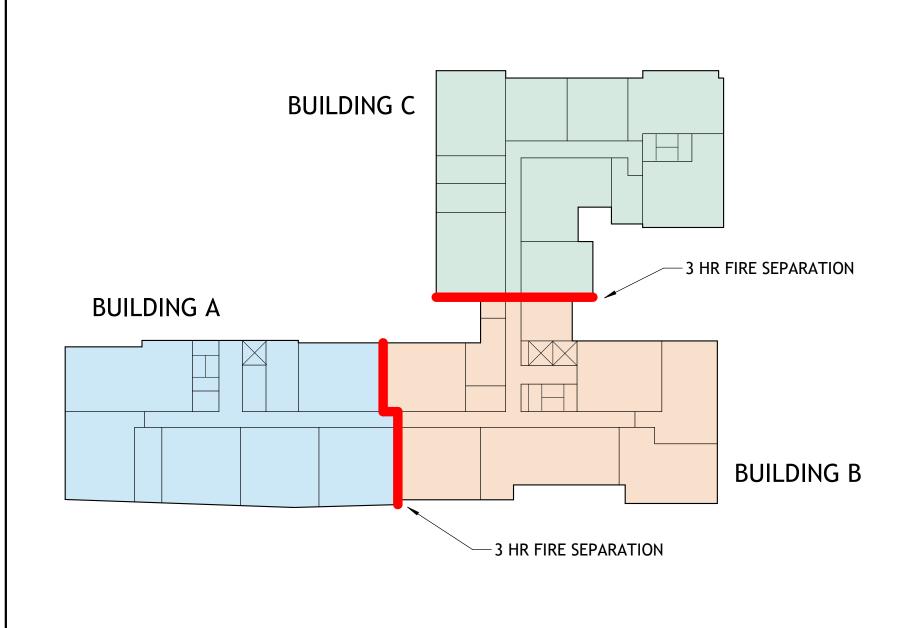


CODE INFORMATION

The proposed project will comply with the Berkeley Energy Code (BMC Chapter 19.36) and Berkeley Green Code (BMC Chapter 19.37), adopted by City Council on December 3rd., 2019, where building design must incorporate all-electric

WAIVER/CONCESSION LIST

- <u>Waiver</u> to exceed the height limit -Proposed at 87'-0", where 60 ft/75 ft with use permit is the limit. The 87'-0" proposed is measured to top of roof and does not include the additional 5 feet parapet allowed by right.
- <u>Waiver</u> to construct rooftop projections, such as mechanical appurtenances or architectural elements which exceed the maximum heigh limit for the district.
- Waiver to reduce the 15' minimum front setbacks above 75'
- Waiver to increase the 5' maximum front setbacks between 0' to 20'
- Waiver to reduce the minimum landscape coverage of usable open space from 40% of the provided usable open space to 25% of the provided usable open space
- Waiver to reduce the required parking spaces for the commercial spaces from 8 required spaces to 0 provided spaces.
- Concession for 20% reduction in useable open space and the percentage of associated landscaped area.

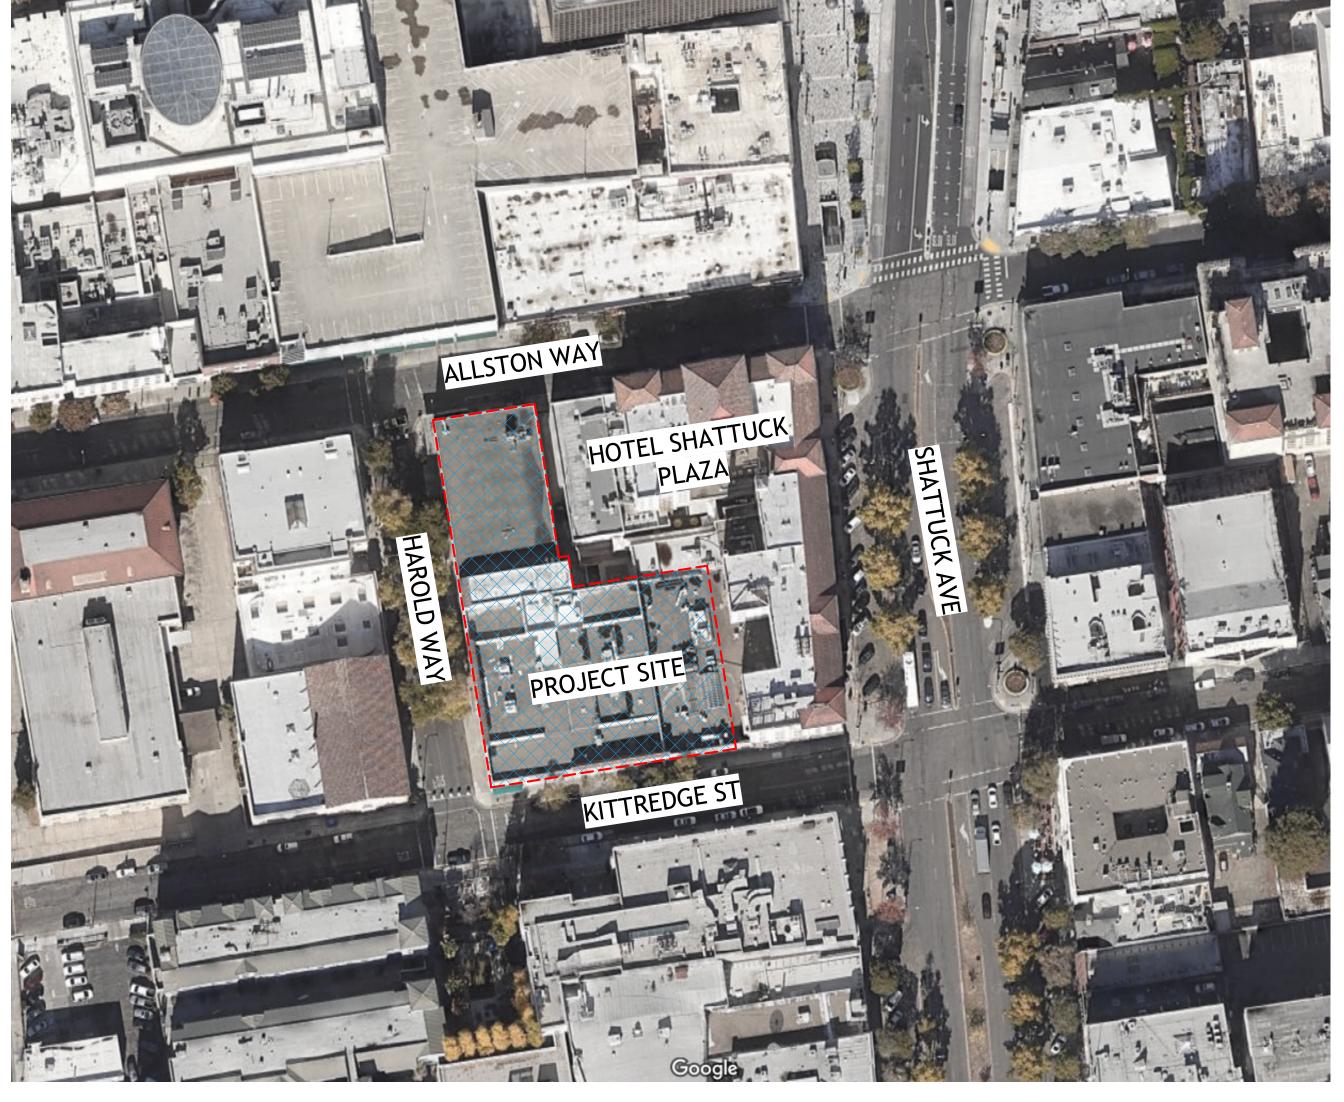





1 SITE MAP A0-006 12" = 1'-0"

TABULATION FORM

PROJECT ADDRESS: 2065 KITTREDGE ST DATE: 08-22-22 ZONING DISTRICT: C-DMU CORE APPLICANT'S NAME: BILL SCHRADER

UNIT, PARKING SPACES, AND BEDROOMS	Existing	Proposed	Permitted/ Required	
NUMBER OF DWELING UNITS	0	187	NA	
NUMBER OF PARKING SPACES MAX 0.5 SPACES PER UNIT	0	43	0 MIN 94 MAX	
NUMBER OF BIKE PARKING SPACES 310 BEDROOMS 1 LONG TERM SPACE PER 3 BEDROOMS = 104 SPACES 1 SHORT TERM SPACE PER 40 BEDROOMS = 8 SPACES	0	122 LOCATED ON LEVEL 1	112	
YARDS AND HEIGHTS				
FRONT YARD SETBACK (FT)	0'	0'	0' MIN (0'-75' HEIGHT) 15' MIN (75'+ HEIGHT) 5' MAX (0'-20' HEIGHT)	WAIVER
BUILDING HEIGHT (STORIES)	3	8	-	WAIVER
MAXIMUM (FT)	25'	87'	-	WAIVER
AREAS				-
LOT AREA	33,582 SF	33,582 SF	-	-
TOTAL GROSS FLOOR AREA TOTAL AREA COVERED BY ALL FLOORS	92,531 SF	186,354 SF	-	
BUILDING FOOTPRINT	33,582 SF	27,619 SF	-	
LOT COVERAGE	100%	82%	-	
USEABLE OPEN SPACE 80 SF OF USABLE OPEN SPACE PER UNIT	0	11,916 SF	14,960 SF	CONCESSION
FLOOR AREA RATIO	2.8:1	5.5:1	-	

COMMERCIAL SPACE REQUIREMENTS 4,993 SF TOTAL	Existing	Proposed	Permitted/ Required	
1,803 SF ALLSTON RETAIL SUITE 1,668 SF KITTREDGE RETAIL SUITE 1,522 SF WORK SPACE IN LIVE/WORK UNITS				
NUMBER OF PARKING SPACES				
1.5 SPACES PER 1,000 SF OF RETAIL SUITE = 6 SPACES 1 SPACE PER FIRST 1,000 SF OF WORK AREA AND 1 SPACE PER ADDITIONAL 750 SF OF WORK AREA = 2 SPACES	0	0	8	WAIVER
NUMBER OF BIKE PARKING SPACES	0	3	2	
1 BIKE SPACE PER 2,000 SF OF COMMERCIAL FLOOR AREA	U)	3	
SPACES LOCATED AT EXTERIOR BIKE RACKS				
USEABE OPEN SPACE			4.00	
1 SF OF USABLE OPEN SPACE PER 50 SF OF COMMERCIAL FLOOR AREA	0	100	100	

PROJECT #: 121246 DRAWN BY: TF CHECKED BY: MM

NILES BOLTON

3060 Peachtree Rd. N.W. Suite 600

ASSOCIATES

T 404 365 7600

Atlanta, GA 30305

www.nilesbolton.com

APPLICANT:

BILL SCHRADER

T 925 638 8782

No.	Description	Date
D	USE PERMIT	10/25/21
Е	USE PERMIT RESUBMIT.	12/10/21
F	SAP	12/22/21
G	USE PERMIT RESUBMIT.	1/11/22
Н	USE PERMIT RESUBMIT.	3/17/22
I	SAP RESUBMIT.	3/23/22
L	USE PERMIT RESUBMIT.	3/28/22
М	APRIL DRC MEETING	4/11/22
N	JUNE LMRKS. MEETING	5/10/22
Р	USE PERMIT RESUBMIT.	08/22/22

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BERKELEY PLAZA 2065 KITTREDGE ST BERKELEY, CA 94704

STUDENT LIVING BERKELEY,

SHEET TITLE:

ZONING AND CODE

SHEET NUMBER:

BASE PROJECT AREA TOTALS

BASE PROJECT BEDROOM MIX

BASE PROJECT

	RESIDENTIAL	COMMON	COMMERCIAL	AMENITY	TOTAL
L1	3,587	2,954	4,983	5,387	16,911
L2	20,641	3,021		1,481	25,143
L3	22,034	2,973			25,007
L4	22,034	2,973			25,007
L5	22,034	2,973			25,007
L6	22,034	2,973			25,007
L7	16,197	2,865		975	20,037

TOTAL 162,119

BASE PROJECT

		STUDIO	1 BEDROOM	2 BEDROOM	3 BEDROOM	TOTAL UNITS	TOTAL BEDROOMS
Ì	L1	0	5	1	0	6	7
	L2	6	5	14	1	26	42
	L3	6	4	15	2	27	46
	L4	6	4	15	2	27	46
	L5	6	4	15	2	27	46
	L6	6	4	15	2	27	46
	L7	5	4	11	1	21	34
•							

161 267

BASE PROJECT FLOORPLANS




NOTES:

The bike parking is excluded from the area calculations for the Base and Proposed Projects. In both Projects, the main bike room is located on level 1 on the alley at the rear of the building.

In both Projects (Base & Proposed), parking and utility areas are excluded from the Residential Floor Area calculations. There are no residential floor area uses on level U1.

The live/work units on Level 1 are designed according to Berkeley Zoning Code 23.312 and IBC Section 419. The non-residential area (the commercial work area) is approximately 46% of the total unit in compliance with IBC 419.1.1.

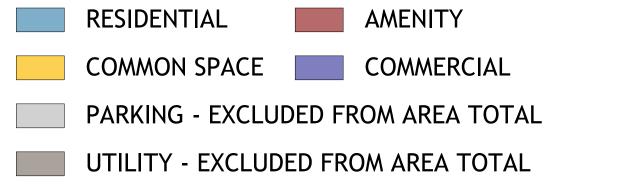

EXTERIOR OPEN SPACE - EXCLUDED FROM AREA TOTAL

BASE PROJECT TABULATION FORM

TABULATION FORM

PROJECT ADDRESS: 2065 KITTREDGE ST

DATE: 08-22-22

APPLICANT'S NAME: BILL SCHRADER

ZONING DISTRICT: C-DMU CORE

UNIT, PARKING SPACES, AND BEDROOMS	Existing	Proposed	Permitted/ Required
NUMBER OF DWELING UNITS	0	161	NA
NUMBER OF PARKING SPACES MAX 0.5 SPACES PER UNIT	0	35	0 MIN 81 MAX
NUMBER OF BIKE PARKING SPACES 267 BEDROOMS 1 LONG TERM SPACE PER 3 BEDROOMS = 89 SPACES 1 SHORT TERM SPACE PER 40 BEDROOMS = 7 SPACES	0	122 LOCATED ON LEVEL 1	96
YARDS AND HEIGHTS			
FRONT YARD SETBACK (FT)	0'	0'	0' MIN (0'-75' HEIGH 15' MIN (75'+ HEIGH 5' MAX (0'-20' HEIGH
BUILDING HEIGHT (STORIES)	3	7	-
MAXIMUM (FT)	25'	75'	-
AREAS			
LOT AREA	33,582 SF	33,582 SF	-
TOTAL GROSS FLOOR AREA TOTAL AREA COVERED BY ALL FLOORS	92,531 SF	162,119 SF	-
BUILDING FOOTPRINT	33,582 SF	27,619 SF	-
LOT COVERAGE	100%	82%	-
USEABLE OPEN SPACE 80 SF OF USABLE OPEN SPACE PER UNIT	0	13,721 SF	12,880 SF
FLOOR AREA RATIO	2.8:1	4.8:1	-

COMMERCIAL SPACE REQUIREMENTS 4,993 SF TOTAL	Existing	Proposed	Permitted/ Required
1,803 SF ALLSTON RETAIL SUITE 1,668 SF KITTREDGE RETAIL SUITE 1,522 SF WORK SPACE IN LIVE/WORK UNITS			
NUMBER OF PARKING SPACES 1.5 SPACES PER 1,000 SF OF RETAIL SUITE = 6 SPACES 1 SPACE PER FIRST 1,000 SF OF WORK AREA AND 1 SPACE PER ADDITIONAL 750 SF OF WORK AREA = 2 SPACES	0	8	8
NUMBER OF BIKE PARKING SPACES 1 BIKE SPACE PER 2,000 SF OF COMMERCIAL FLOOR AREA SPACES LOCATED AT EXTERIOR BIKE RACKS	0	3	3
USEABE OPEN SPACE 1 SF OF USABLE OPEN SPACE PER 50 SF OF COMMERCIAL FLOOR AREA	0	100	100

DENSITY BONUS CALCULATIONS

Calculator

Base Project	Base # Units	Base # Units	% VLI units	# VLI Units	#VLI Units	Bonus %	# DB Units	# DB Units	Total Units
sq. ft see calculation below	base project/avg. unit size	Base Units/Max. Residential Density (rounded up)	VLI = Very Low Income <50 AMI	% VLI x Base # Units			%Bonus x Base # Units (rounded up)	%Bonus x Base # Units (rounded up)	base unit + DB Units (rounded up)
162,119	162.68	163.00	5%	8.15	9.00	20.0%	32.60	33.00	196

Base Project Square Footage (a,b)	Floor	Residential Sq. Footage Proposed (a)	Number of Units Proposed		%VLI	%DB
16,911	first	16,911	6	Total Square Footage: 186,354	5%	20.0%
25,143	second	22,797	23		6%	22.5%
25,007	third	25,007	27	Proposed Units: 187	7%	25.0%
25,007	fourth	25,007	27		8%	27.5%
25,007	fifth	25,007	27	Average Unit Size: 997	9%	30.0%
25,007	sixth	25,007	27		10%	32.5%
20,037	seventh	25,007	27		11%	35.0%
	eighth	21,611	23			
162,119	TOTAL	186,354	187			

(a) Includes Residential Amenities (lobby, mailbox room bike parking, restrooms, etc.)

Note that required outdoor area (80 sf/unit) will be provided at public plazas and elevated outdoors decks

(b) Based on a 75' maximum building height

PROJECT #: 121246

DRAWN BY: TF

NILES BOLTON

CHECKED BY: MM

3060 Peachtree Rd. N.W. Suite 600 Atlanta, GA 30305

ASSOCIATES

T 404 365 7600

www.nilesbolton.com

APPLICANT:

BILL SCHRADER
T 925 638 8782

₩.	Description	Date
	USE PERMIT RESUBMIT.	12/10/21
	SAP	12/22/21
	USE PERMIT RESUBMIT.	1/11/22
	USE PERMIT RESUBMIT.	3/17/22
	USE PERMIT RESUBMIT.	3/28/22
	USE PERMIT RESUBMIT.	08/22/22

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BERKELEY PLAZA 2065 KITTREDGE ST BERKELEY, CA 94704

LIVING

STUDENT

SHEET TITLE:

DENSITY BONUS PLANS - BASE

SHEET NUMBER:

PROPOSED PROJECT AREA TOTALS

PROPOSED PROJECT BEDROOM MIX

PROPOSED PROJECT


	RESIDENTIAL	COMMON	COMMERCIAL	AMENITY	TOTAL
L1	3,587	2,954	4,983	5,387	16,911
L2	17,542	2,960		2,295	22,797
L3	22,034	2,973			25,007
L4	22,034	2,973			25,007
L5	22,034	2,973			25,007
L6	22,034	2,973			25,007
L7	22,034	2,973			25,007
L8	17,745	2,900		966	21,611


TOTAL 186,354


PROPOSED PROJECT


					TOTAL	TOTAL
	STUDIO	1 BEDROOM	2 BEDROOM	3 BEDROOM	UNITS	BEDROOMS
L1	0	5	1	0	6	7
L2	6	4	13	0	23	36
L3	6	4	15	2	27	46
L4	6	4	15	2	27	46
L5	6	4	15	2	27	46
L6	6	4	15	2	27	46
L7	6	4	15	2	27	46
L8	5	5	12	1	23	37
				TOTAL	187	310

PROPOSED PROJECT FLOORPLANS

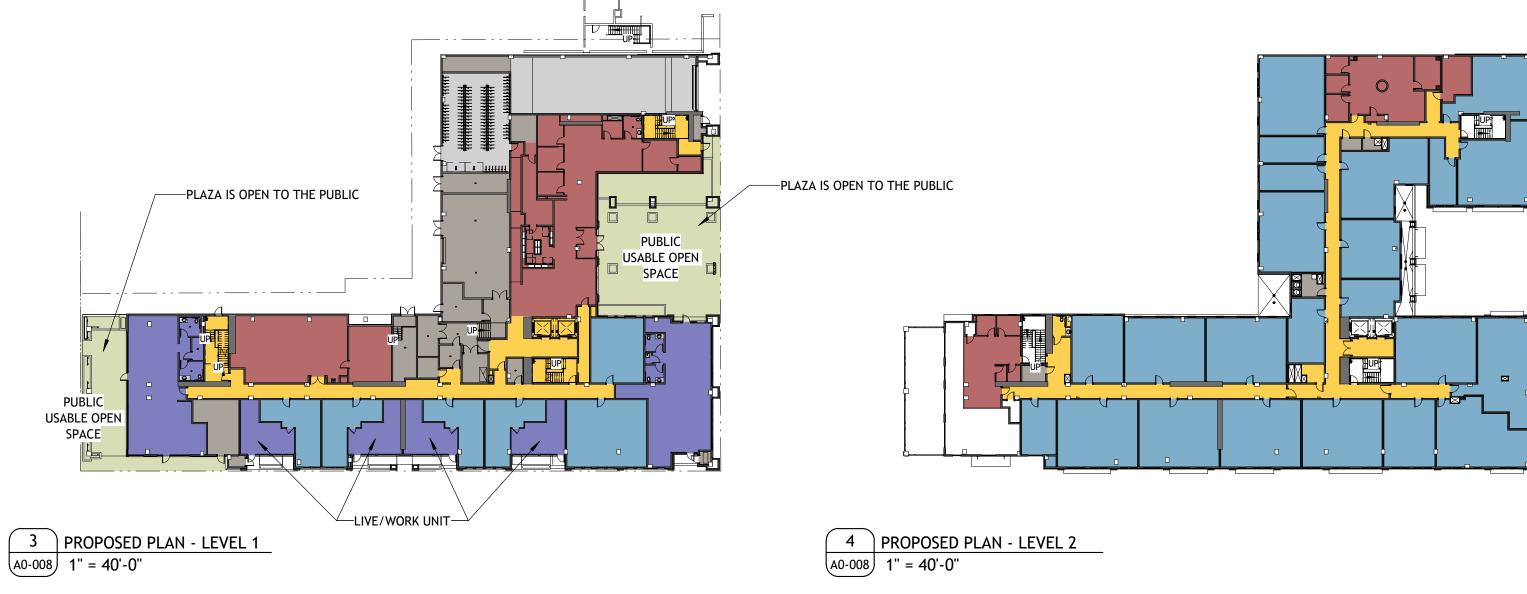

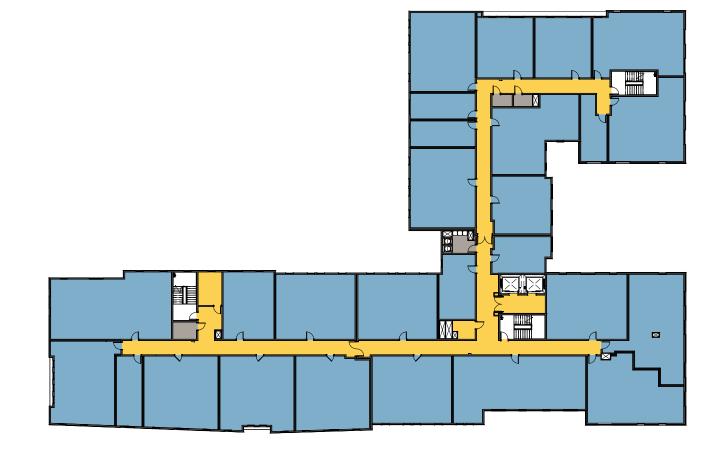

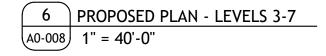

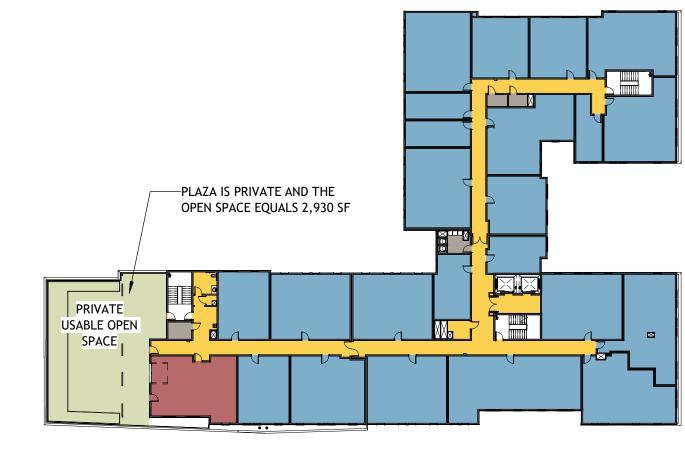

7 PROPOSED PLAN - LEVEL 8 A0-008 1" = 40'-0"

NOTES:

The bike parking is excluded from the area calculations for the Base and Proposed Projects. In both Projects, the main bike room is located on level 1 on the alley at the rear of the building.

In both Projects (Base & Proposed), parking and utility areas are excluded from the Residential Floor Area calculations. There are no residential floor area uses on level U1.

The live/work units on Level 1 are designed according to Berkeley Zoning Code 23.312 and IBC Section 419. The non-residential area (the commercial work area) is approximately 46% of the total unit in compliance with IBC 419.1.1.

RESIDENTIAL AMENITY

COMMON SPACE COMMERCIAL

PARKING - EXCLUDED FROM AREA TOTAL

UTILITY - EXCLUDED FROM AREA TOTAL

EXTERIOR OPEN SPACE - EXCLUDED FROM AREA TOTAL

PROPOSED PROJECT TABULATION FORM

TABULATION FORM

PROJECT ADDRESS: 2065 KITTREDGE ST

DATE: 08-22-22

APPLICANT'S NAME: BILL SCHRADER

ZONING DISTRICT: C-DMU CORE

UNIT, PARKING SPACES, AND BEDROOMS	Existing	Proposed	Permitted/ Required	
NUMBER OF DWELING UNITS	0	187	NA	
NUMBER OF PARKING SPACES MAX 0.5 SPACES PER UNIT	0	43	0 MIN 94 MAX	
NUMBER OF BIKE PARKING SPACES 310 BEDROOMS 1 LONG TERM SPACE PER 3 BEDROOMS = 104 SPACES 1 SHORT TERM SPACE PER 40 BEDROOMS = 8 SPACES	0	122 LOCATED ON LEVEL 1	112	
YARDS AND HEIGHTS				
FRONT YARD SETBACK (FT)	0'	0'	0' MIN (0'-75' HEIGHT) 15' MIN (75'+ HEIGHT) 5' MAX (0'-20' HEIGHT)	WAIVER
BUILDING HEIGHT (STORIES)	3	8	-	WAIVER
MAXIMUM (FT)	25'	87'	_	WAIVER
AREAS				
LOT AREA	33,582 SF	33,582 SF	-	
TOTAL GROSS FLOOR AREA TOTAL AREA COVERED BY ALL FLOORS	92,531 SF	186,354 SF	-	
BUILDING FOOTPRINT	33,582 SF	27,619 SF	-	
LOT COVERAGE	100%	82%	-	
USEABLE OPEN SPACE 80 SF OF USABLE OPEN SPACE PER UNIT	0	11,916 SF	14,960 SF	CONCESSIO
FLOOR AREA RATIO	2.8:1	5.5:1	-	

COMMERCIAL SPACE REQUIREMENTS	Existing	Proposed	Permitted/ Required	
4,993 SF TOTAL				
1,803 SF ALLSTON RETAIL SUITE 1,668 SF KITTREDGE RETAIL SUITE 1,522 SF WORK SPACE IN LIVE/WORK UNITS				
NUMBER OF PARKING SPACES				
1.5 SPACES PER 1,000 SF OF RETAIL SUITE = 6 SPACES 1 SPACE PER FIRST 1,000 SF OF WORK AREA AND 1 SPACE PER ADDITIONAL 750 SF OF WORK AREA = 2 SPACES	0	0	8	WAIVE
NUMBER OF BIKE PARKING SPACES	0	2	2	
1 BIKE SPACE PER 2,000 SF OF COMMERCIAL FLOOR AREA	0	3	3	
SPACES LOCATED AT EXTERIOR BIKE RACKS				
USEABE OPEN SPACE				
1 SF OF USABLE OPEN SPACE PER 50 SF OF COMMERCIAL FLOOR AREA	0	100	100	

DENSITY BONUS CALCULATIONS

Calculator

Base Project	Base # Units	Base # Units	% VLI units	# VLI Units	#VLI Units	Bonus %	# DB Units	# DB Units	Total Units
sq. ft see calculation below	base project/avg. unit size	Base Units/Max. Residential Density (rounded up)	VLI = Very Low Income <50 AMI	% VLI x Base # Units			%Bonus x Base # Units (rounded up)	%Bonus x Base # Units (rounded up)	base unit + DB Units (rounded up)
162,119	162.68	163.00	5%	8.15	9.00	20.0%	32.60	33.00	196

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25,007	third	25,007	27	Proposed Units: 187	7%	25.0%
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20,037	seventh	25,007	27		11%	35.0%
	eighth	21,611	23			
162,119	TOTAL	186,354	187			

(a) Includes Residential Amenities (lobby, mailbox room bike parking, restrooms, etc.)

Note that required outdoor area (80 sf/unit) will be provided at public plazas and elevated outdoors decks

(b) Based on a 75' maximum building height

PROJECT #: 121246
DRAWN BY: TF

CHECKED BY: MM NILES BOLTON

ASSOCIATES

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T 404 365 7600

Atlanta, GA 30305

www.nilesbolton.com

APPLICANT:

BILL SCHRADER

T 925 638 8782

No.	Description	Date
D	USE PERMIT	10/25/21
E	USE PERMIT RESUBMIT.	12/10/21
F	SAP	12/22/21
G	USE PERMIT RESUBMIT.	1/11/22
Н	USE PERMIT RESUBMIT.	3/17/22
L	USE PERMIT RESUBMIT.	3/28/22
Р	USE PERMIT RESUBMIT.	08/22/22

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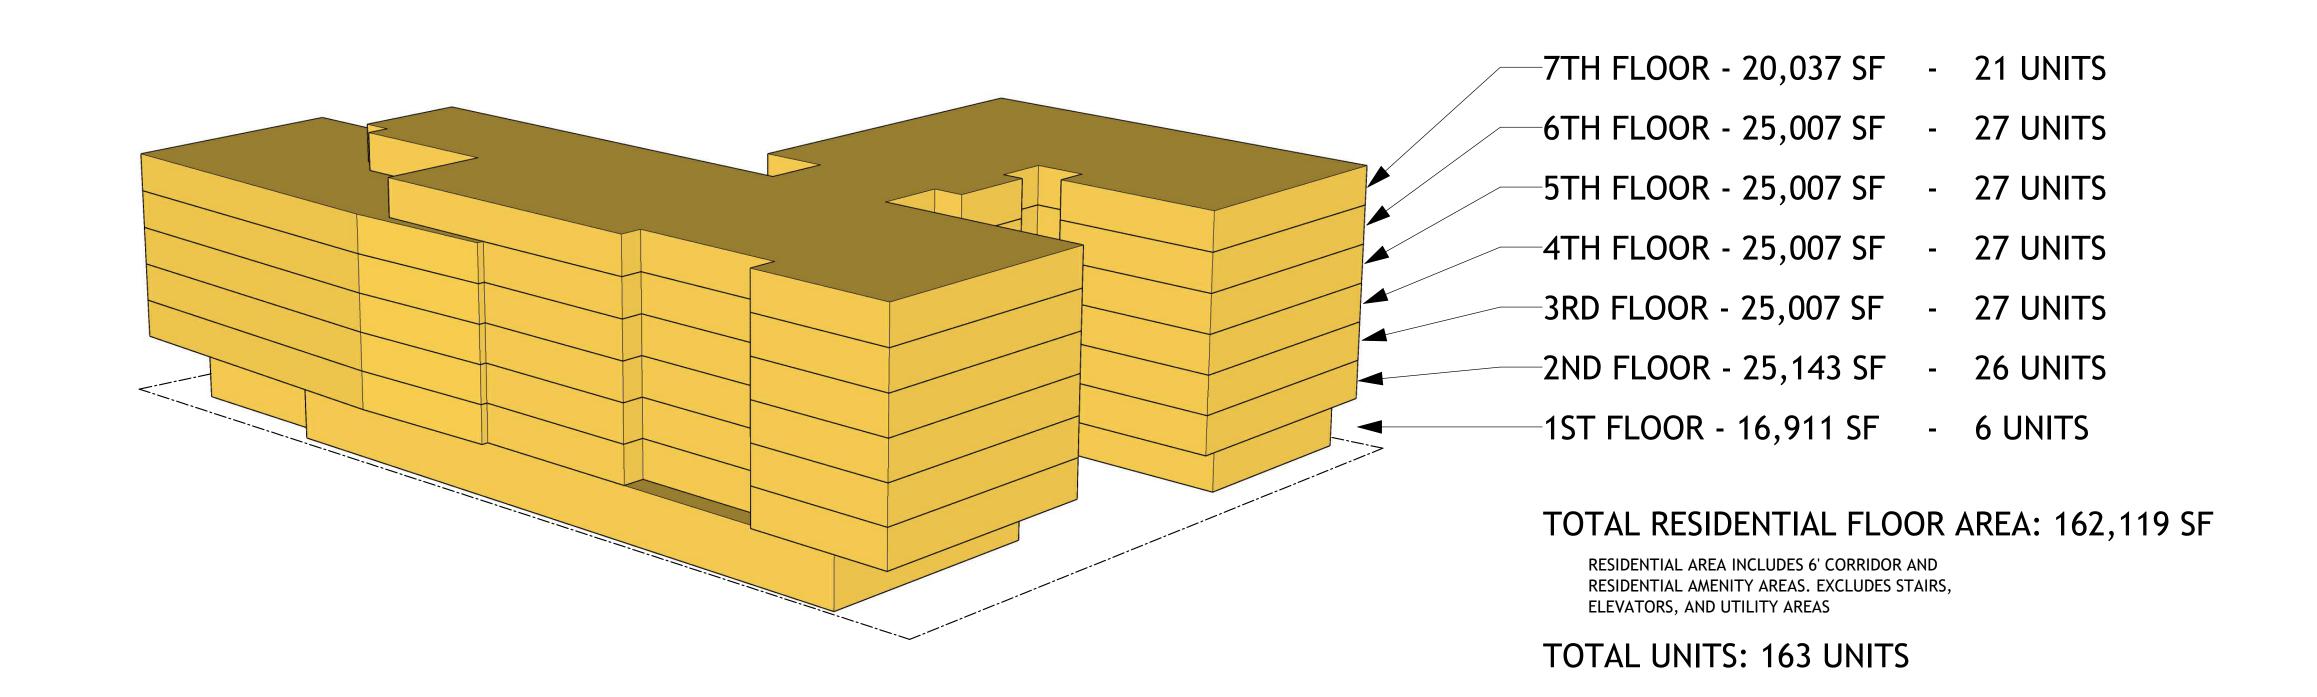
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DENSITY BONUS PLANS - PROPOSED


SHEET NUMBER:

800-0A

BASE PLAN MODEL



PROPOSED PLAN MODEL

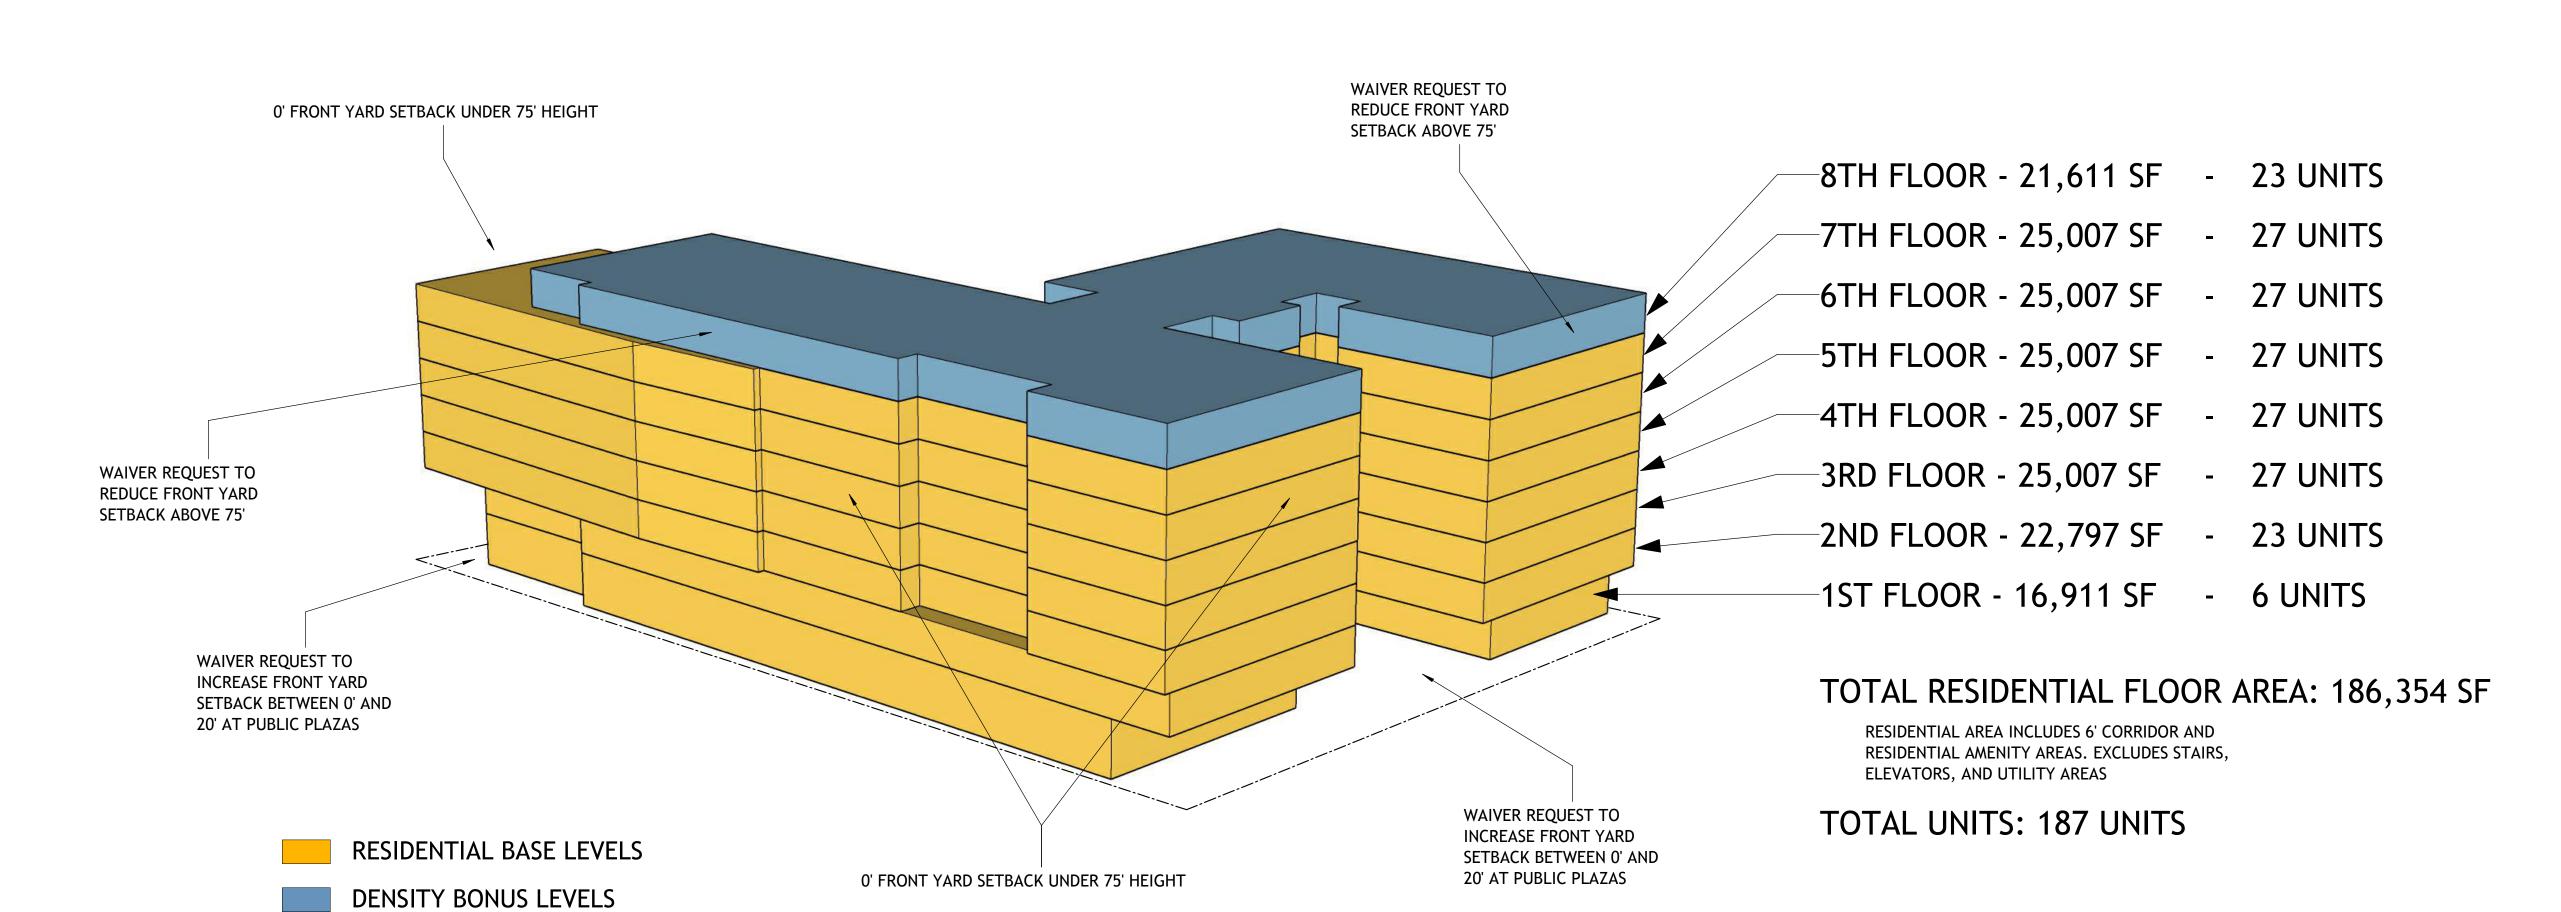

PROJECT #: 121246

DRAWN BY: TF

CHECKED BY: MM

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APPLICANT:

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No.	Description	Date
Е	USE PERMIT RESUBMIT.	12/10/21
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L	USE PERMIT RESUBMIT.	3/28/22
Р	USE PERMIT RESUBMIT.	08/22/22


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SHEET TITLE:

DENSITY BONUS MODEL

SHEET NUMBER:



PROJECT #: 121246 DRAWN BY: TF CHECKED BY: MM
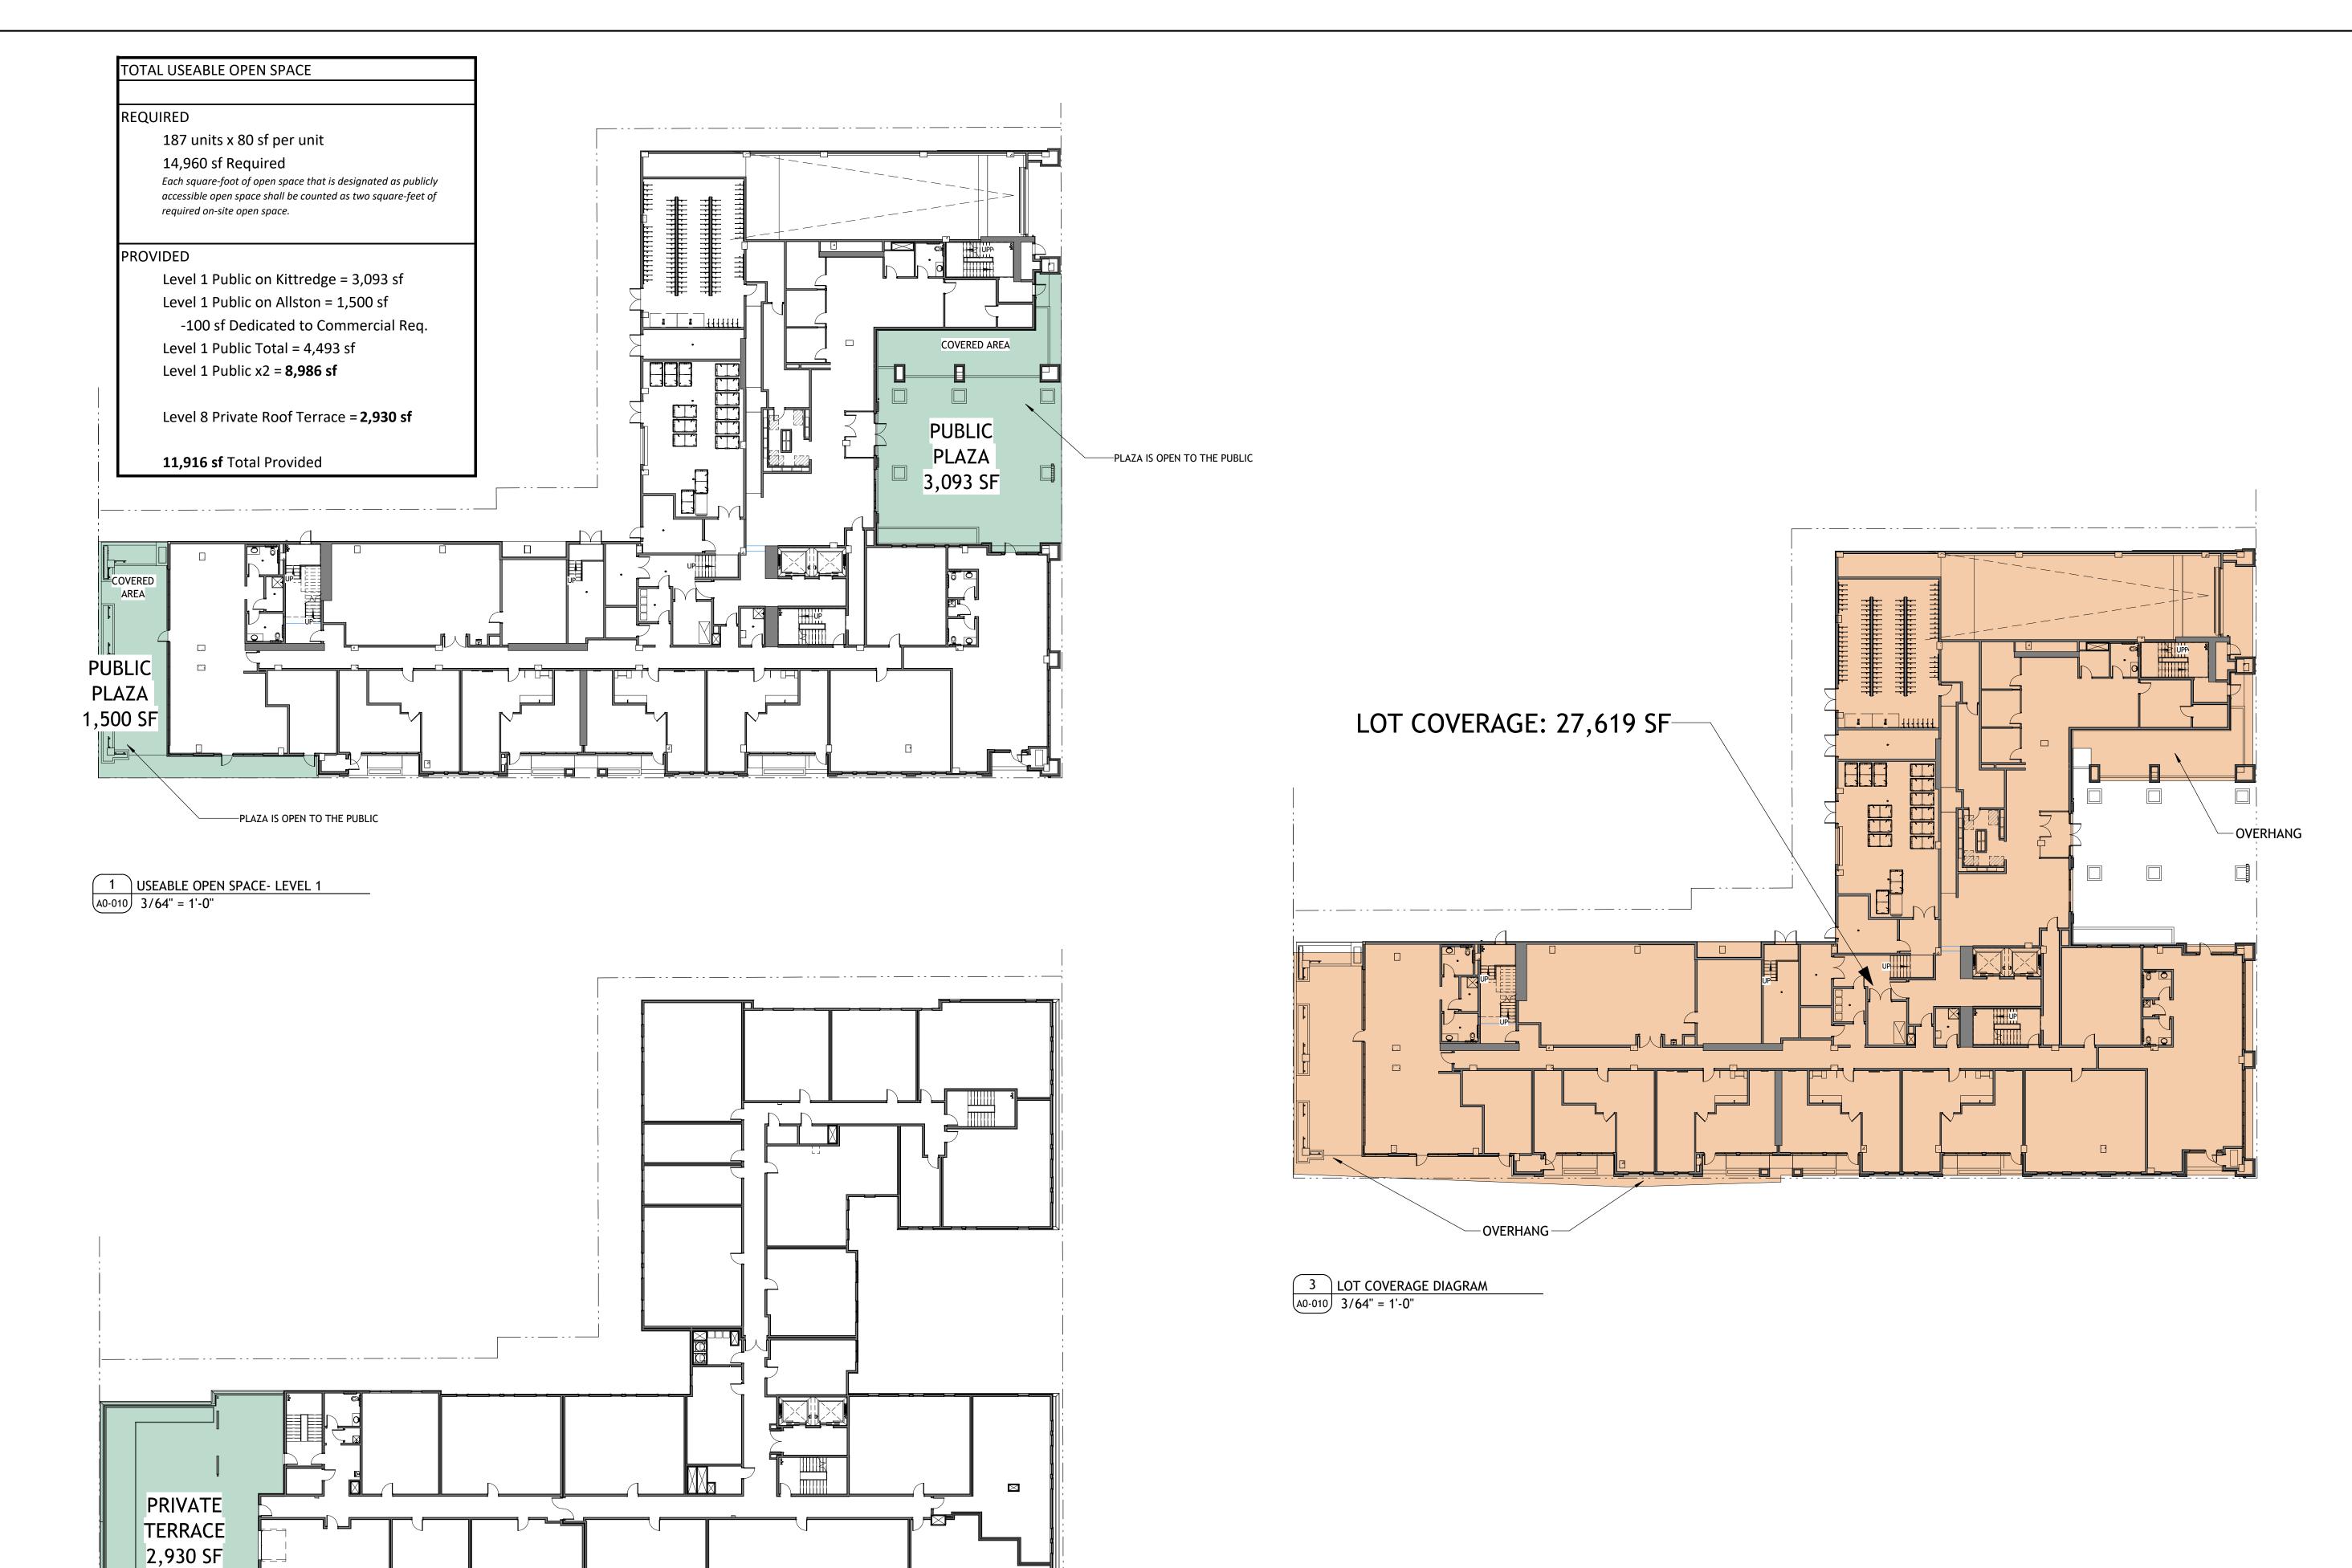
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APPLICANT:

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No.	Description	Date
D	USE PERMIT	10/25/21
Е	USE PERMIT RESUBMIT.	12/10/21
F	SAP	12/22/21
Н	USE PERMIT RESUBMIT.	3/17/22
L	USE PERMIT RESUBMIT.	3/28/22
M	APRIL DRC MEETING	4/11/22
Р	USE PERMIT RESUBMIT.	08/22/22


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SHEET TITLE:

SITE DIAGRAMS

SHEET NUMBER:



PROJECT #: 121246

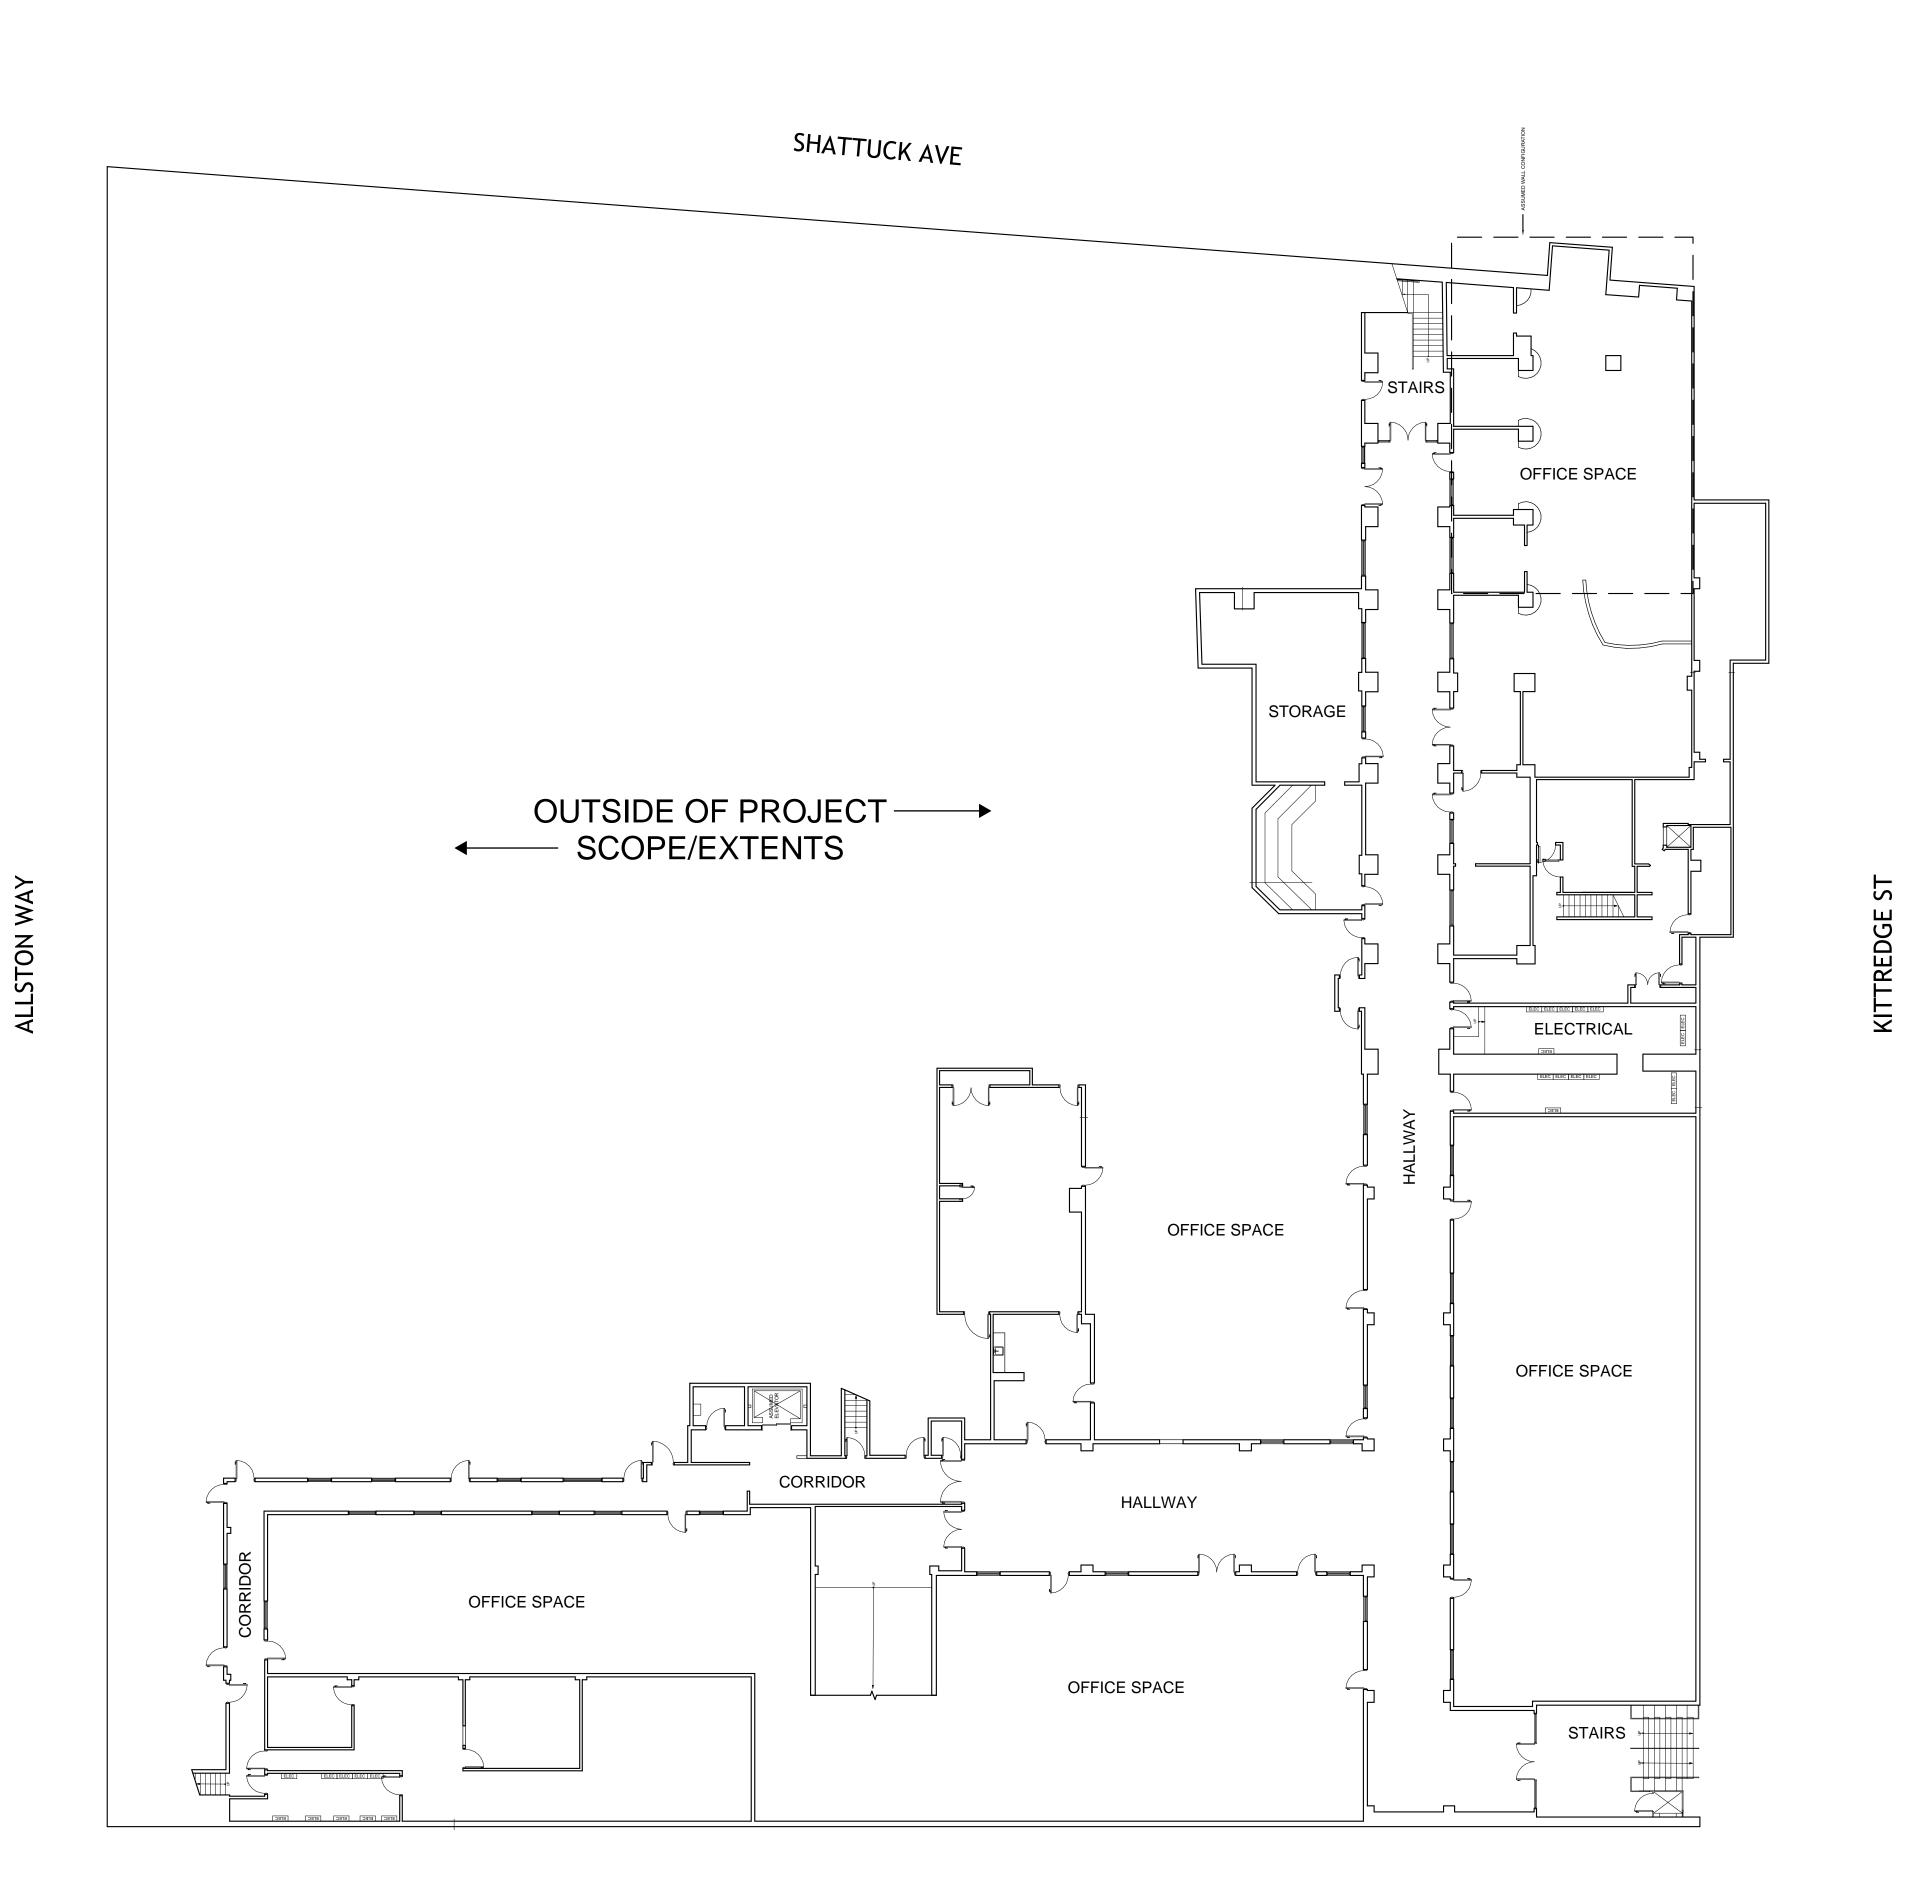DRAWN BY: TF

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NILES BOLTON ASSOCIATES

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www.nilesbolton.com

APPLICANT:

BILL SCHRADER

T 925 638 8782

No.	Description	Date
9	SAP RESUBMIT.	3/23/22
13	JUNE LMRKS. MEETING	5/10/22

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SHEET TITLE:


SITE PLAN
EXISTING- LEVEL U1

SHEET NUMBER:

A1-001

BASEMENT PLAN

EXISTING

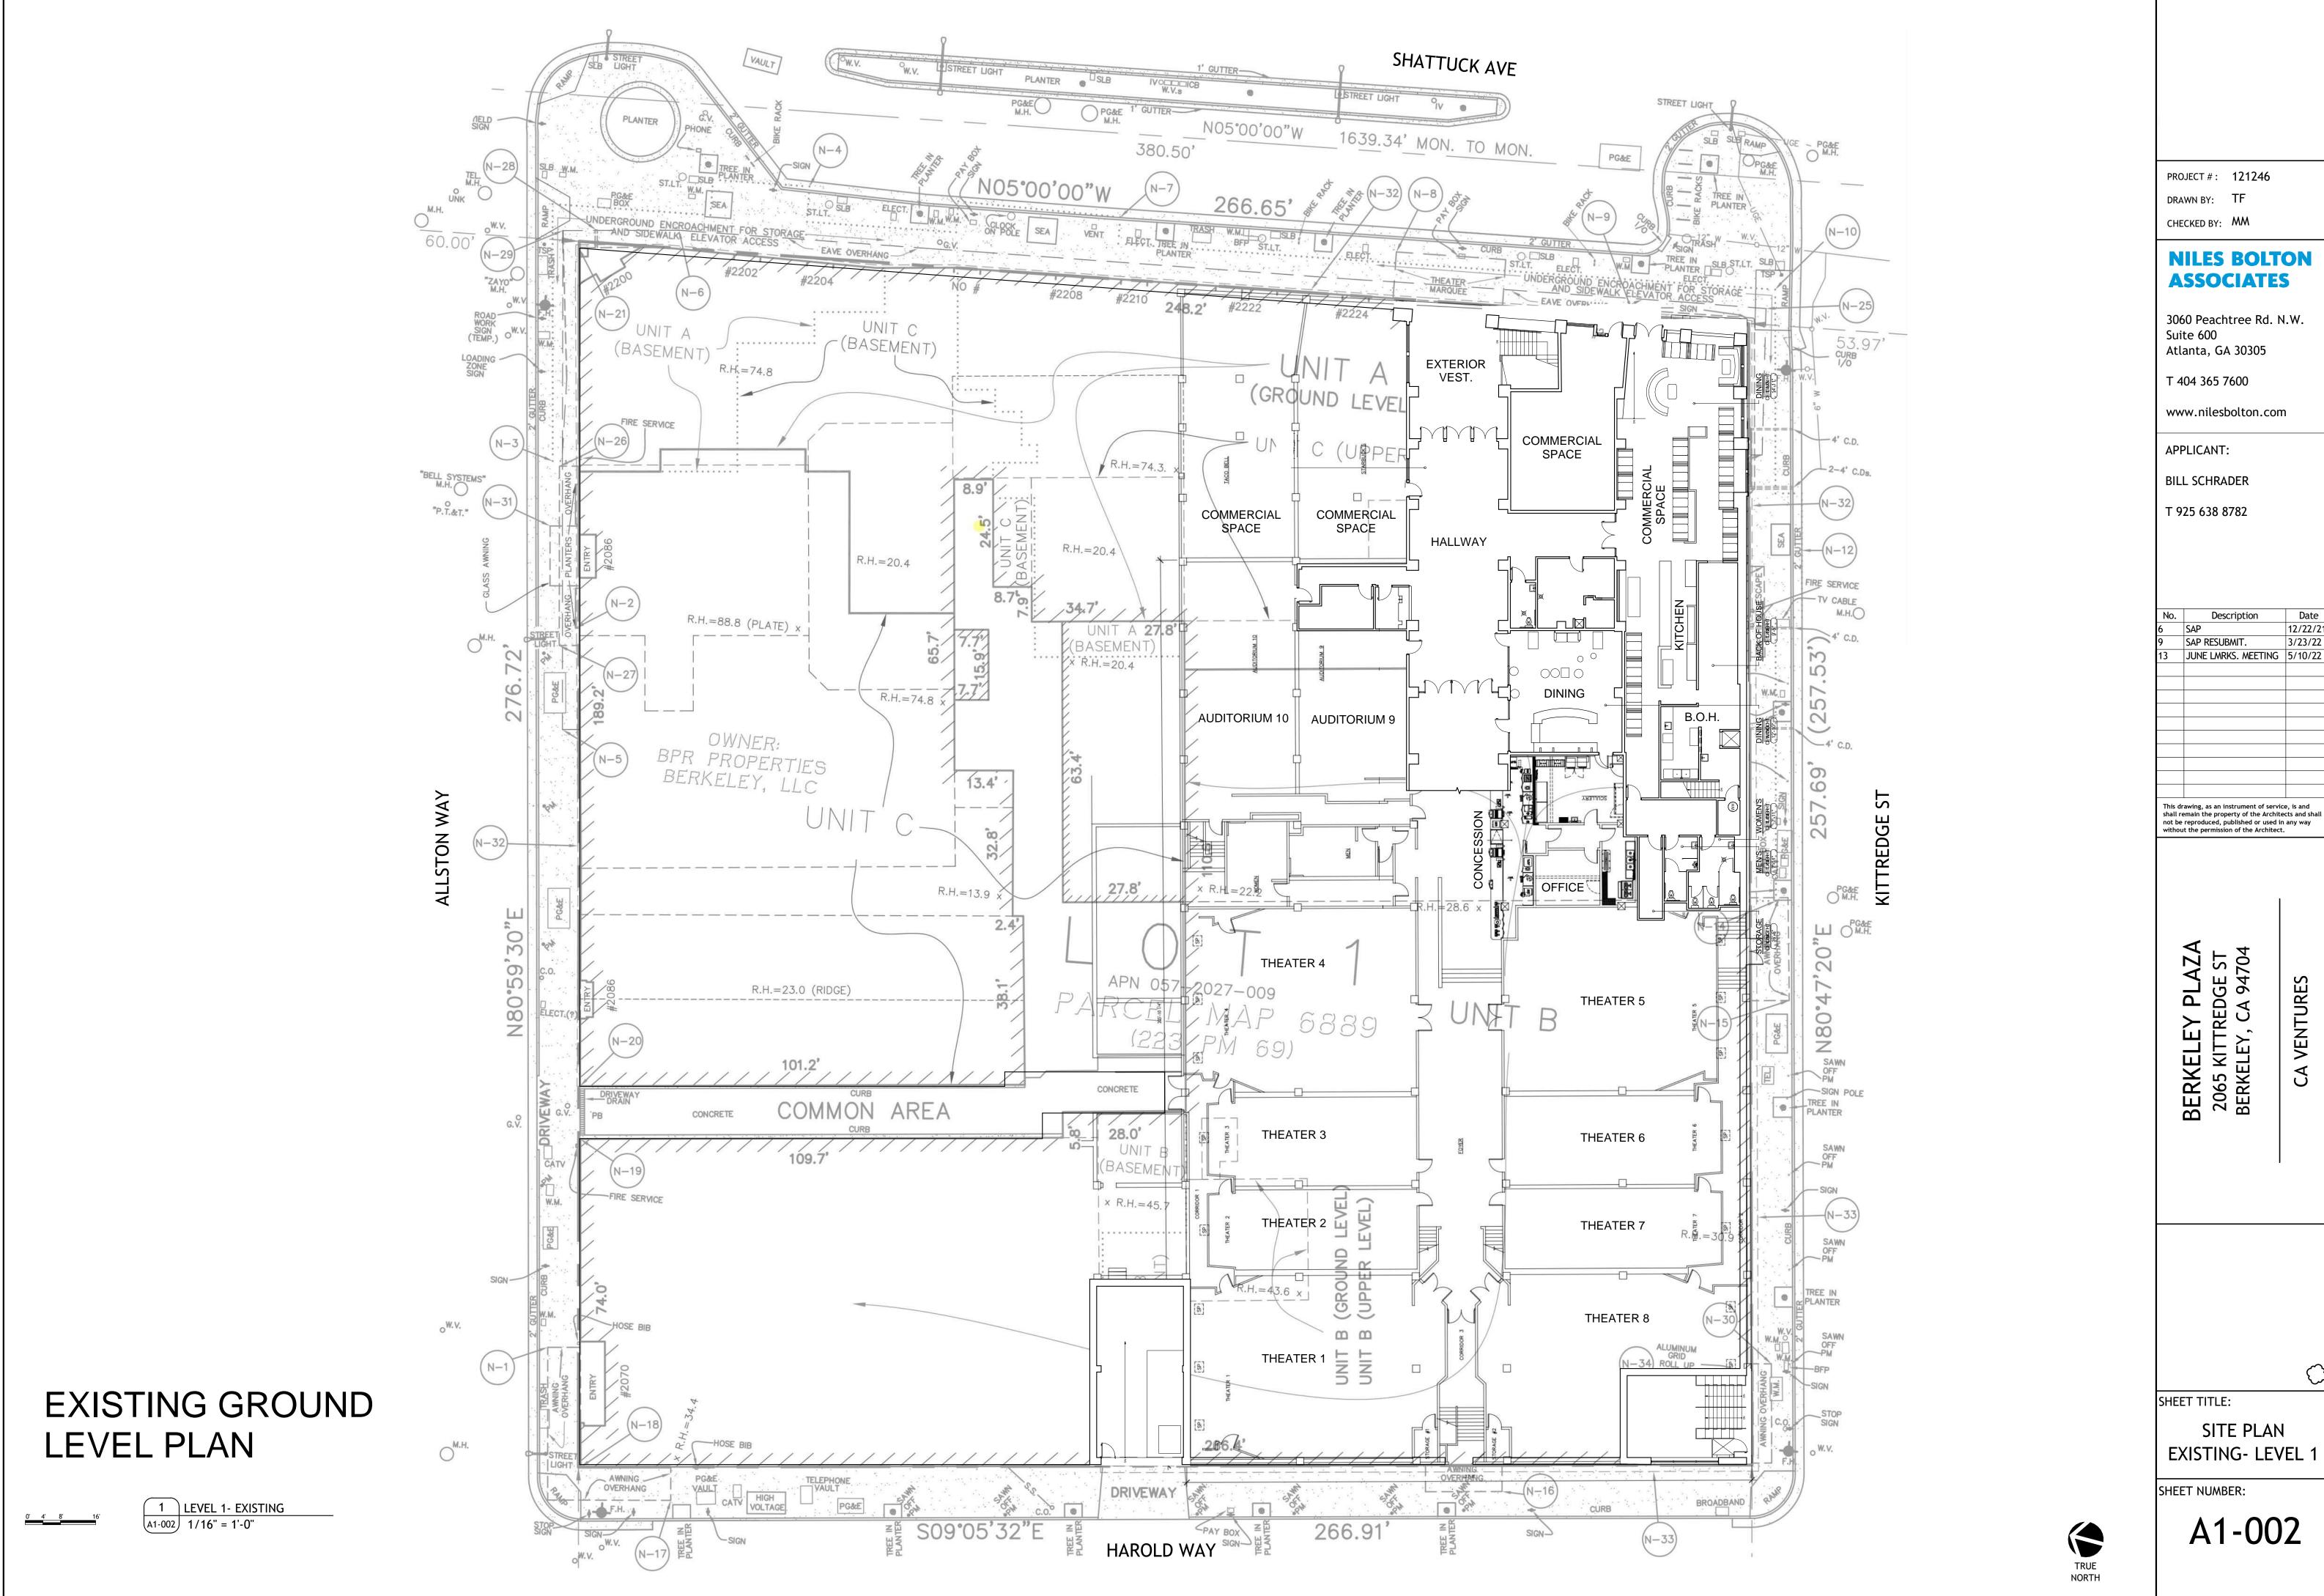

12/22/21

SHATTUCK AVE

OUTSIDE OF PROJECT → STORAGE ◆ SCOPE/EXTENTS 21 22 23 24 25 26 27 23 CAR STACKER SYSTEM 5 ELECTRIC SPACE 15 _30<u>__</u>31__ <u>32</u> <u>33</u> **34 35** <u>[</u>36] <u>[</u>37] _38**__**39 **_**40**_ _**41**_** TOTAL PARKING 43 SPACES **42 43** 12 MECH UNIT AREA

PROJECT #: 121246

DRAWN BY: TF

CHECKED BY: MM

NILES BOLTON

ASSOCIATES

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APPLICANT:

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No.	Description	Date
9	SAP RESUBMIT.	3/23/22
13	JUNE LMRKS. MEETING	5/10/22
15	STAFF REVIEW #2	07/13/22

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CA VENTURES

SHEET TITLE:
SITE PLAN
PROPOSED- LEVEL

SHEET NUMBER:

A1-003


PROPOSED BASEMENT PLAN


0' 4' 8' 16'

1 LEVEL U1- PROPOSED A1-003 1/16" = 1'-0"

HAROLD WAY


TRUE

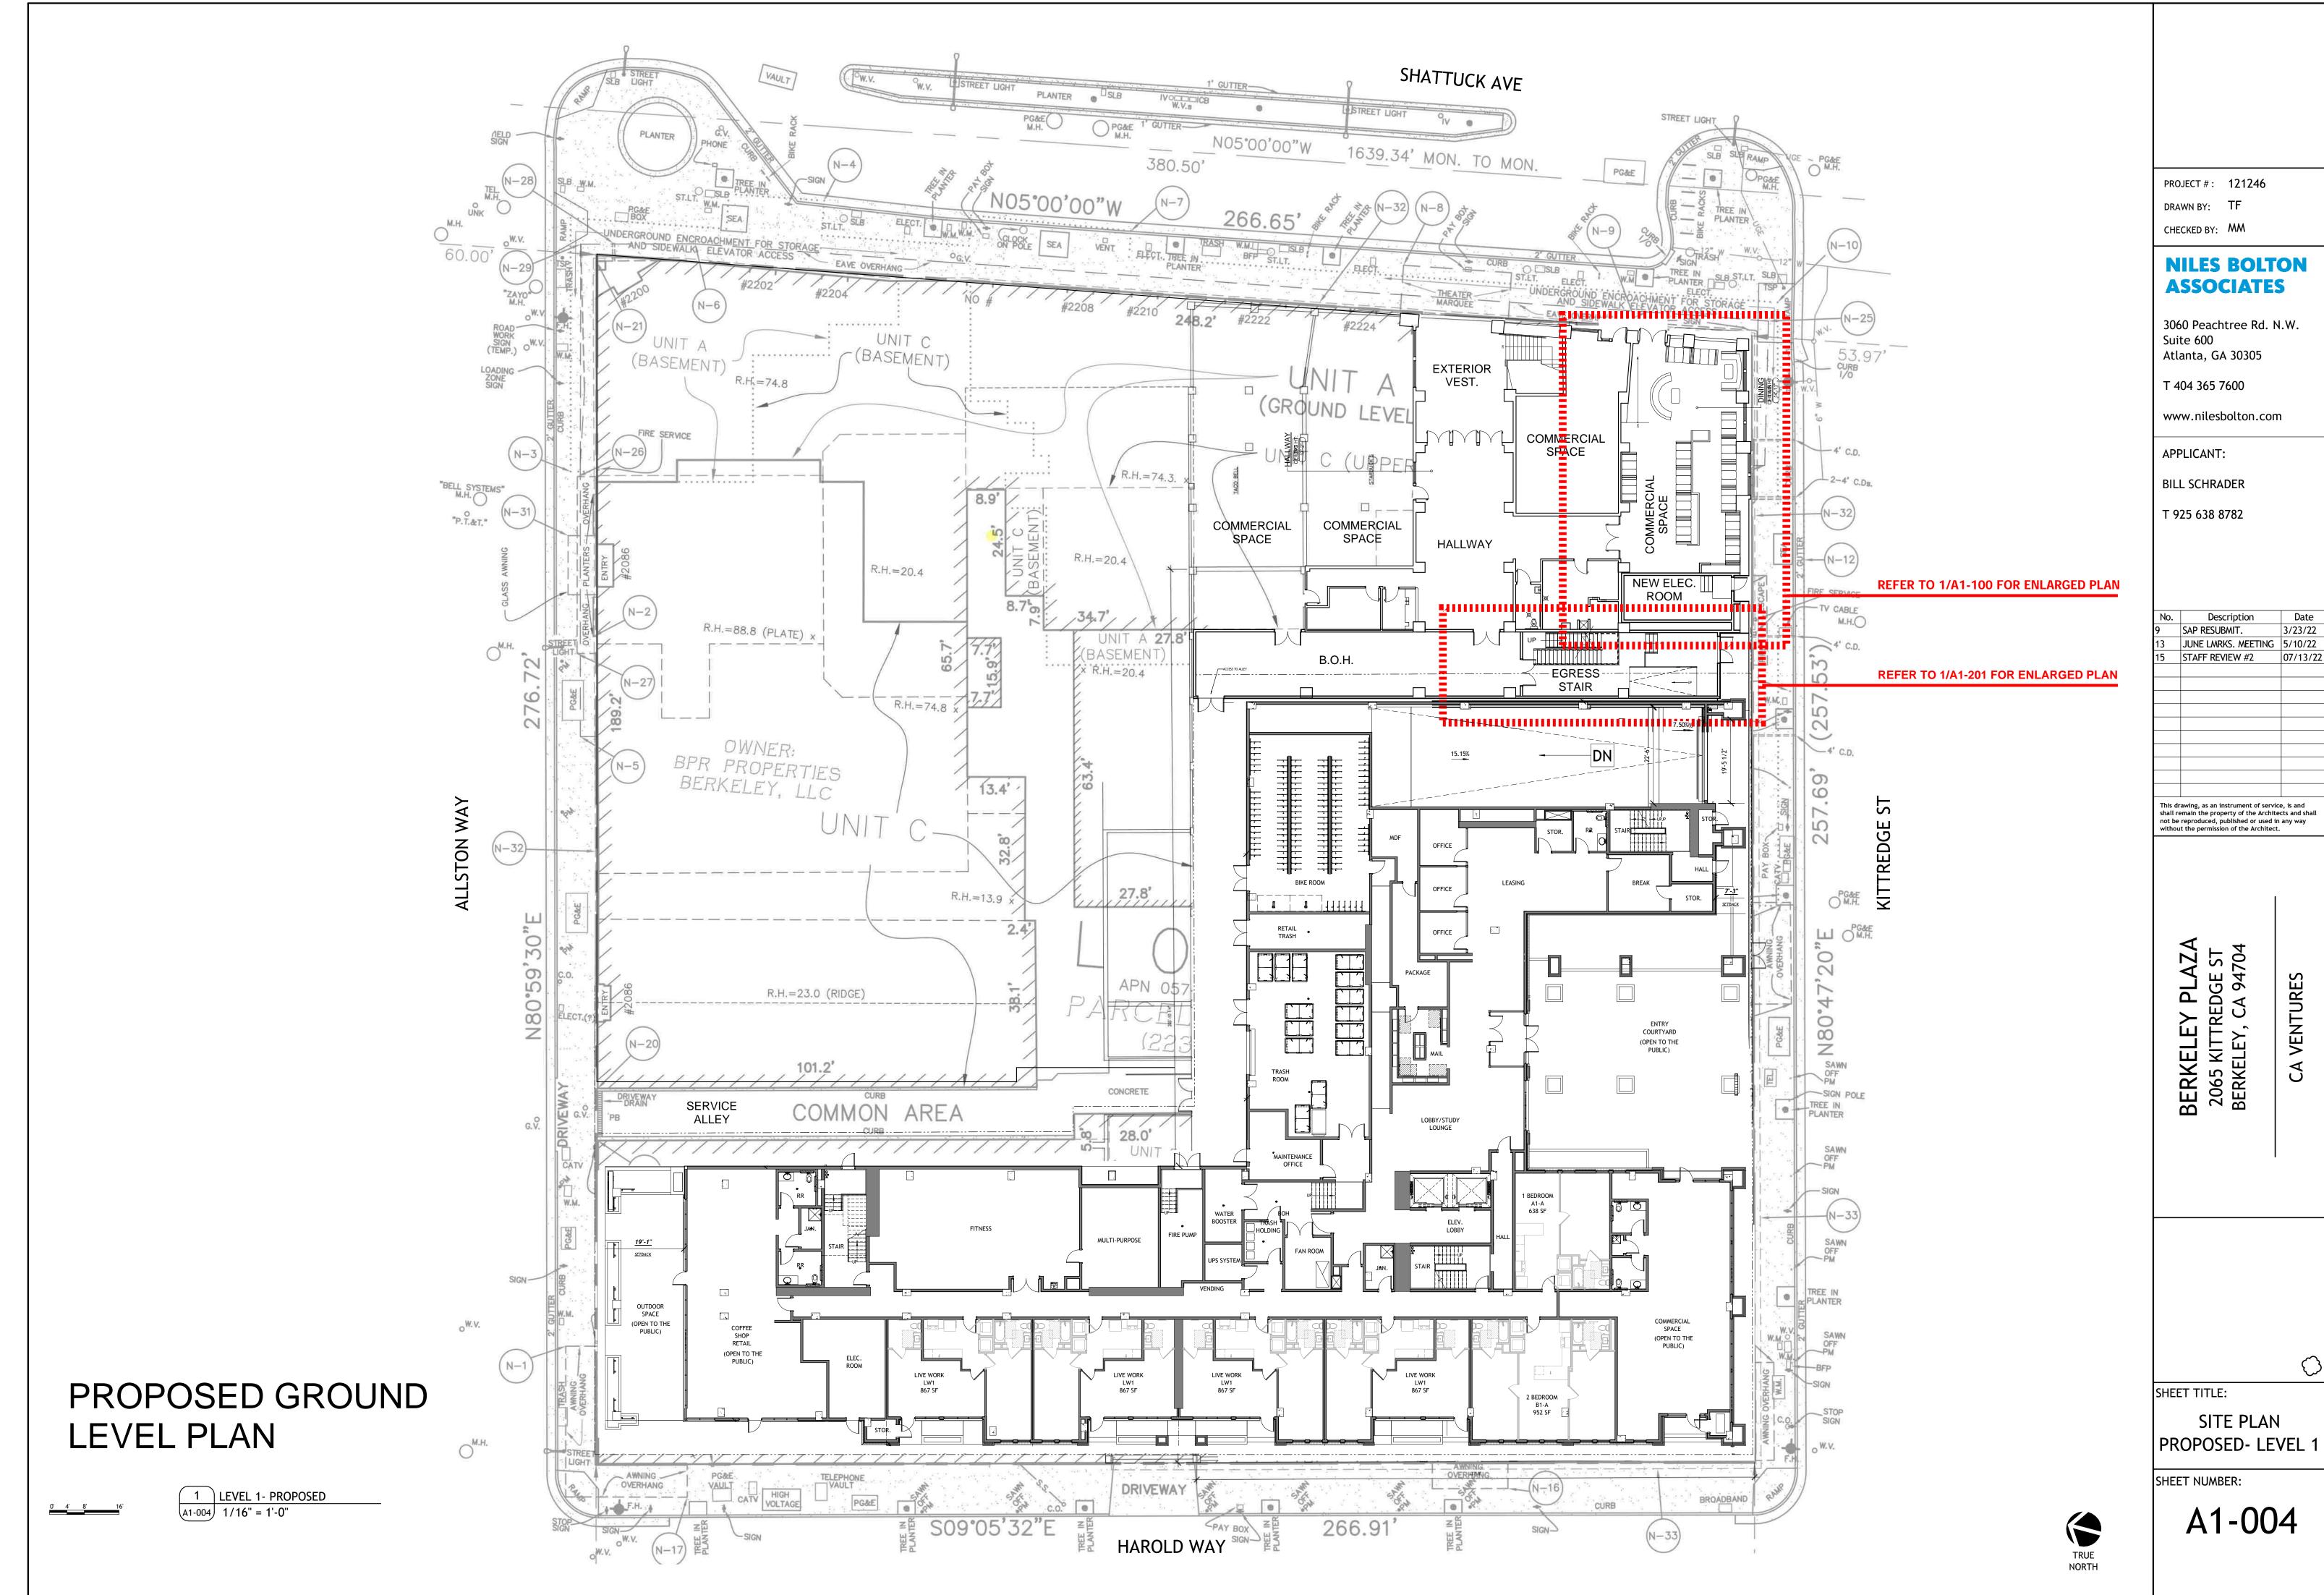

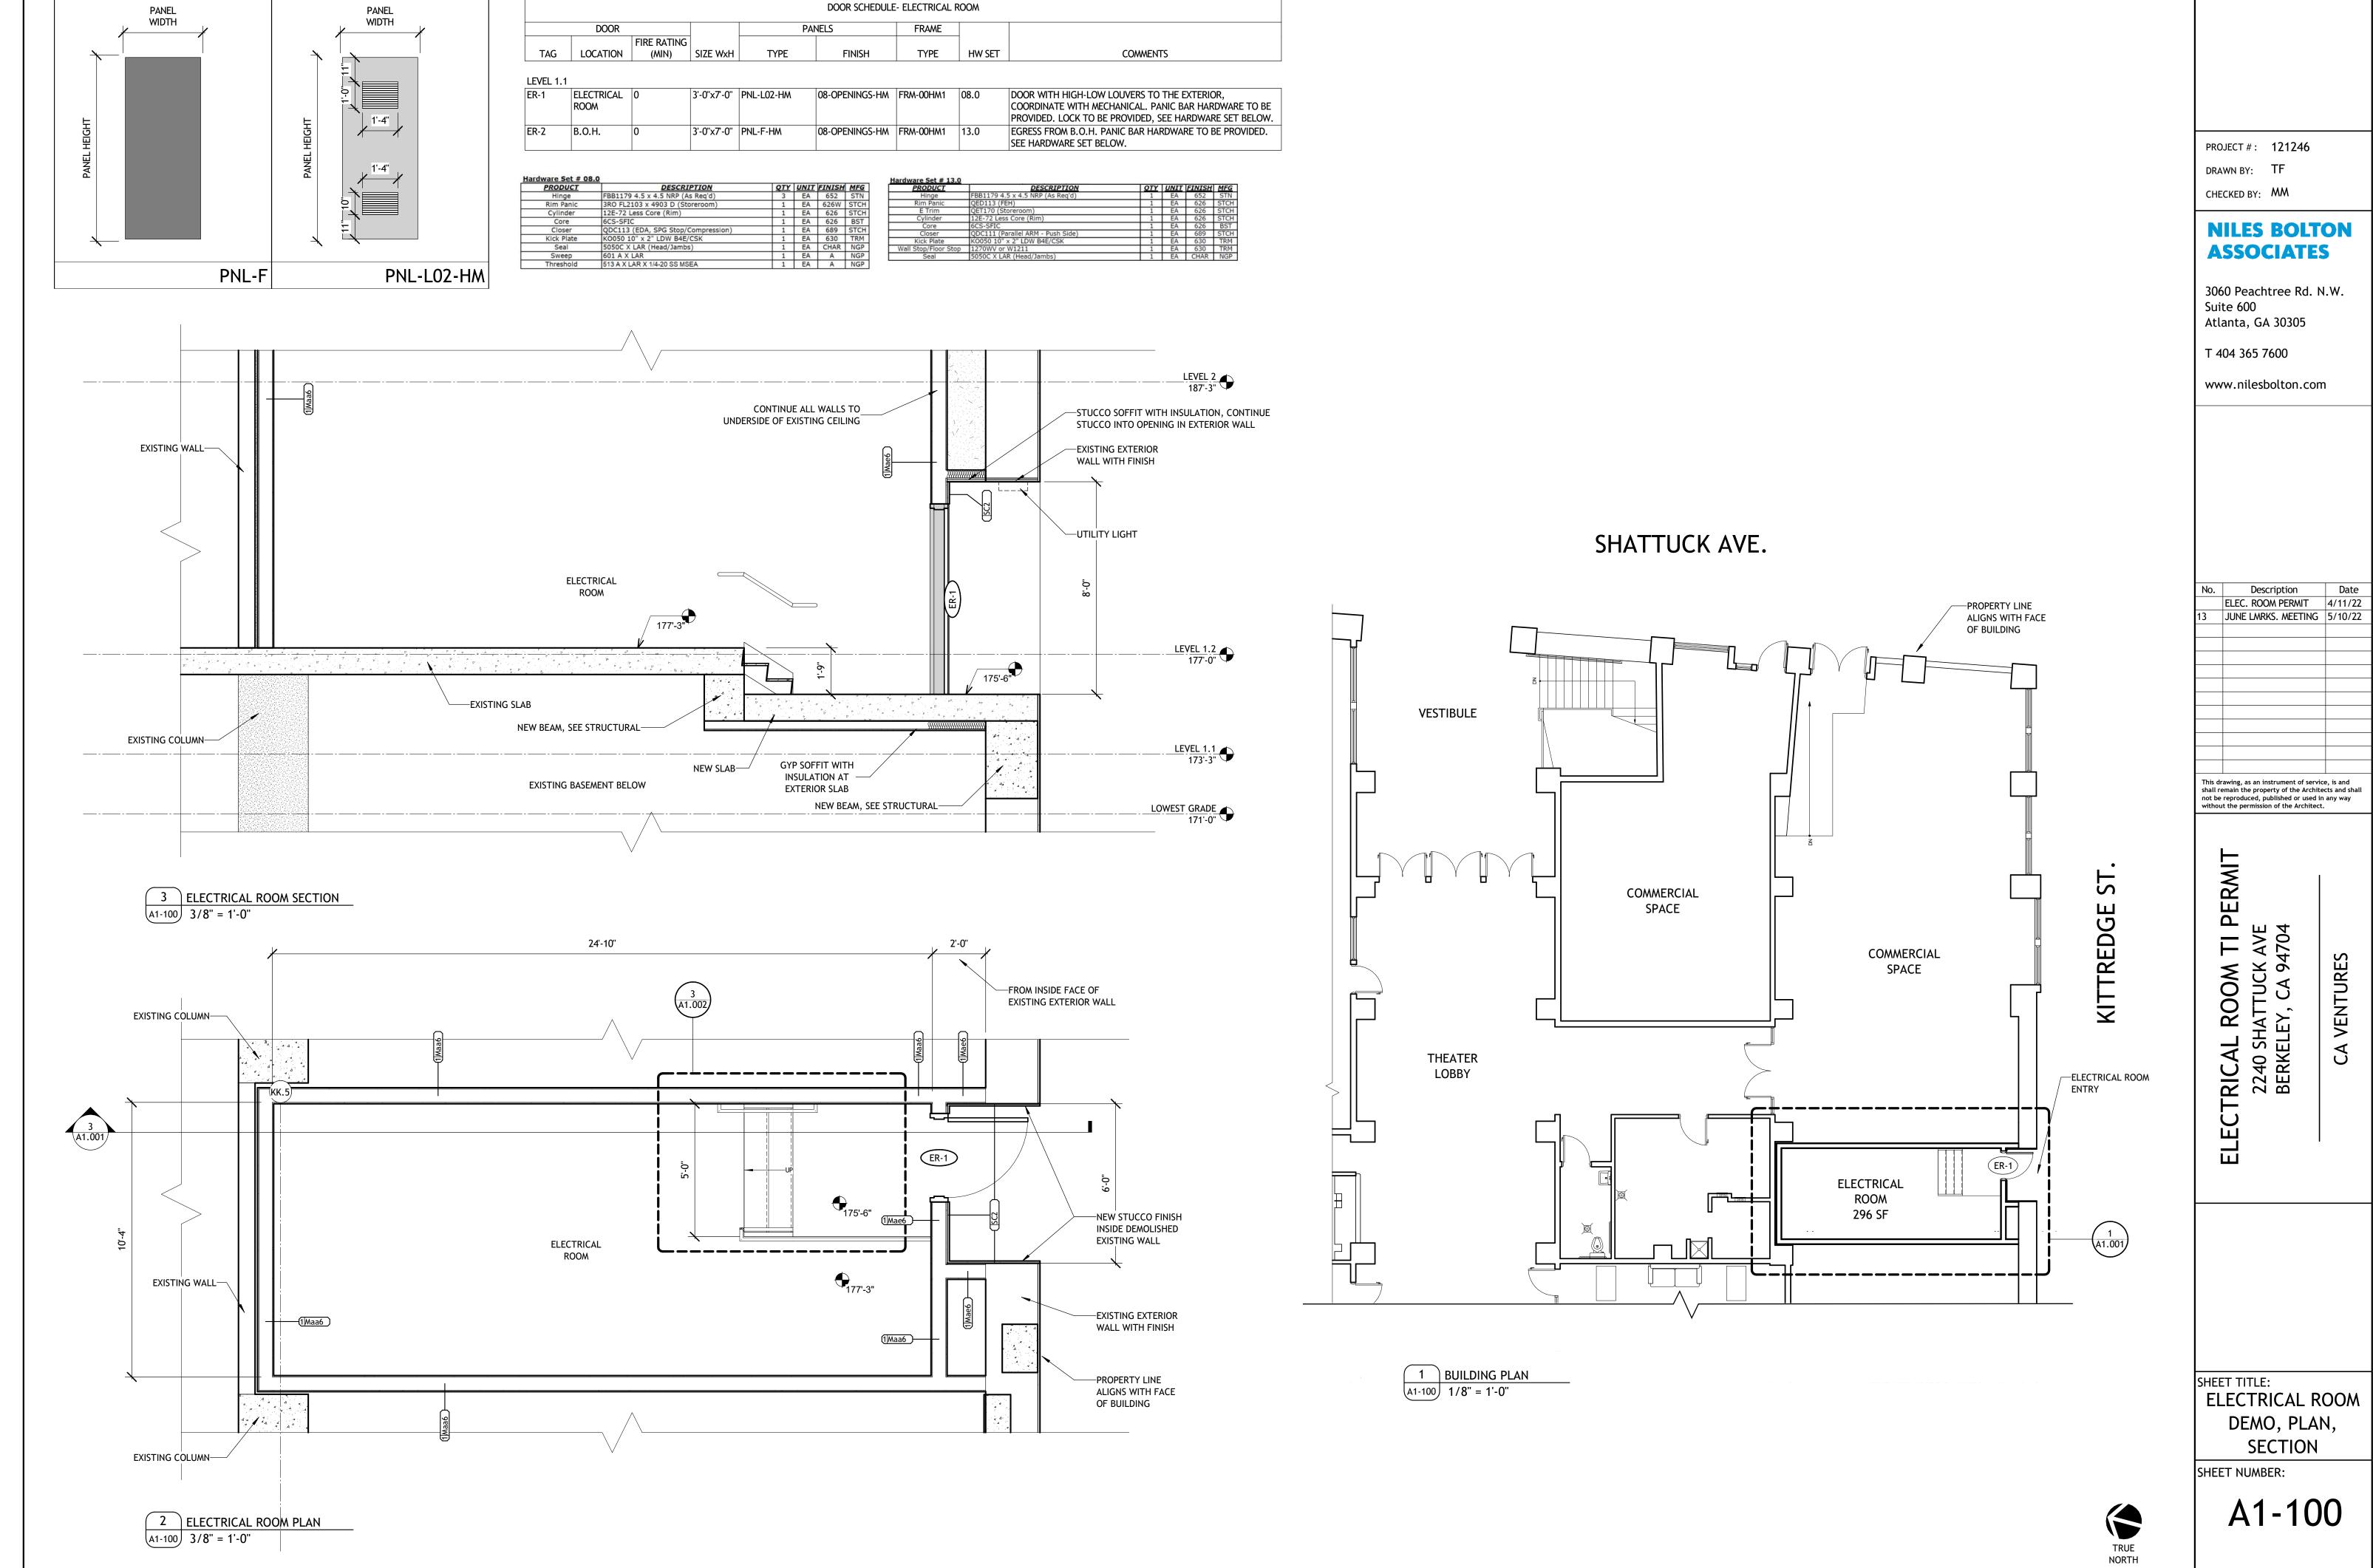

ELEC. ROOM PERMIT 4/11/22 JUNE LMRKS. MEETING 5/10/22

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PROJECT #: 121246

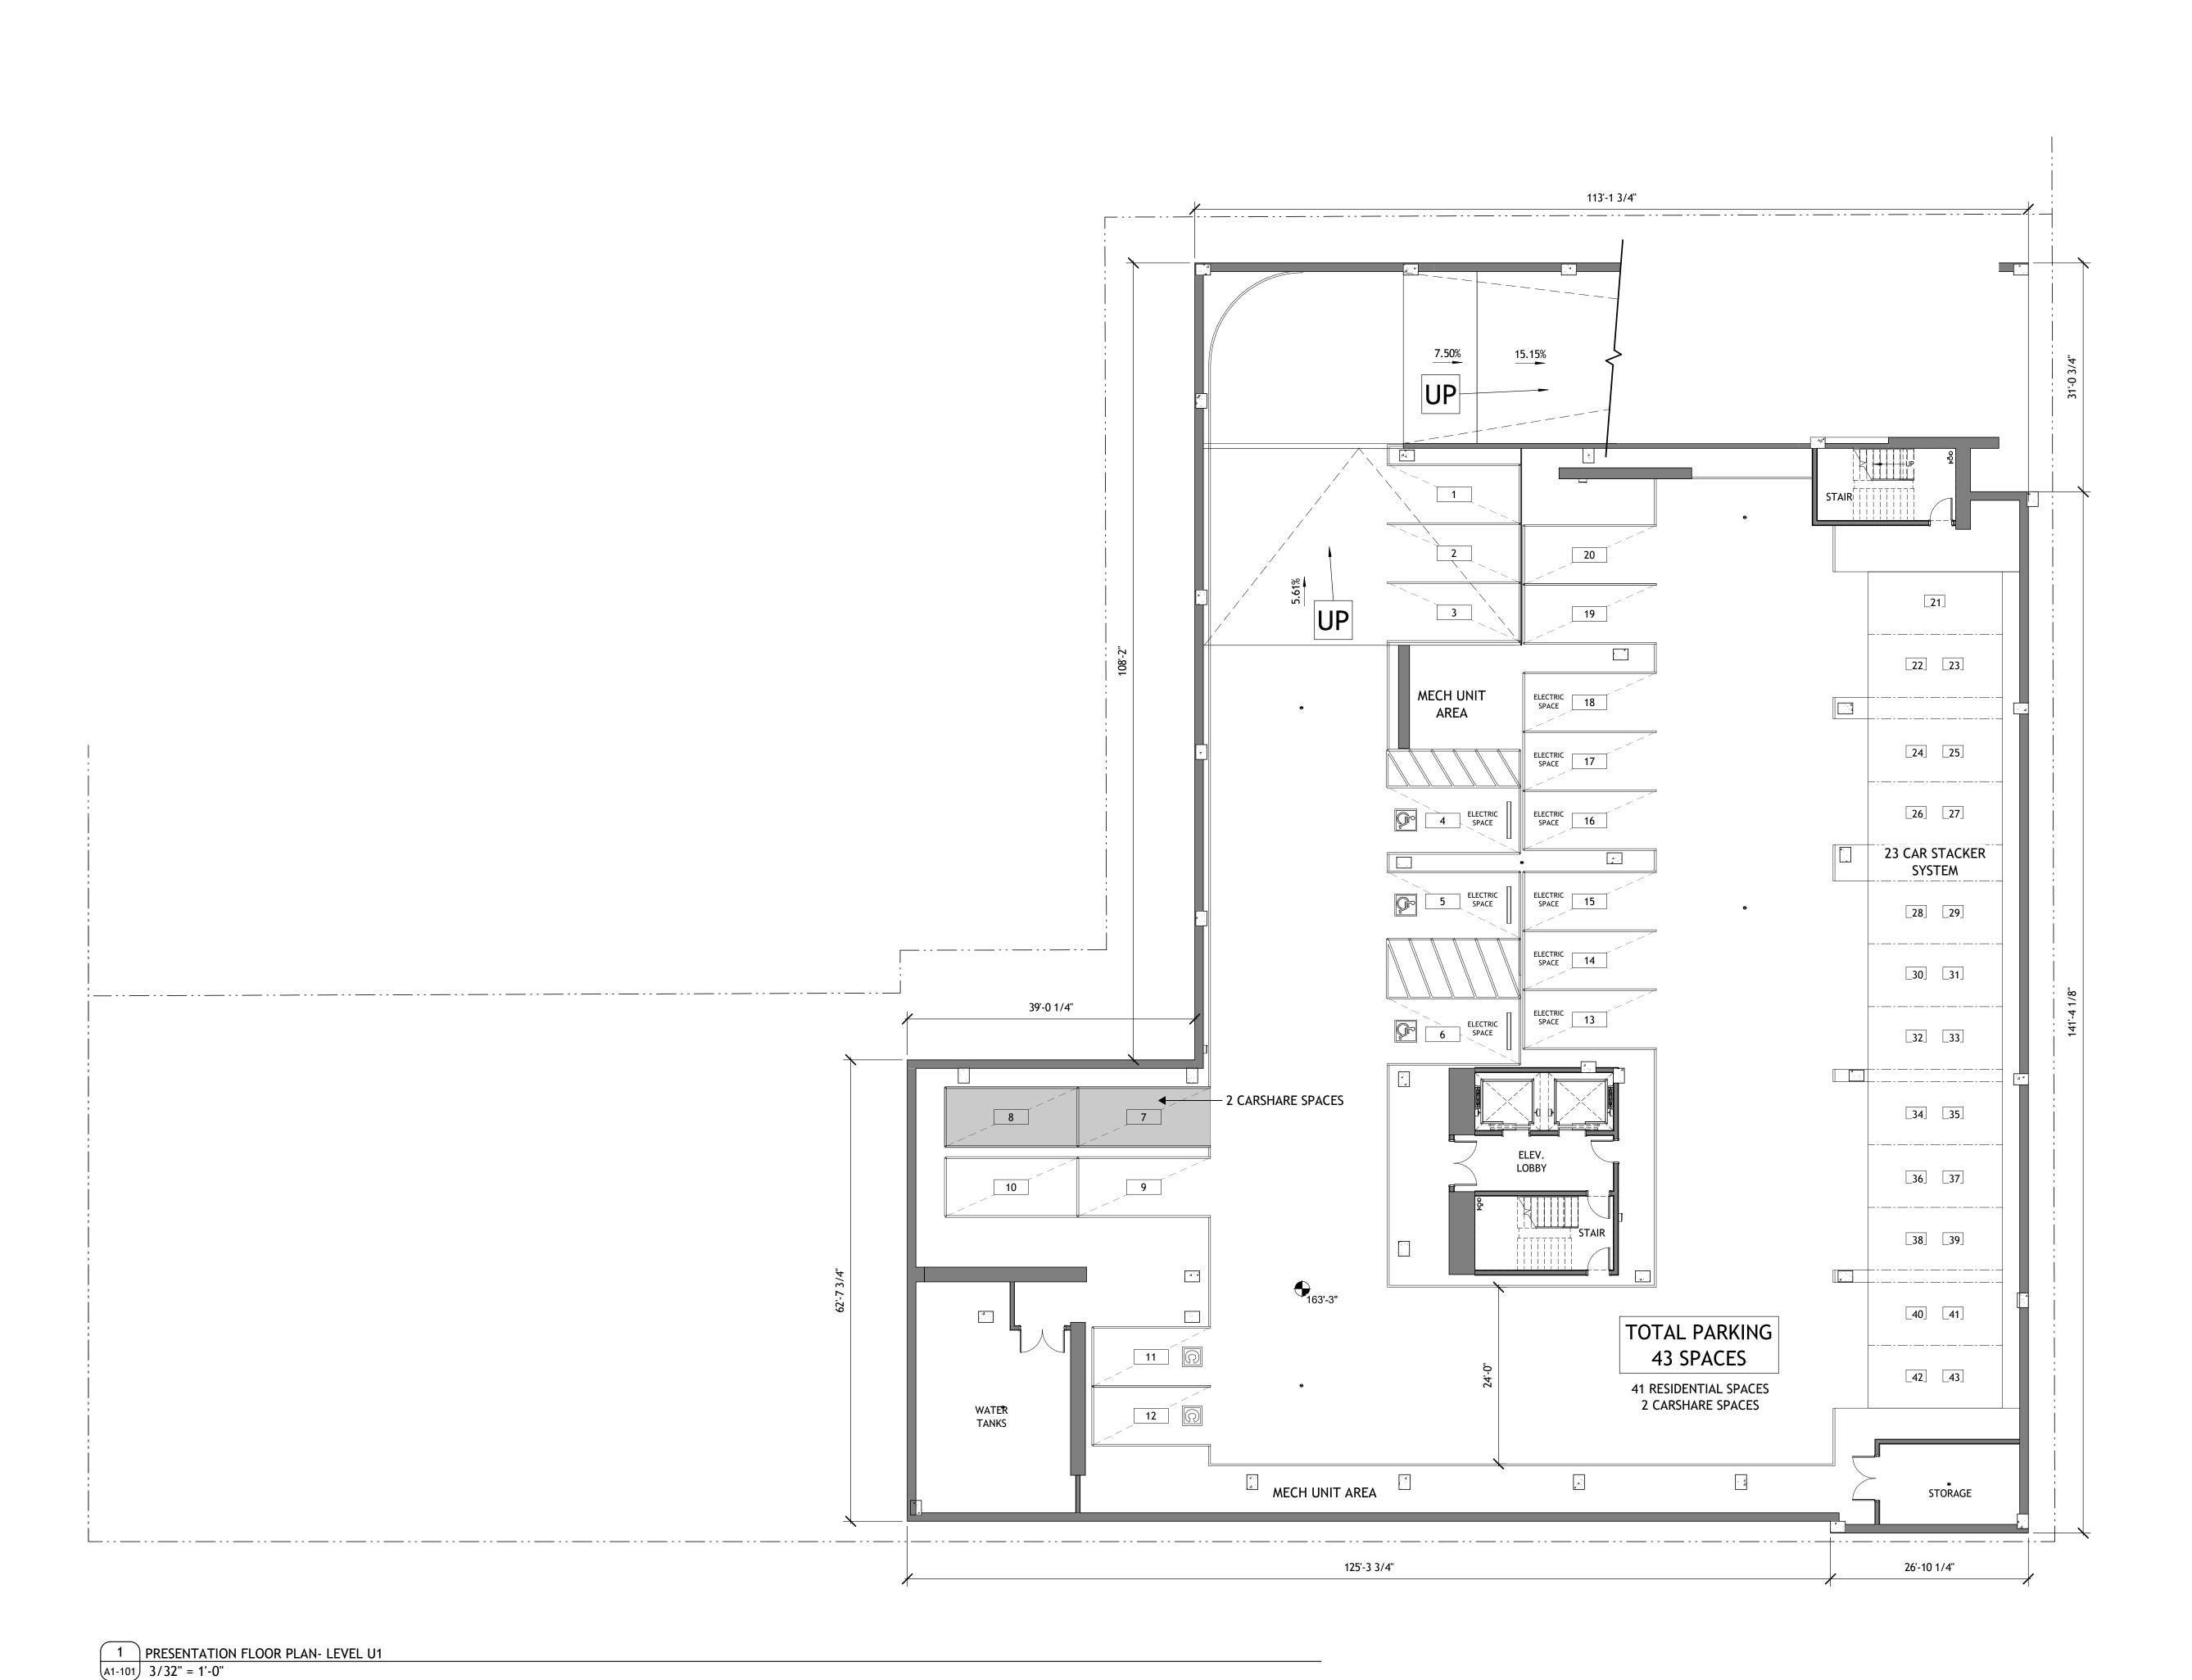DRAWN BY: TF

CHECKED BY: MM

NILES BOLTON ASSOCIATES

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APPLICANT:

BILL SCHRADER
T 925 638 8782

No.	Description	Date
	PLAN UPDATE	6/28/21
	PRELIM APP SB330	7/21/21
	SD SET	9/16/21
	USE PERMIT	10/25/21
	USE PERMIT RESUBMIT.	12/10/21
	SAP	12/22/21
	USE PERMIT RESUBMIT.	3/17/22
	SAP RESUBMIT.	3/23/22
	USE PERMIT RESUBMIT.	3/28/22
	APRIL DRC MEETING	4/11/22
	JUNE LMRKS. MEETING	5/10/22
	STAFF REVIEW	07/01/22
	USE PERMIT RESUBMIT.	08/22/22

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CA STUDENT LIV


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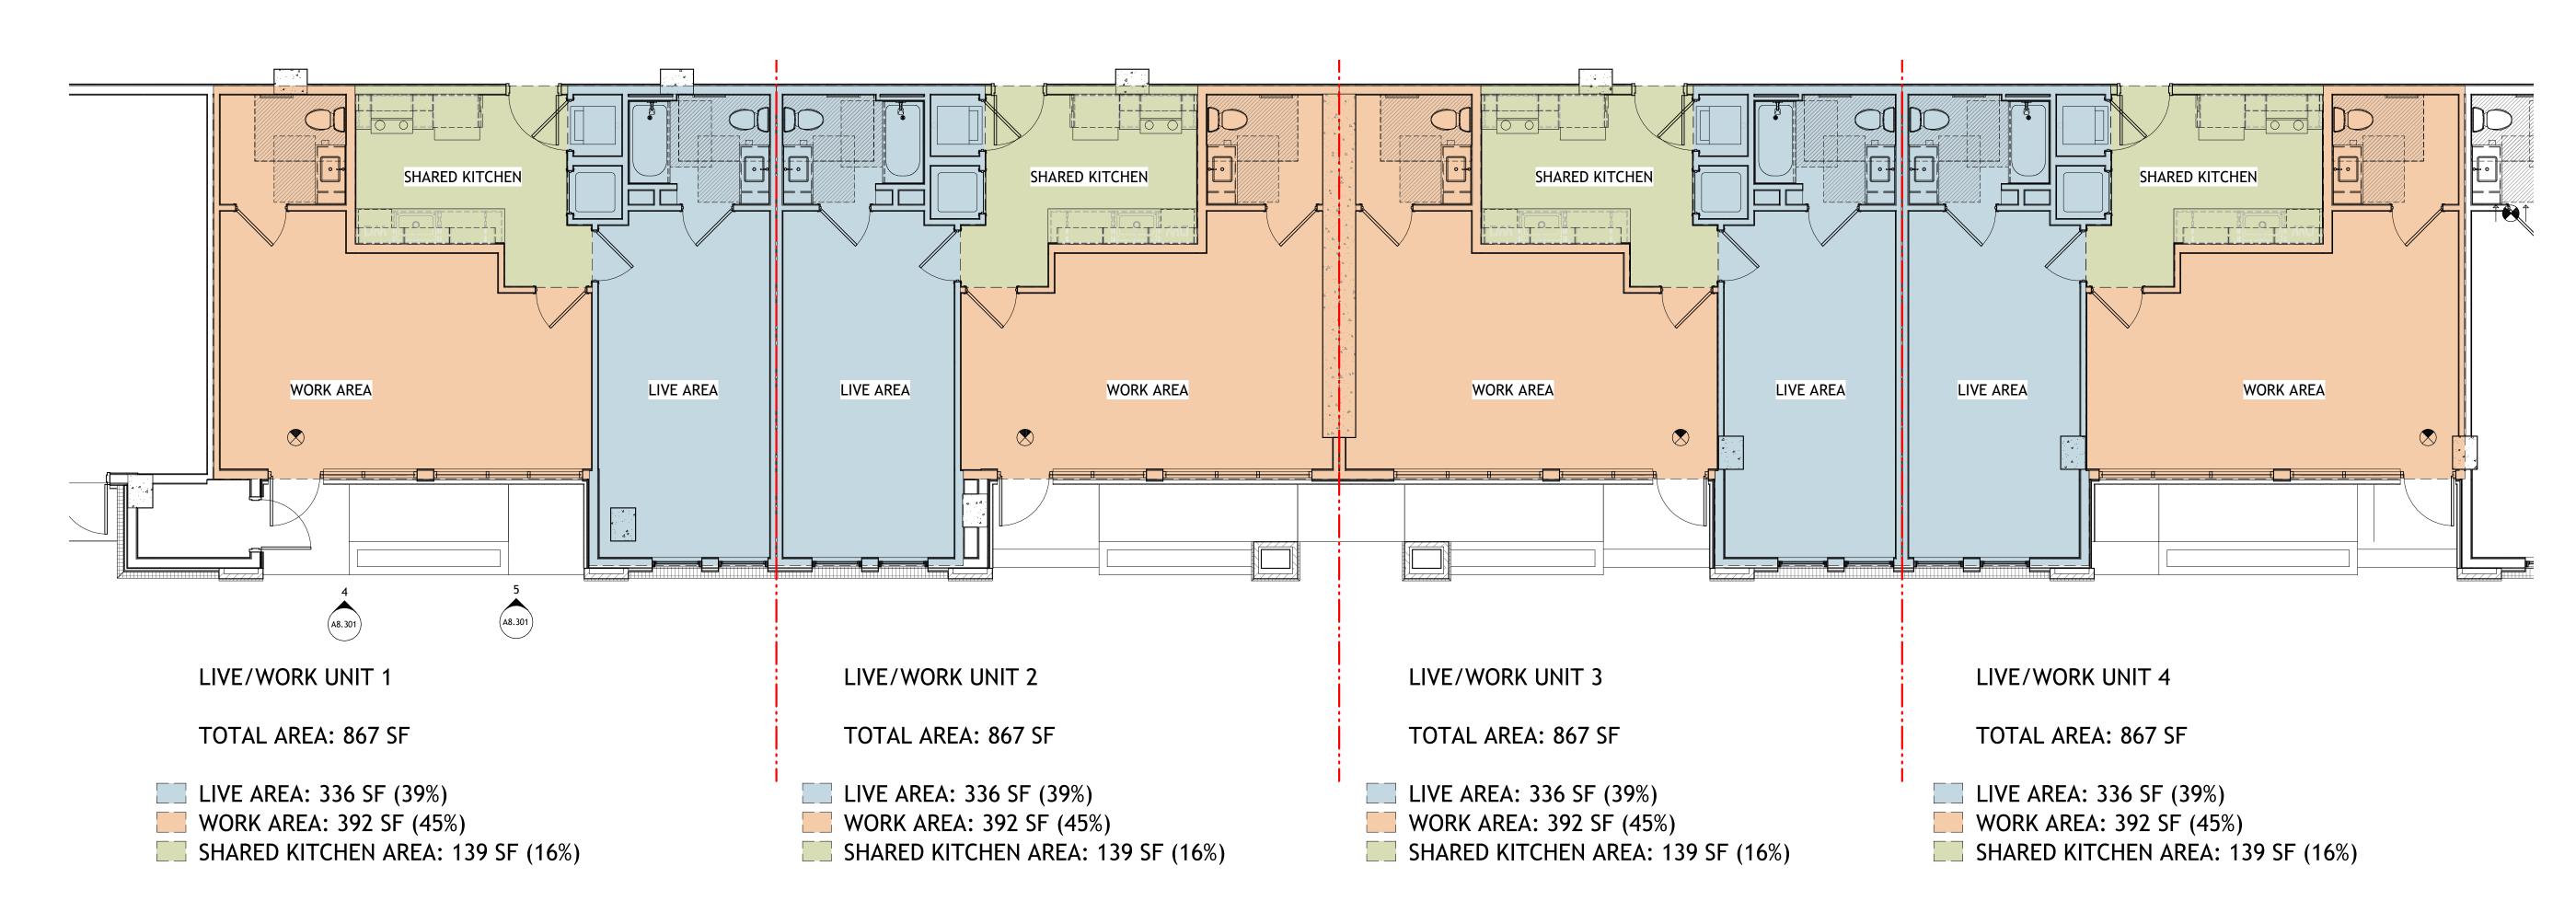
PLAN- LEVEL U1

SHEET NUMBER:

A1-101

TRUE NORTH



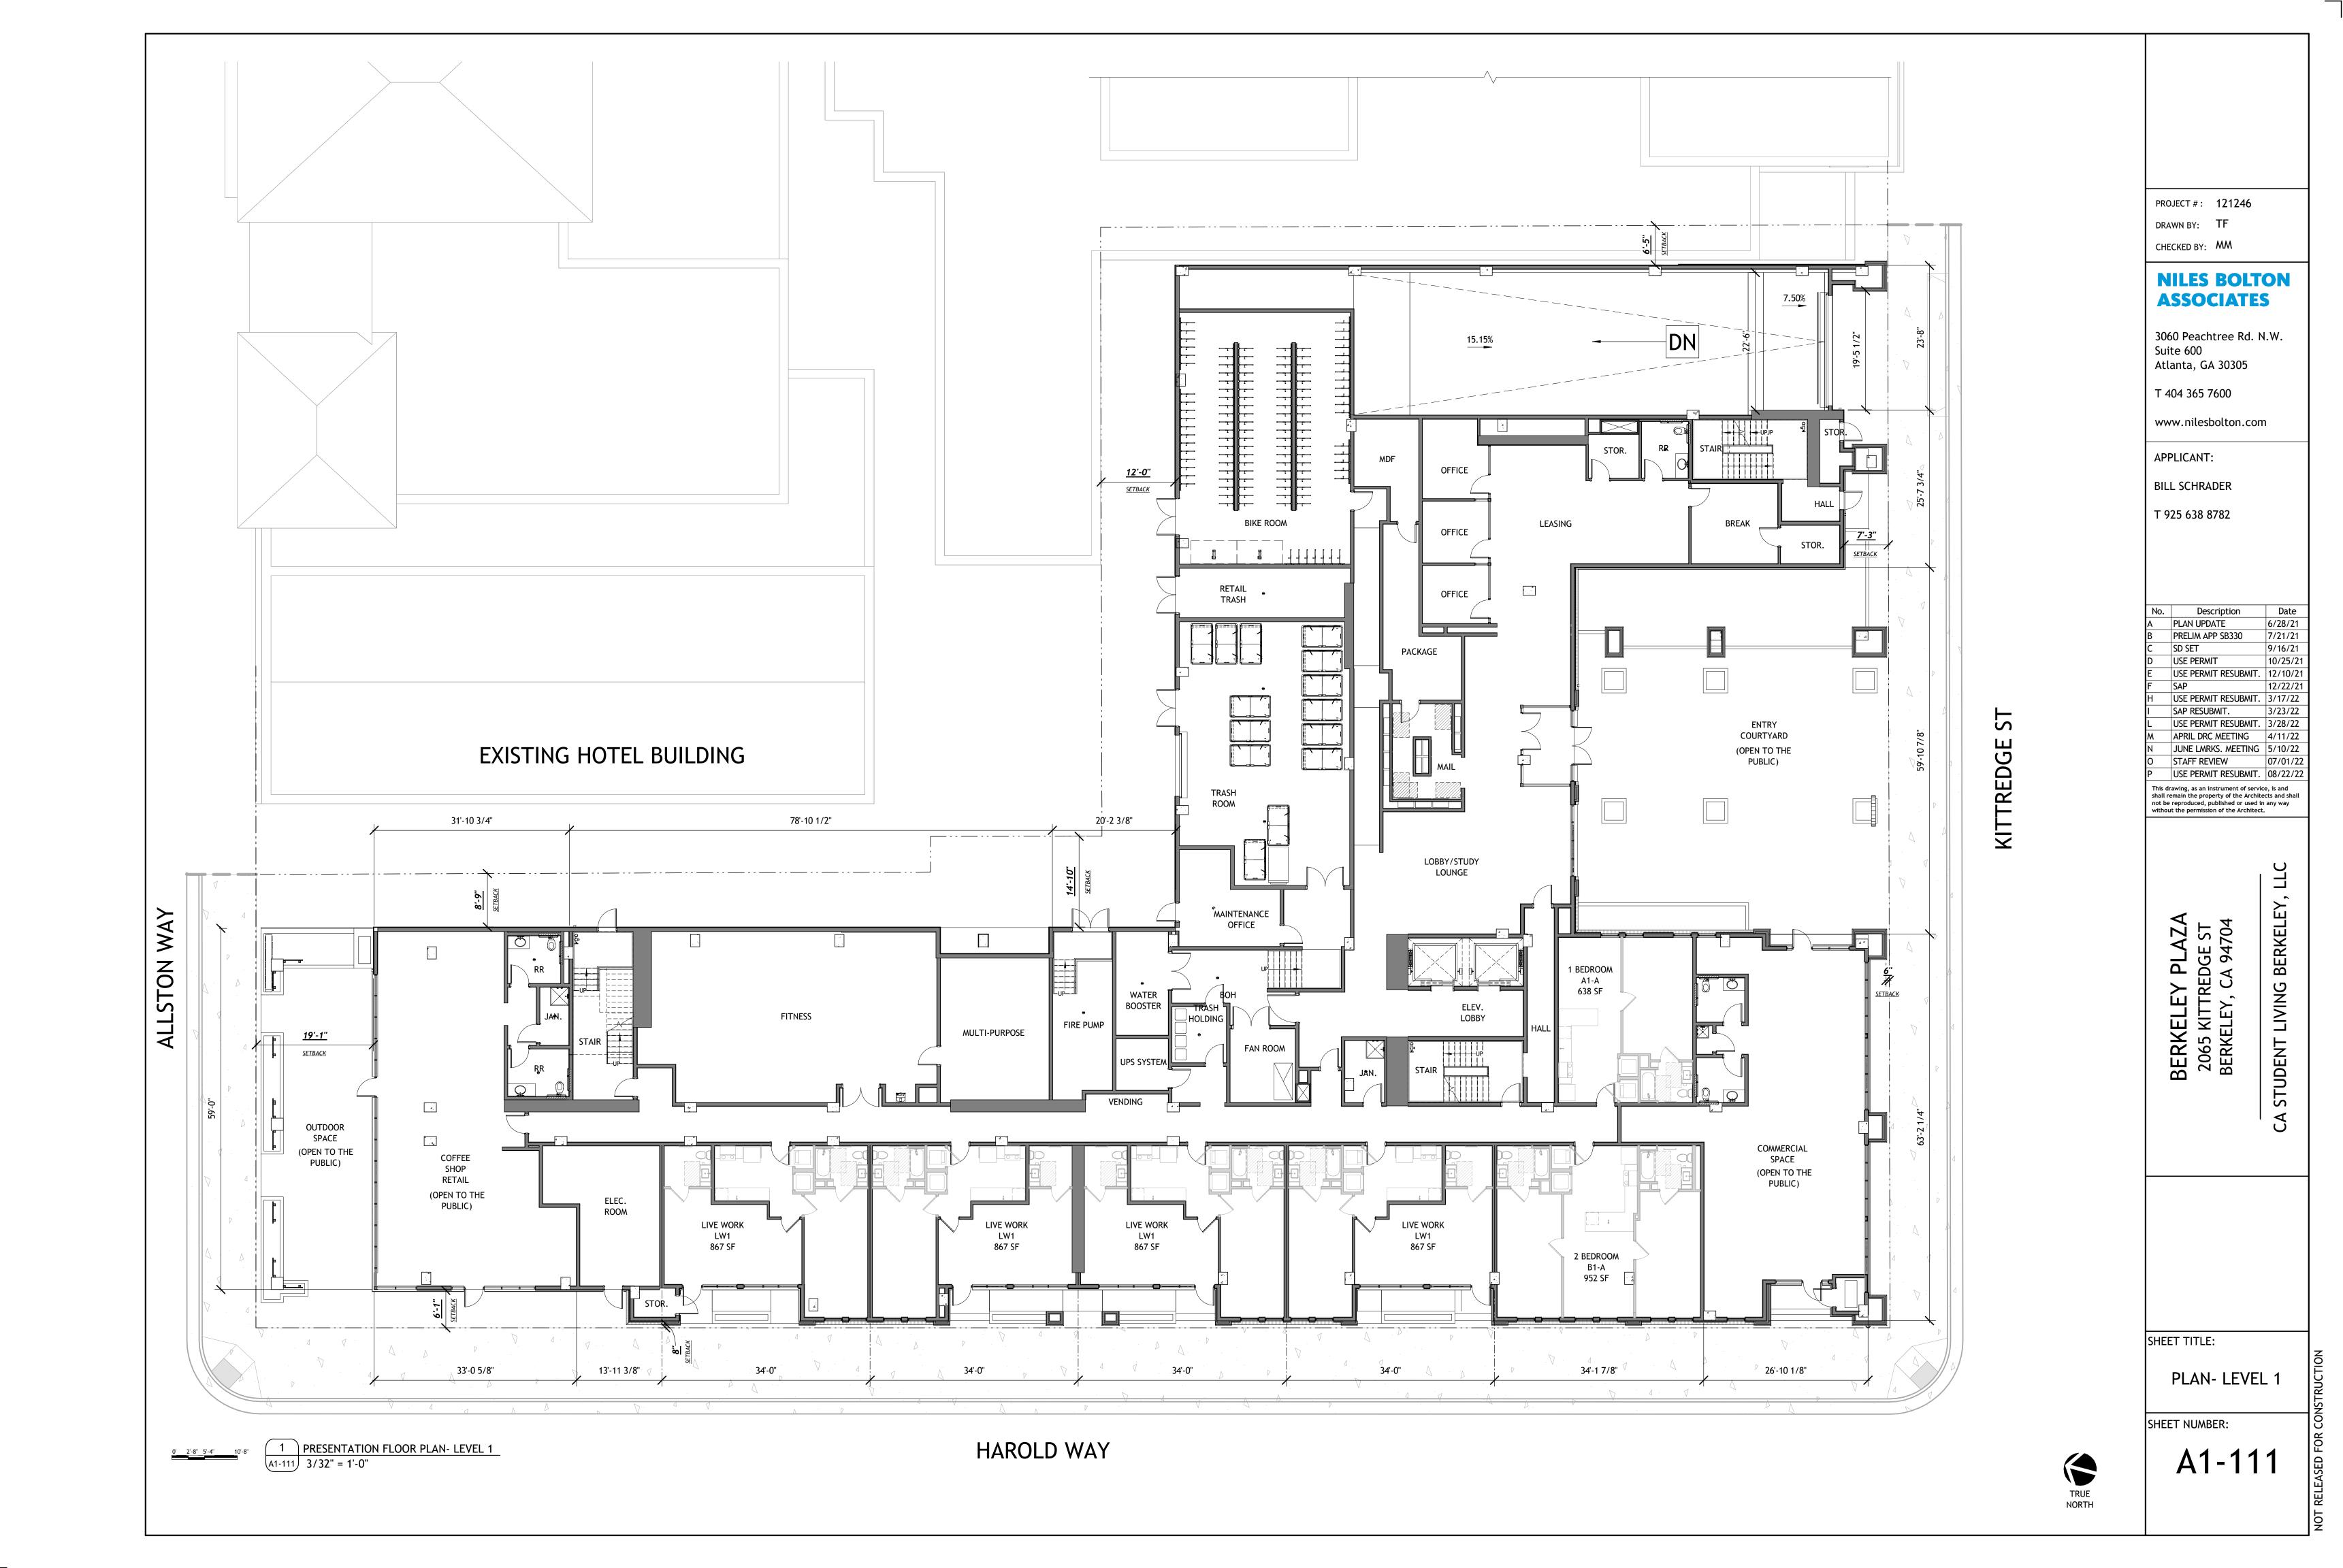

NOTE: THE KITCHEN IS CONSIDERED SPACE THAT SERVES BOTH THE LIVE AREA AND THE WORK AREA OF THE UNIT. THE SHARED AREA OF THE KITCHEN IS SPLIT BETWEEN THE TWO CATEGORIES TO BRING BOTH LIVE FUNCTIONS AND WORK FUNCTIONS TO EXACTLY 50% OF THE TOTAL UNIT AREA, IN ACCORDANCE WITH IBC SECTION 419.

1 LIVE/WORK UNITS ENLARGED PLAN
A1-112 3/16" = 1'-0"

PROJECT #: 121246

DRAWN BY: Author

CHECKED BY: Checker

NILES BOLTON ASSOCIATES

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T 404 365 7600

www.nilesbolton.com

APPLICANT:

BILL SCHRADER

T 925 638 8782

No.	Description	Date
N	JUNE LMRKS. MEETING	5/10/22
This d	rawing, as an instrument of servic	e. is and

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BERKELEY PLAZA 2065 KITTREDGE ST BERKELEY, CA 94704 CA STUDENT LIVING BERKELEY, LLC

SHEET TITLE:

PLAN- LEVEL 1 ENLARGED

SHEET NUMBER:

A1-112



NILES BOLTON

3060 Peachtree Rd. N.W.


lo.	Description	Date
	PLAN UPDATE	6/28/21
	PRELIM APP SB330	7/21/21
	SD SET	9/16/21
	USE PERMIT	10/25/21
	USE PERMIT RESUBMIT.	12/10/21
	SAP	12/22/21
	USE PERMIT RESUBMIT.	3/17/22
	SAP RESUBMIT.	3/23/22
	USE PERMIT RESUBMIT.	3/28/22
	APRIL DRC MEETING	4/11/22
	JUNE LMRKS. MEETING	5/10/22
	CTAFE DEVIENA	07/04/22


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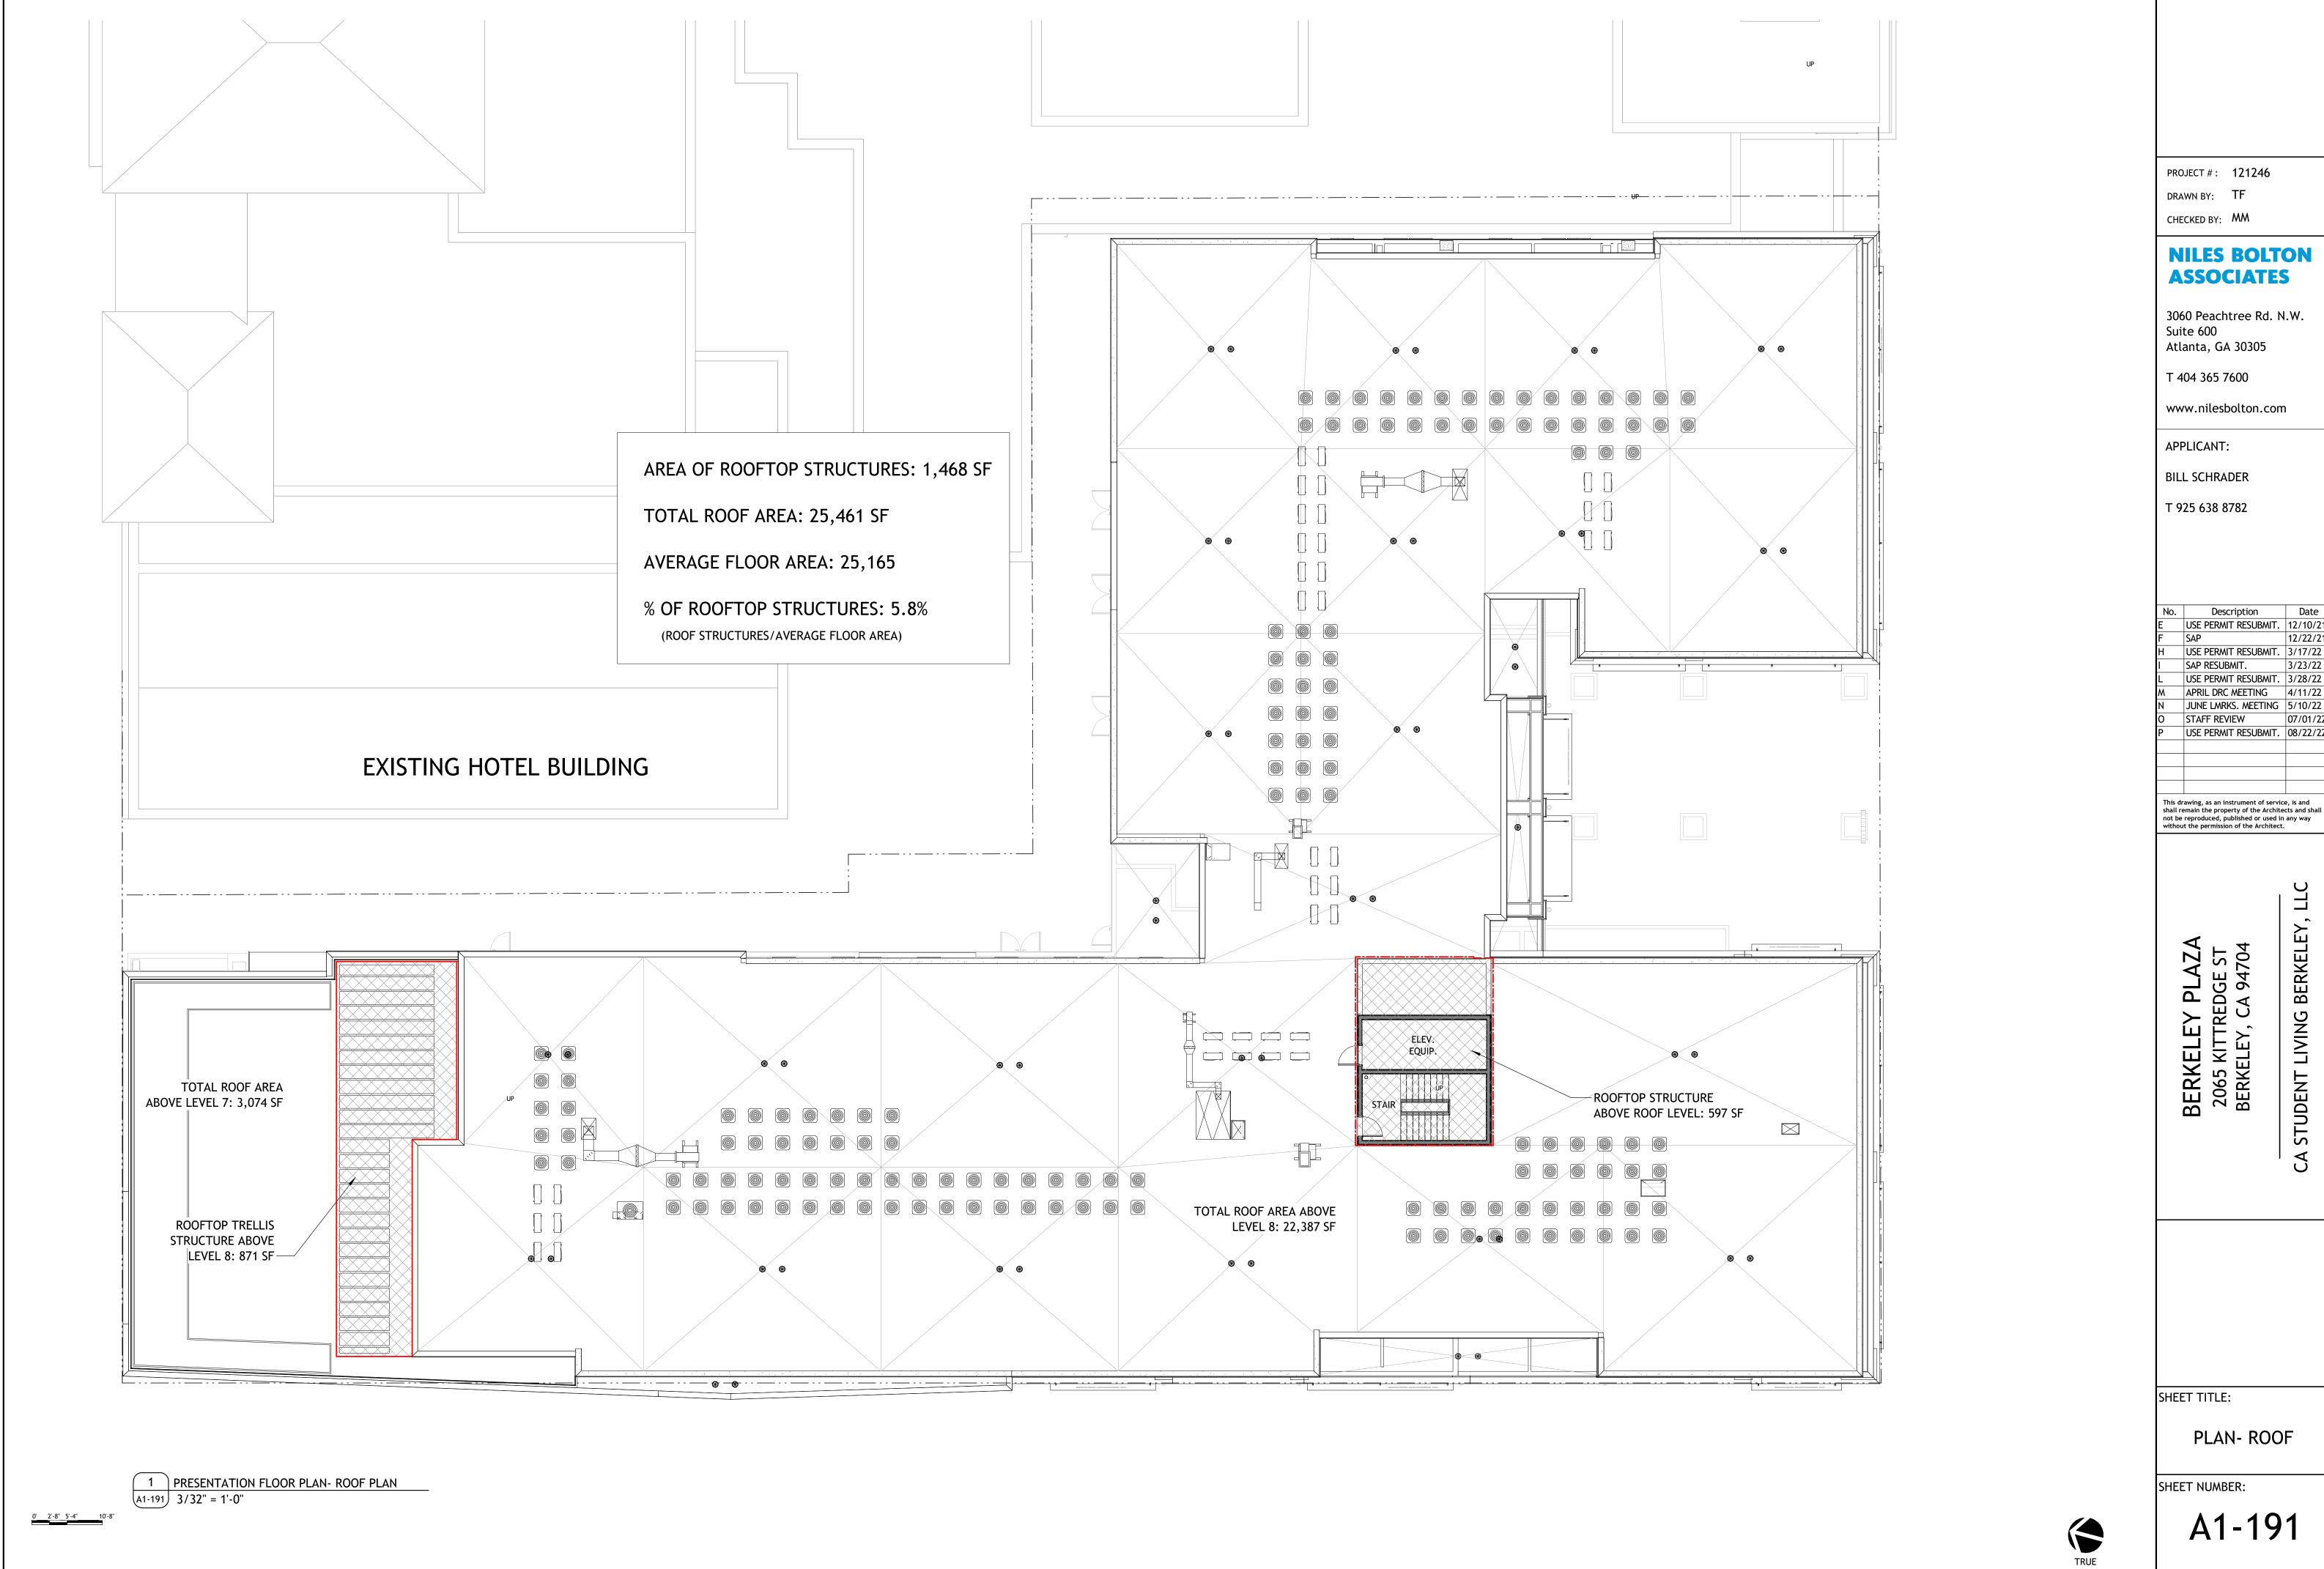
STUDENT LIVING BERKELEY,



PLAN UPDATE	6/28/21
PRELIM APP SB330	7/21/21
SD SET	9/16/21
USE PERMIT	10/25/21
USE PERMIT RESUBMIT.	12/10/21
SAP	12/22/21
USE PERMIT RESUBMIT.	3/17/22
SAP RESUBMIT.	3/23/22
USE PERMIT RESUBMIT.	3/28/22
APRIL DRC MEETING	4/11/22
JUNE LMRKS. MEETING	5/10/22
STAFF REVIEW	07/01/22



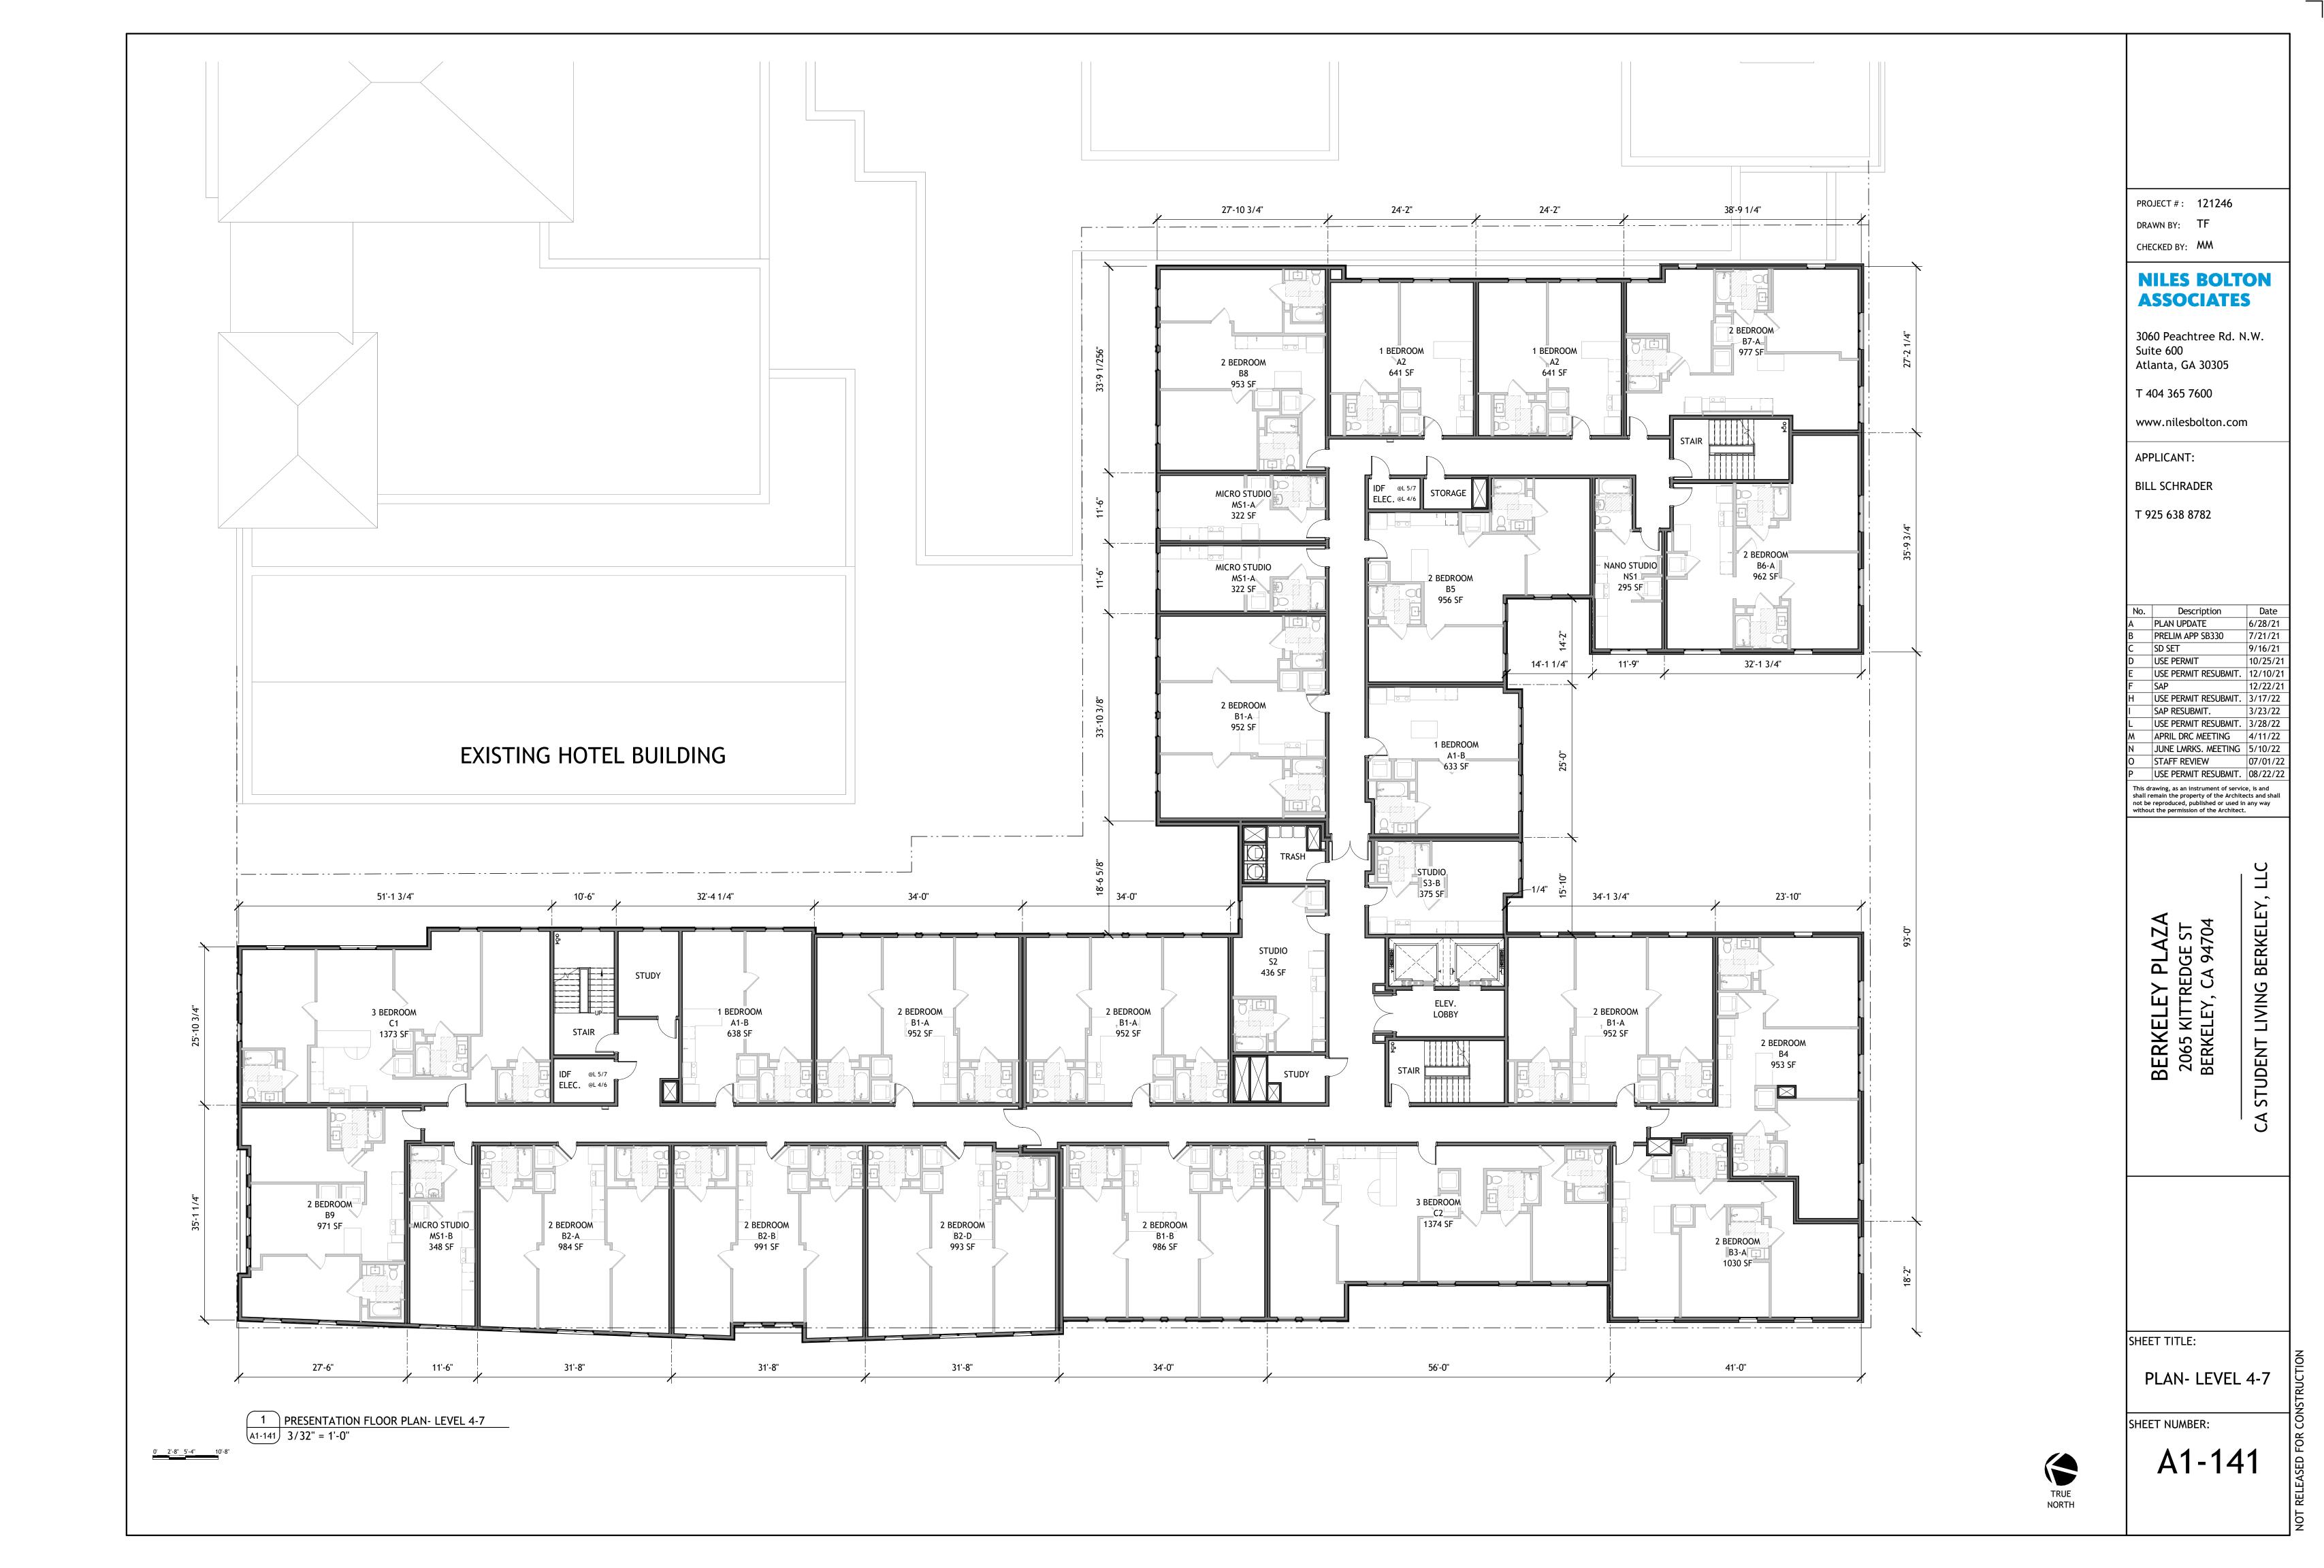

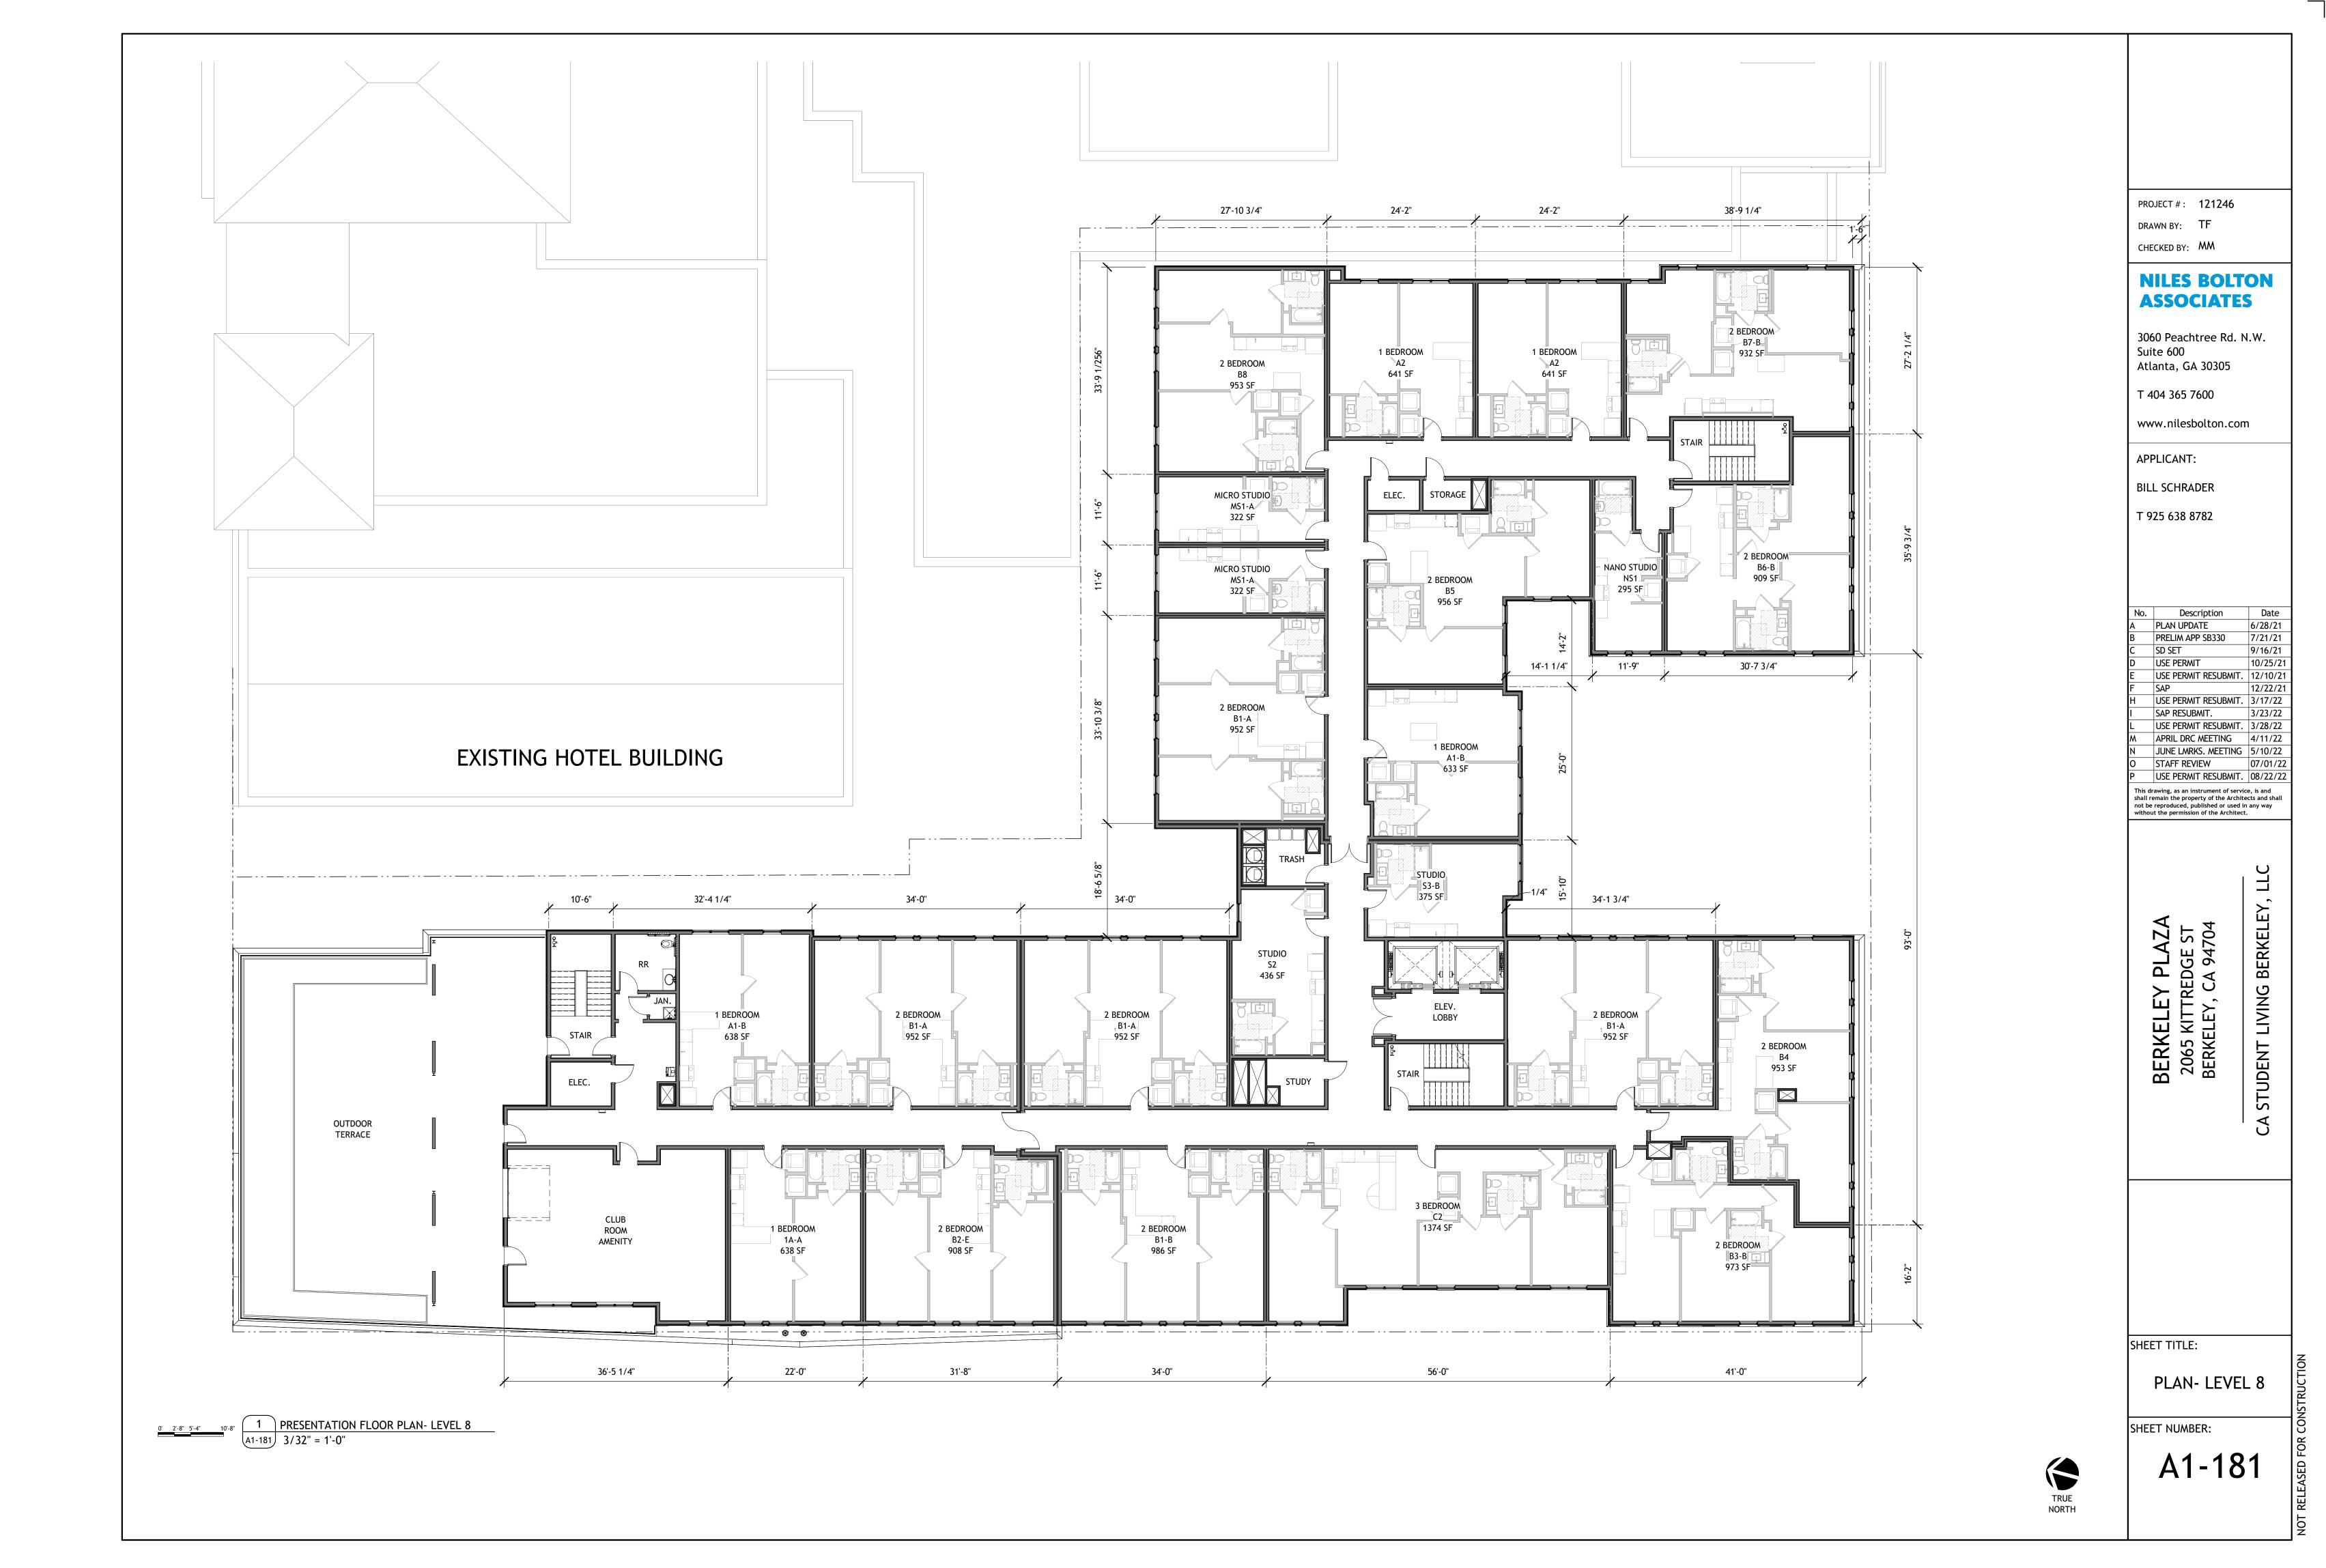

DRAWN BY: TF CHECKED BY: MM

NILES BOLTON ASSOCIATES

3060 Peachtree Rd. N.W.

www.nilesbolton.com

Description USE PERMIT RESUBMIT. 12/10/21 SAP RESUBMIT. USE PERMIT RESUBMIT. 3/28/22 APRIL DRC MEETING 4/11/22 JUNE LMRKS. MEETING 5/10/22 STAFF REVIEW


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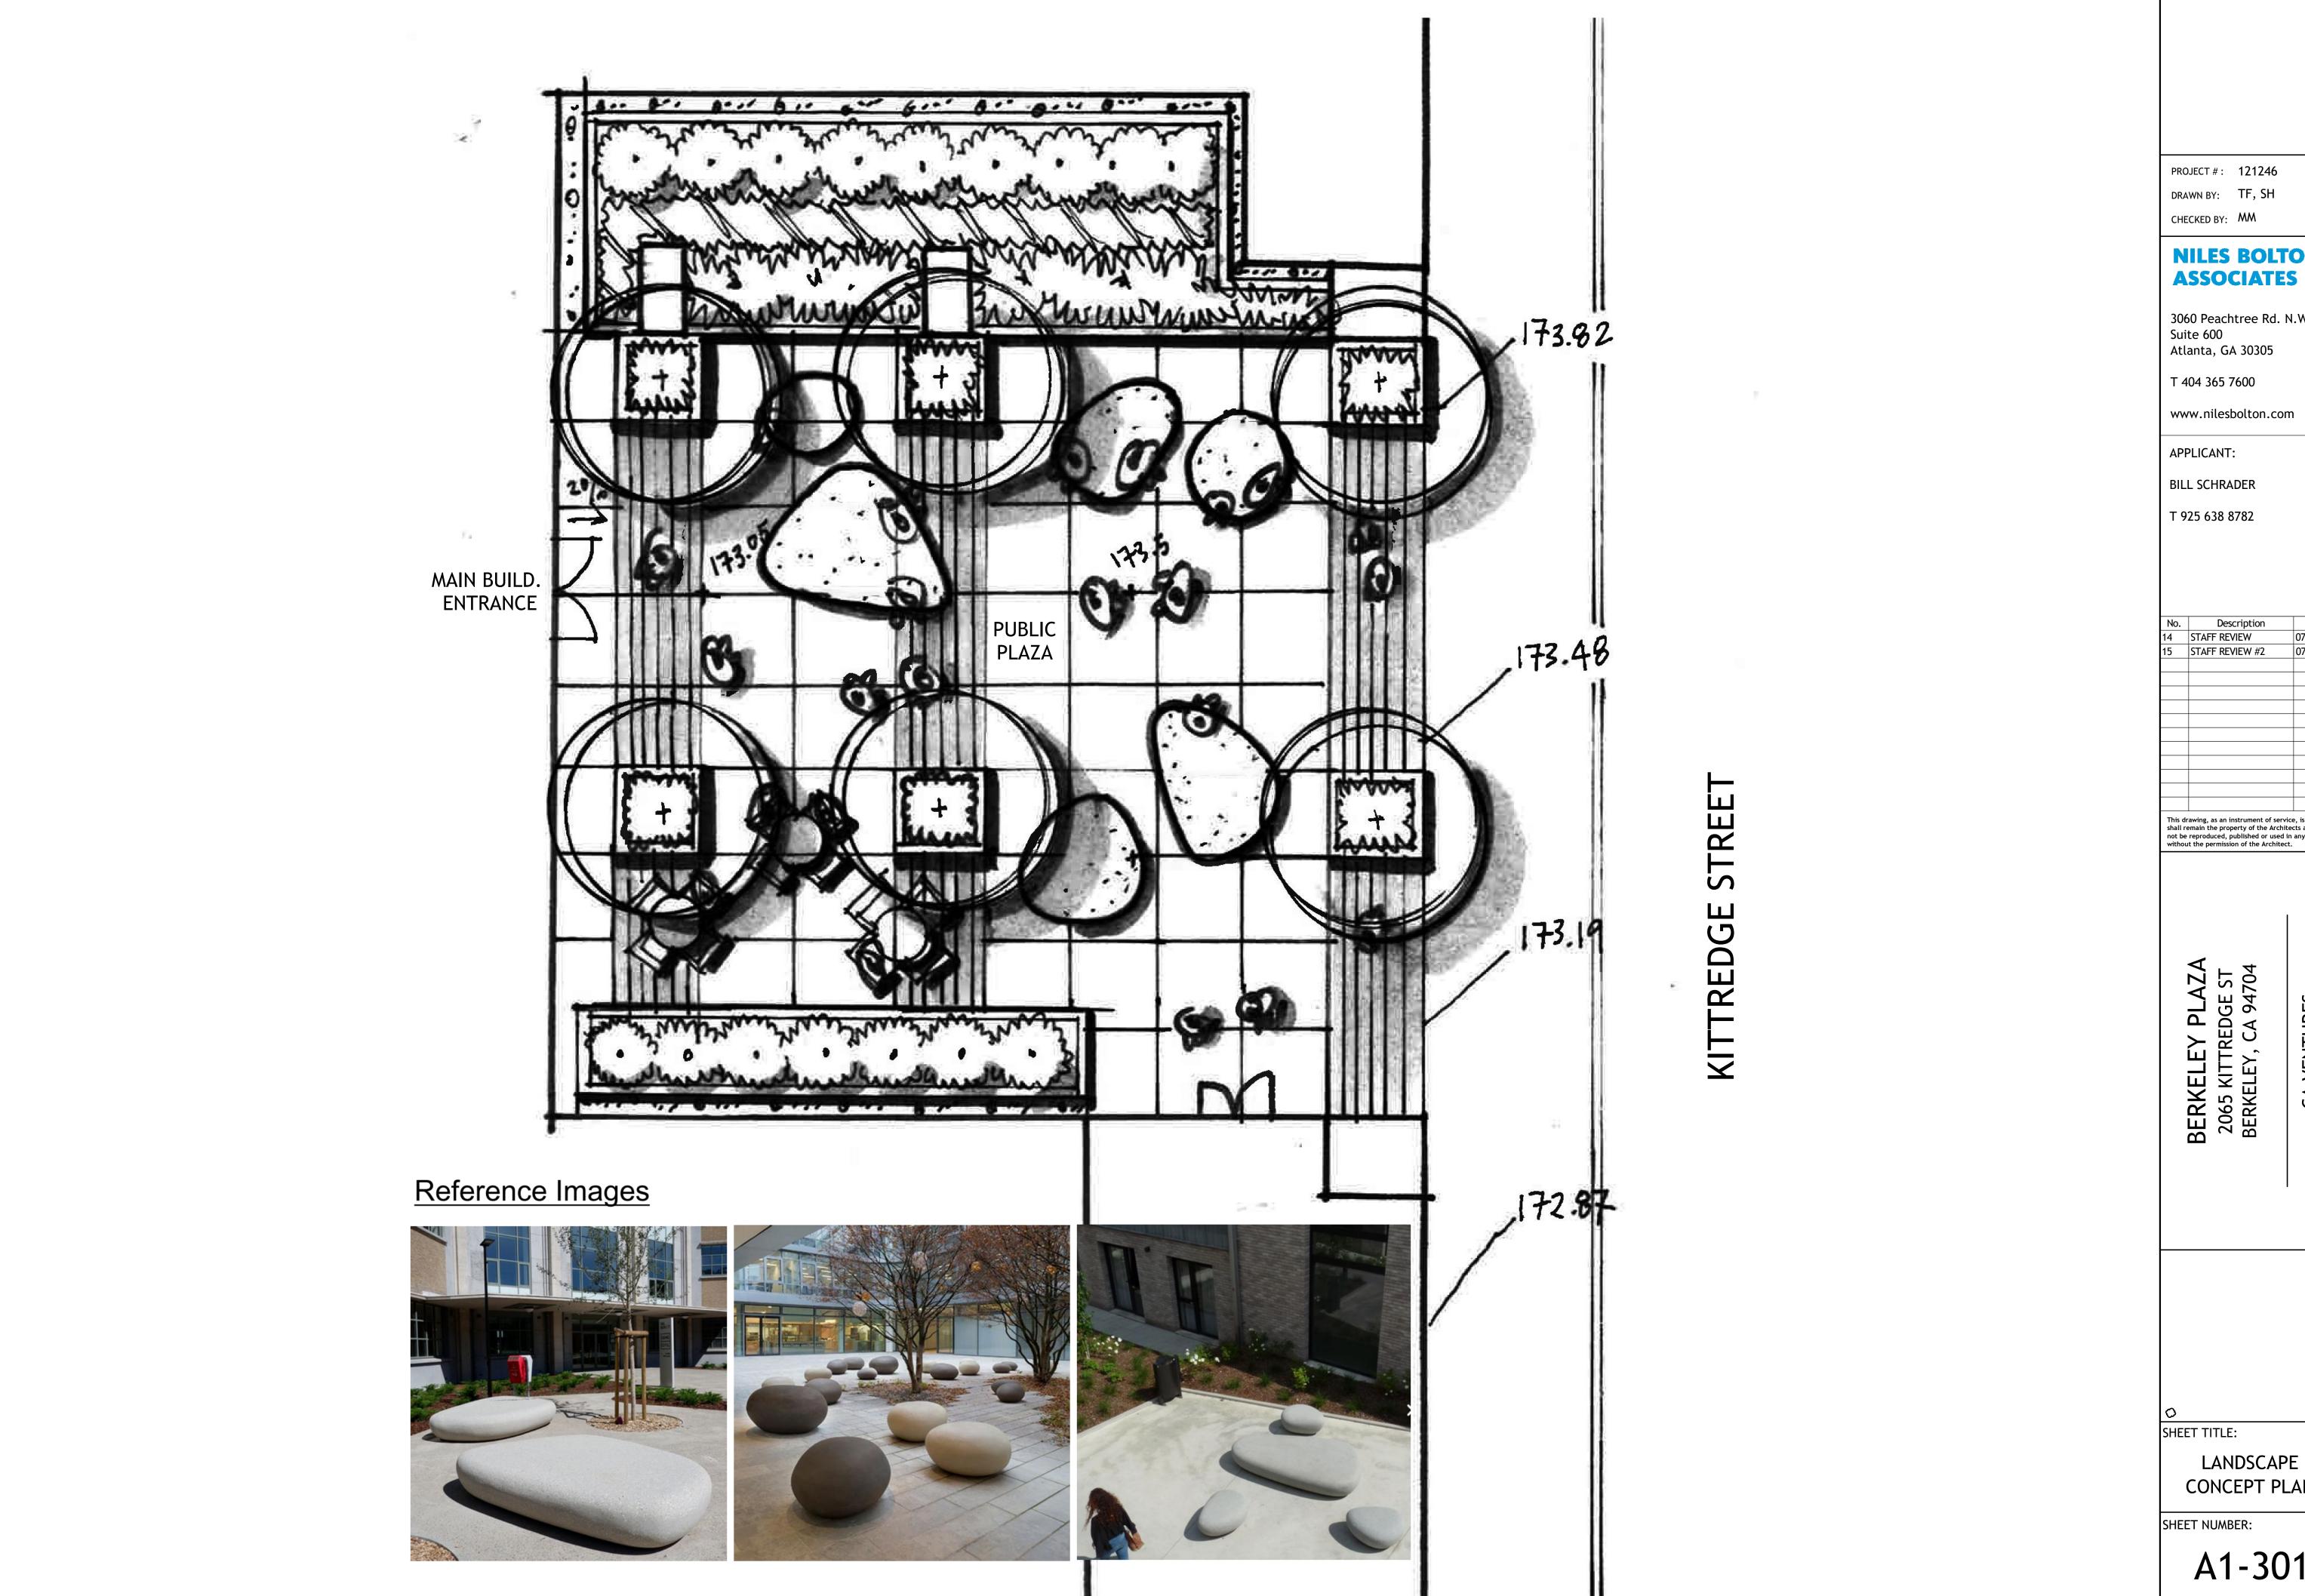
STUDENT

PLAN- ROOF

SHEET NUMBER:

A1-191



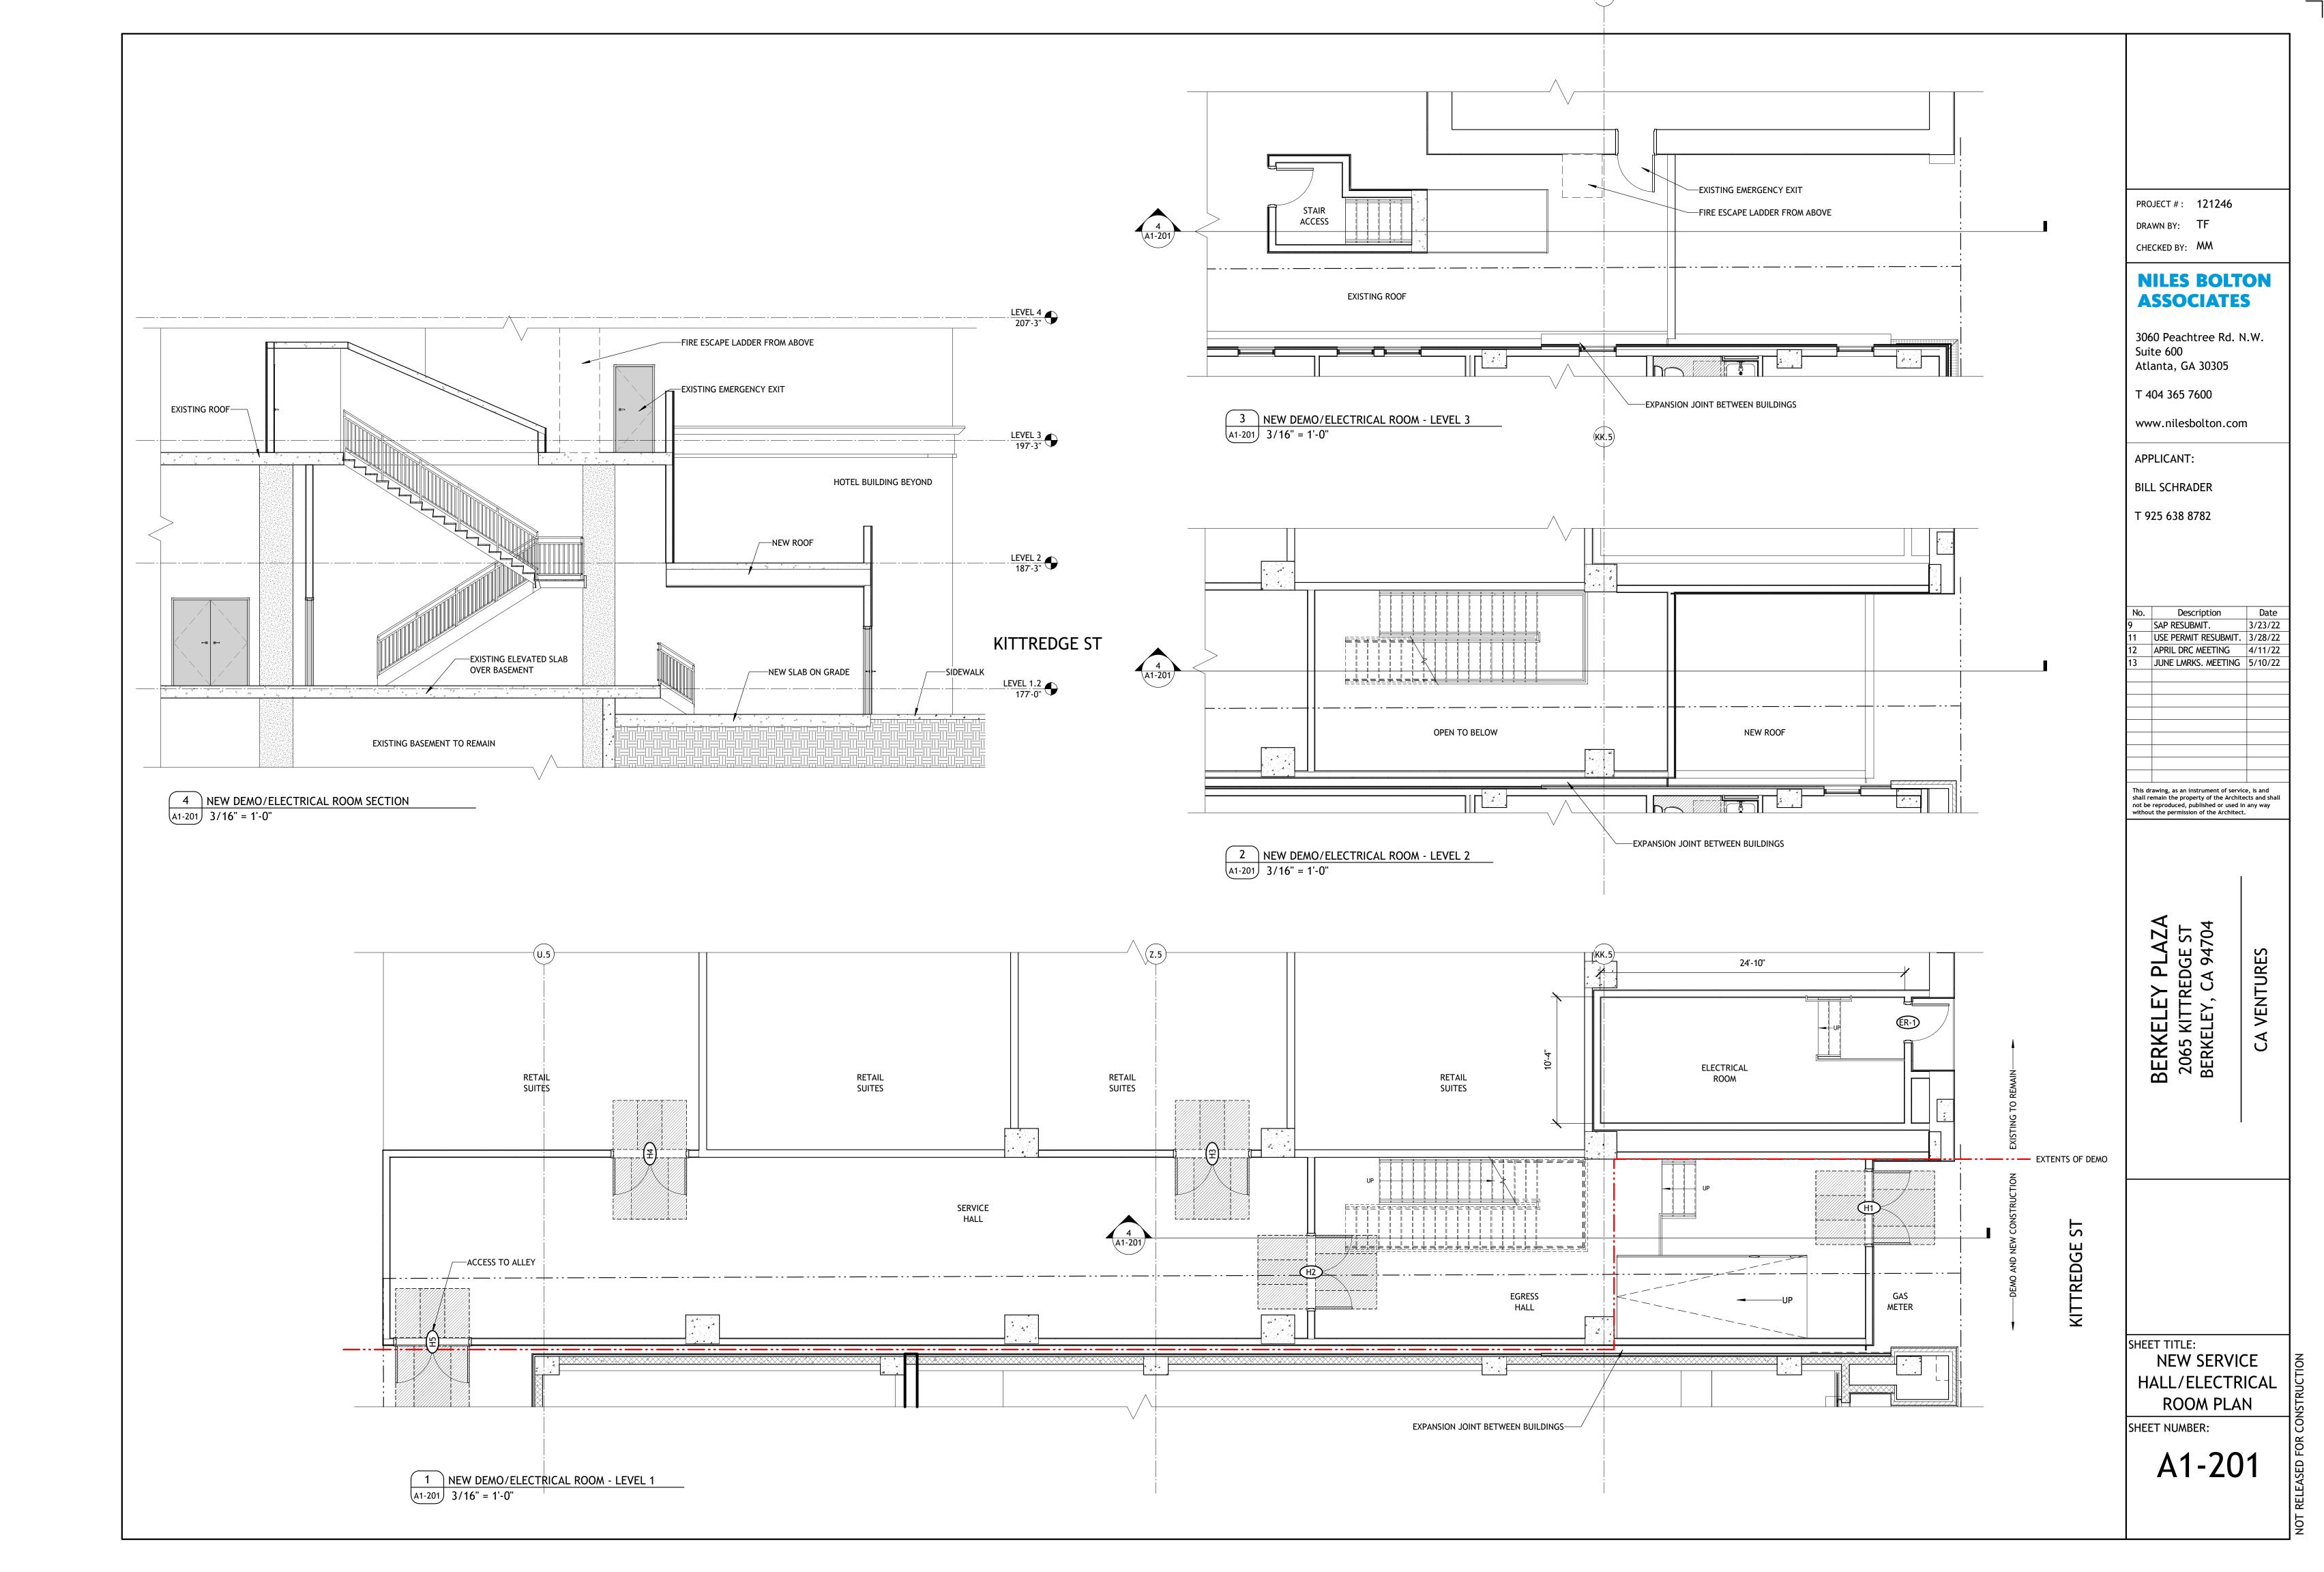

PROJECT #: 121246 DRAWN BY: TF, SH

NILES BOLTON

3060 Peachtree Rd. N.W.

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10.	Description	Date
1	STAFF REVIEW	07/01/22
5	STAFF REVIEW #2	07/13/22
		·
		·

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LANDSCAPE CONCEPT PLAN