

Office of the City Manager

INFORMATION CALENDAR November 3, 2022

To: Honorable Mayor and Members of the City Council

From: Dee Williams-Ridley, City Manager

Submitted by: Jordan Klein, Director, Planning and Development Department

Subject: LPO NOD: 2065 Kittredge Street/#LMSAP2021-0004

INTRODUCTION

The attached Landmarks Preservation Commission Notice of Decision (NOD) for is presented to the Mayor and City Council pursuant to Berkeley Municipal Code/Landmarks Preservation Ordinance (BMC/LPO) Section 3.24.240.A, which requires that "a copy of the Notice of Decision shall be filed with the City Clerk and the City Clerk shall present said copy to the City Council at its next regular meeting."

CURRENT SITUATION AND ITS EFFECTS

The Landmark Preservation Commission (LPC/Commission) has approved a Structural Alteration Permit (SAP) for the subject City Landmark property. This action is subject to a 15-day appeal period, which began on October 19, 2022.

BACKGROUND

BMC/LPO Section 3.24.300 allows City Council to review any action of the Landmarks Preservation Commission in granting or denying a Structural Alteration Permit. In for Council to review the decision on its merits, Council must appeal the Notice of Decision. To do so, a Council member must move this Information Item to Action and then move to set the matter for hearing on its own. Such action must be taken within 15 days of the mailing of the Notice of Decision, or by November 3, 2022. Such certification to Council shall stay all proceedings in the same manner as the filing of an appeal.

If the Council chooses to appeal the action of the Commission, then a public hearing will be set. The Council must then rule on the designation within 30 days of closing the hearing, otherwise the decision of the Commission is automatically deemed affirmed.

Unless the Council wishes to review the determination of the Commission and make its own decision, the attached NOD is deemed received and filed.

ENVIRONMENTAL SUSTAINABILITY & CLIMATE IMPACTS

Landmark designation provides opportunities for the adaptive re-use and rehabilitation of historic resources within the City. The rehabilitation of these resources, rather than their removal, achieves construction and demolition waste diversion, and promotes investment in existing urban centers.

POSSIBLE FUTURE ACTION

The Council may choose to appeal the decision, in which case it would conduct a public hearing at a future date.

FISCAL IMPACTS OF POSSIBLE FUTURE ACTION There are no known fiscal impacts associated with this action.

CONTACT PERSON

Fatema Crane, Principal Planner, Planning and Development, 510-981-7410

Attachments: 1: Notice of Decision – LMSAP2021-0004 for 2065 Kittredge Street



DATE OF BOARD DECISION: August 4, 2022 DATE NOTICE MAILED: October 19, 2022 APPEAL PERIOD EXPIRATION: November 3, 2022 EFFECTIVE DATE OF PERMIT (Barring Appeal): November 4, 2022¹

2065 Kittredge Street

Structural Alteration Permit (#LMSAP2021-0004) to partially demolish the rear portion of the City Landmark Shattuck Hotel building, to completely demolish the 1926 and 1959 Hink's department store expansions; and to construct a new multi-story, mixed use building on the site, located in the Downtown.

The Landmarks Preservation Commission of the City of Berkeley, after conducting a public hearing, **APPROVED** the following permit:

PERMITS REQUIRED:

• Structural Alteration Permit

APPLICANT: Bill Schrader, The Austin Group, 164 Oak Road, Alamo, CA

ZONING DISTRICT: Commercial Downtown/Mixed-Use (C-D/MU)

ENVIRONMENTAL REVIEW STATUS: The Commission adopted the Environmental Impact Report (EIR) Addendum to the certified 2211 Harold Way Mixed-Use Project Final EIR (SCH #2014052063) and a Revised Mitigation Monitoring and Reporting Program (MMRP) pursuant to the California Environmental Quality Act.

The Application materials for this project are available online at: https://berkeleyca.gov/construction-development/land-use-development/zoning-projects

¹ Pursuant to BMC Section 1.04.070, if the close of the appeal period falls on a weekend or holiday, then the appeal period expires the following business day. Pursuant to BMC Section 3.24.190, the City Council may "certify" any decision of the LPC for review, within fifteen days from the mailing of the NOD. Such certification shall stay all proceedings in the same manner as the filing of a notice of appeal.

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LANDMARKS PRESERVATION COMMISSION NOTICE OF DECISION #LMSAP2021-0004 2065 Kittredge Street October 19, 2022 Page 2 of 4

FINDINGS, CONDITIONS AND APPROVED PLANS ARE ATTACHED TO THIS NOTICE

COMMISSION VOTE: 5-2-1-1

YES: ADAMS, CRANDALL, LEUSCHNER, LINVILL, TWU

NO: ENCHILL, SCHWARTZ

ABSTAIN: MONTGOMERY

ABSENT: FINACOM

TO APPEAL THIS DECISION (see Section 3.24.300 of the Berkeley Municipal Code)

An appeal may be taken to the City Council by the City Council on its own motion, by motion of the Planning Commission, by motion of the Civic Art Commission, by the verified application of the owners of the property or their authorized agents, or by the verified application of at least fifty residents of the City aggrieved or affected by any determination of the commission made under the provisions of this chapter.

Such appeal shall be taken by filing a written notice of appeal with the City Clerk within fifteen days after the mailing of the notice of the decision of the commission. The notice of appeal shall clearly and concisely set forth the grounds upon which the appeal is based. If the appeal is taken by an owner of the property affected, or an authorized agent, the notice of appeal shall be filed in duplicate and the City Clerk shall immediately forward one copy to the secretary of the commission. If the appeal is taken by someone other than an owner of affected property or an authorized agent, the notice of appeal shall be filed in triplicate and the City Clerk shall immediately forward one copy to the secretary of an authorized agent, the notice of appeal shall be filed in triplicate and the City Clerk shall immediately forward one copy to the owner or authorized agent of the affected property and one copy to the secretary of the commission. Within ten days after the filing of a notice of appeal, the secretary of the commission shall transmit to the City Council a copy of the application, a copy of the notice of appeal and a written statement setting forth the reasons for the commission's decision, and shall make available to the council, at the time the matter is considered by the council, all other papers constituting the record upon which the action appealed from was taken.

The City Clerk is located at 2180 Milvia Street, 1st Floor, Berkeley. The City Clerk's facsimile number is (510) 981-6901. The City Clerk's telephone number is (510) 981-6900.

An appeal must be received prior to 5:00 p.m. on the "APPEAL PERIOD EXPIRATION" date shown above (if the close of the appeal period falls on a weekend or holiday, then the appeal period expires the following business day).

The required fee is as follows (checks and money orders must be payable to "City of Berkeley"):

LANDMARKS PRESERVATION COMMISSION NOTICE OF DECISION #LMSAP2021-0004 2065 Kittredge Street October 19, 2022 Page 3 of 4

a. The basic fee for persons other than the applicant is \$500. This fee may be reduced to \$100 if the appeal is signed by persons who lease or own at least 50 percent of the parcels or dwelling units within 300 feet of the project site, or at least 25 such persons (not including dependent children), whichever is less.

b. The fee for appeals of affordable housing projects (defined as projects which provide 50 percent or more affordable units for households earning 80% or less of Area Median Income) is \$500, which may not be reduced.

c. The fee for all appeals by Applicants is \$2,500.

STRUCTURAL ALTERATION PERMIT ISSUANCE:

If no appeal is received, the Structural Alteration Permit will be issued on the first business day following expiration of the appeal period, and the project may proceed at that time.

NOTICE CONCERNING YOUR LEGAL RIGHTS:

If you object to this decision, the following requirements and restrictions apply:

- 1. If you challenge this decision in court, you may be limited to raising only those issues you or someone else raised in a public hearing and/or written correspondence during the proceedings related to this permit.
- 2. You must appeal to the City Council within fifteen (15) days after the Notice of Decision of the action of the Landmarks Preservation Commission is mailed.
- Pursuant to Code of Civil Procedure Section 1094.6(b) and Government Code Section 65009(c)(1), no lawsuit challenging a City Council decision, as defined by Code of Civil Procedure Section 1094.6(e), regarding a permit may be filed more than ninety (90) days after the date the decision becomes final, as defined in Code of Civil Procedure Section 1094.6(b). Any lawsuit not filed within that ninety (90) day period will be barred.
- 4. Pursuant to Government Code Section 66020(d)(1), notice is hereby given to the applicant that the 90-day protest period for any fees, dedications, reservations, or other exactions included in any permit approval begins upon final action by the City, and that any challenge must be filed within this 90-day period.
- 5. If you believe that this decision or any condition attached to it denies you any reasonable economic use of the subject property, was not sufficiently related to a legitimate public purpose, was not sufficiently proportional to any impact of the project, or for any other reason constitutes a "taking" of property for public use without just compensation under the California or United States Constitutions, your appeal of this decision must including the following information:
 - A. That this belief is a basis of your appeal.
 - B. Why you believe that the decision or condition constitutes a "taking" of property as set

LANDMARKS PRESERVATION COMMISSION NOTICE OF DECISION #LMSAP2021-0004 2065 Kittredge Street October 19, 2022 Page 4 of 4

forth above.

C. All evidence and argument in support of your belief that the decision or condition constitutes a "taking" as set forth above.

If you do not do so, you will waive any legal right to claim that your property has been taken, both before the City Council and in court.

PUBLIC COMMENT:

Communications to Berkeley boards, commissions or committees are public record and will become part of the City's electronic records, which are accessible through the City's website. **Please note: e-mail addresses, names, addresses, and other contact information are not required, but if included in any communication to a City board, commission or committee, will become part of the public record.** If you do not want your e-mail address or any other contact information to be made public, you may deliver communications via U.S. Postal Service or in person to the secretary of the relevant board, commission or committee. If you do not want your contact information included in the public record, please do not include that information in your communication. Please contact the secretary to the relevant board, commission or committee for further information.

FURTHER INFORMATION:

Questions about the project should be directed to the project planner, Fatema Crane, at (510) 981-7413 or fcrane@cityofberkeley.edu. All project application materials, may be viewed at the Permit Service Center (Zoning counter), 1947 Center Street, between 8 a.m. and 4 p.m., Monday through Thursday.

ATTACHMENTS:

- 1. Findings and Conditions
- 2. Project Plans, revised JULY 22, 2022

ATTEST:

Fatema Crane, Senior Planner Secretary to the Landmarks Preservation Commission

cc: City Clerk Applicant: Bill Schrader, The Austin Group, 164 Oak Road, Alamo, CA Property Owner: CA Student Living Berkeley, LLC, 130 E Randolph Street, Suite 2100, Chicago, IL

ATTACHMENT 1, PART 2

FINDINGS AND CONDITIONS AUGUST 4, 2022

2065 Kittredge Street

Structural Alteration Permit #LMSAP 2021-0004

PROJECT DESCRIPTION

The application proposes to partially demolish the rear portion of the City Landmark Shattuck Hotel building, and to completely demolition the 1926 and 1959 Hink's department store expansions; and to construct a new multi-story, mixed-use building on the site, located in the Downtown.

CEQA FINDINGS

- 1. An Addendum to the Final Environmental Impact Report (EIR) to the 2211 Harold Way Mixed-Use Project, which was certified in December 2015, was prepared to evaluate the potentially significant environmental impacts of the proposed project, pursuant to the California Environmental Quality Act. The Landmarks Preservation Commission has considered the Addendum together with the previously certified Final EIR. The Addendum reflects the independent judgment of the Commission and has been completed in compliance with CEQA. The Addendum, together with the 2211 Harold Way Mixed-Use Project Final EIR, is adequate for the 2065 Kittredge Street Mixed-Use Project. On the basis of the whole record, including the Addendum, the previously certified Final EIR, and the public comments received, the Commission finds that the project changes described in the Addendum, i.e., the modified project, will not result in new significant effects or a substantial increase in the severity of previously identified significant effects on the environment.
- The Addendum prepared for the project addressed the following issues: Air Quality, Cultural Resources, Greenhouse Gas Emissions, Noise, Transportation, and Utilities and Service Systems.
- **3.** Public Resources Code Section 21081.6 and CEQA Guidelines Section 15091(d) require the City to adopt a reporting or monitoring program for the changes to the project that it has adopted or made a condition of approval in order to avoid or substantially lessen significant effects on the environment. The Mitigation Monitoring and Reporting Program for the 2211 Harold Way Mixed-Use Project Final EIR, as modified in the addendum and reflected in the Conditions of Approval for the modified project, are hereby adopted as the reporting and monitoring program for this project; see Exhibit A. The monitoring program is designed to ensure compliance during project implementation.

LANDMARKS PRESERVATION ORDINANCE FINDINGS

Pursuant to Berkeley Municipal Code Sections 3.24.260.C.1.a, the Landmarks Preservation Commission of the City of Berkeley makes the following findings:

1. The proposed project allows for the preservation of the Mission Revival style original hotel, together with all of its 1912 and most of its 1913 additions. The Hotel will still form a

FINDINGS AND CONDITIONS Page 2 of 4

significant presence on Shattuck Avenue, retaining its distinctive form, stucco walls, decorative tile work, wall surface ornamentation, squared towers, hipped roof forms, arched or arcaded wall openings, varied roof heights, red clay tile roof cladding, and broad eave overhangs with exposed rafter tails; with the new building rising behind. Mitigation measures are included to reduce any construction related impacts to the hotel, and as such the project will not adversely affect its features.

FINDINGS REGARDING THE SECRETARY OF THE INTERIOR'S STANDARDS FOR REHABILITATION

Regarding the Secretary of the Interior's (SOI) Standards for Restoration/Rehabilitation, the Landmarks Preservation Commission of the City of Berkeley makes the following findings:

- <u>SOI Standard #2</u>: The proposed project will retain the City Landmark Shattuck Hotel building, including its early 1912 and 1913 building additions. The structure's Spanish Revival architectural design and character-defining features will not be removed or altered. The proposed demolition of a low-rise, rear portion of the 1913 addition building would not result alteration of the primary building facades, thereby avoiding loss of distinctive materials and features. The proposed wholesale demolition of the 1926 building addition is not found to be a significant loss of distinctive features, in part because the structure's significance lay primarily in its associations with historical events. As the significant architectural character of the Shattuck Hotel will not be completely removed, and will continue to represented in the retained features of this site, the proposed project complies with Standard #2.
- 2. <u>SOI Standard #9</u>: The proposed new construction will be visually and physically separated from the street-facing façades of the Shattuck Hotel building; the Allston elevation will be separated by an existing alley that will remain, and the Kittredge elevation will feature a hyphen where the façade steps back and away from the historic structure. The new building will be located to the rear of the Shattuck Hotel, and the Hotel will retain its primacy and presence along Shattuck Avenue. The design of the new building is distinctively contemporary, thereby differentiating it from the historic structure.

ZONING ORDINANCE DESIGN REVIEW STANDARDS

Pursuant to BMC Chapter 23E.12.020, the Landmarks Preservation Commission of the City of Berkeley finds the project as proposed substantially conforms with the Southside Area Plan Design Guidelines (2011) in that the project:

1. General Guidelines - Similar to typical 20th century commercial design, like Shattuck Hotel, the new project generally maintains a band separating the building's base and creating a middle and a top. The upper most (or *top*) floor is present, though quiet as it steps back and features usable open space. The selection of proposed building materials is found to be comparable with new construction in Downtown, while the color palette is reflective of the historic Hotel building. The proposed window design comprises 25-50% of the upper façade, as recommended.

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2065 Kittredge Street – Structural Alteration Permit #LMSAP 2022-0004 August 4, 2022

- 2. Roof Forms. Owing to the proposed massing and color palette, much of the upper story visually serves as a successful termination to the building.
- 3. Building Materials The materials proposed for this project are found to be durable and of high quality.
- 4. Frontage, Setbacks & Heights The project height is comparable to the neighboring buildings, including the City Landmark Shattuck Hotel. As the results of refinements, the final proposal maintains a continuous build-to-line with the exception of the main, residential entry plaza. A step-back occurs throughout the project at approximately 65 to 75 ft. above street level.
- 5. Open Spaces As the result of project refinements, the final design features public open space that is directly aligned with the existing open space at Berkeley Public Library.
- 6. Public Serving Frontages for Kittredge, Harold and Allston Way The project features the recommended pattern and placement of entrances on all three street-facing facades, as well as the desired amount of glazing on Kittredge and Allston elevations. The Harold Way façade exceeds the recommended amount of glazing at the live/work entrances and comes close in the residential window pattern.

HISTORIC PRESERVATION & DESIGN REVIEW CONDITIONS

- 1. **Project plans**. Project shall conform to plans, facades restoration specifications, and photographs, dated July 22, 2022.
- Final Design Review. Pursuant to BMC Section 23.406.070.C, prior to submittal of any building permit for this project, the project proponent shall obtain Final Design Review (FDR) approval from the Landmarks Preservation Commission. Prior to FDR consideration, the project proponent shall make the following improvements subject to Commission approval:

a) Enlarge and further refine the commercial tenant space at the corner of Kittredge Street and Harold Way.

b) Further refine the public open space areas.

- c) Establish internal access between the bicycle parking area and the residential entry.
- 3. This Structural Alteration Permit approval is contingent upon Use Permit approval of this project.
- 4. **Mitigation monitoring & reporting program Exhibit A**. The project proponent shall adhere to and demonstrate compliance with this plan to the satisfaction of the Zoning Officer. The project proponent shall bear the cost of monitoring to ensure compliance with the plan; a deposit of not less than \$10,000 may be required prior to building permit submittal in order to secure the services of a third-party monitor.
- 5. **Chemical Treatments.** Any chemical or physical graffiti removal treatments needed as construction progresses shall be undertaken using the gentlest means possible.

- 6. **Signage program**. For Final Design Review, the project proponent shall submit complete signage details, including colors, materials, letter heights, dimensions, placement on building, and installation details. All materials will be matte unless otherwise noted.
- 7. Landscape & Irrigation. For Final Design Review, the applicant shall submit a Landscape plan including the number, location, and species of all proposed plantings, and which existing plantings shall be removed. The applicant shall provide irrigation for all landscaped areas or provide drought tolerant plant palette. This shall be called out on Landscape building permit drawings. Further, the plans shall include irrigation for all landscaped areas.
- 8. **Exterior lighting detail**. For Final Design Review, the project proponent shall submit lighting details showing all proposed site and building lighting. Exterior lighting, including for signage, shall be downcast and not cause glare on the public right-of-way and adjacent parcels.



DEVELOPER

Attachment 1, par

CA STUDENT LIVING BERKELEY, LLC 130 E RANDOLPH STREET SUITE 2100 CHICAGO, IL 60601 CONTACT: JESSICA LEO PHONE: (304) 238-4745

ARCHITECTURE

NILES BOLTON ASSOCIATES 3060 PEACHTREE RD. N.W. SUITE 600 ATLANTA, GA 30305 CONTACT: MOHAMED MOHSEN PHONE: (404) 365-7600

CIVIL ENGINEERING

LANGAN ENGINEERING AND ENVIRONMENTAL SERVICES, INC. 135 MAIN STREET SUITE 1500 SAN FRANCISCO, CA 94105 CONTACT: JASON JOH PHONE: (415) 955-5200

LANDSCAPE ARCHITECTURE

THOMAS BAAK AND ASSOCIATES, LLP 1620 NORTH MAIN STREET SUITE 4 WALNUT CREEK, CA 94596 CONTACT: RICK STOVER PHONE: (925) 933-2583

BERKELEY PLAZA 2065 KITTREDGE ST, BERKELEY, CA 94704

CA VENTURES

STRUCTURAL ENGINEERING

DCI ENGINEERS 135 MAIN STREET SUITE 1800 SAN FRANCISCO, CA 94105 CONTACT: MICHAEL BAUER PHONE: (415) 638-8913

INTERIOR DESIGN

KUCHAR 1821 WEST HUBBARD SUITE 105 CHICAGO, IL 60622 CONTACT: SARAH KUCHAR-PARKINSON PHONE: (312) 624-9206

GENERAL CONTRACTOR

07-13-22

STAFF REVIEW PACKAGE #2

WEST BUILDERS, INC. 120 RAILROAD AVENUE POINT RICHMOND, CA 94801

CONTACT: SEAN KIRBY PHONE: (510) 307-5678

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A0-000	COVER SHEET		
A0-001	EXISTING SITE PHOTOS		
A0-002	EXISTING SITE PHOTOS		
A0-002	EXISTING SITE PHOTOS		
A0-004	DEMO SITE PLAN EXHIBIT	PROJECT # : 121246	
A0-005	PROJECT STATS	DRAWN BY: TF	
A0-006	ZONING AND CODE INFO	CHECKED BY: MM	
A1-001	SITE PLAN EXISTING- LEVEL U1	NILES BOLT	ON
A1-002	SITE PLAN EXISTING- LEVEL 01	ASSOCIATE	S
A1-002	SITE PLAN PROPOSED- LEVEL U1		
A1-004	SITE PLAN PROPOSED- LEVEL 1	3060 Peachtree Rd. Suite 600	N.W.
A1.001	ELECTRICAL ROOM DEMO, PLAN, SECTION	Atlanta, GA 30305	
A1-101	PLAN- LEVEL U1	T 404 365 7600	
A1-111	PLAN- LEVEL 1	www.nilesbolton.com	m
A1-112	PLAN- LEVEL 1 ENLARGED		
A1-121	PLAN- LEVEL 2	APPLICANT:	
A1-131	PLAN- LEVEL 3	BILL SCHRADER	
A1-141	PLAN- LEVEL 4-7		
A1-181	PLAN- LEVEL 8	Т 925 638 8782	
A1-191	PLAN- ROOF		
A1-201	NEW SERVICE HALL/ELECTRICAL ROOM PLAN		
A3-001	ELEVATIONS- WEST (HAROLD WAY)	No. Description	Date
A3-002	ELEVATIONS- SOUTH (KITTREDGE ST.)	3 SD SET 4 USE PERMIT	9/16/21
A3-003	ELEVATIONS- NORTH (ALLSTON WAY)	5 USE PERMIT RESUBMIT.	12/10/21
A3-004	ELEVATIONS- NORTH (HIDDEN)	6 SAP 7 USE PERMIT RESUBMIT.	
A3-005	ELEVATIONS- EAST (HIDDEN)	8 USE PERMIT RESUBMIT. 9 SAP RESUBMIT.	3/17/22 3/23/22
A3-006	ELEVATIONS- SOUTH ENLARGED (KITTREDGE ST.)	11 USE PERMIT RESUBMIT. 12 APRIL DRC MEETING	3/28/22 4/11/22
A3-101	BUILDING SECTION	13 JUNE LMRKS. MEETING	
A3-102	BUILDING SECTION	15 STAFF REVIEW #2	07/13/22
A3-201	PERSPECTIVES	16 LPC REVISIONS This drawing, as an instrument of serv	
A3-202	PERSPECTIVES	shall remain the property of the Archin not be reproduced, published or used without the permission of the Architec	in any way
A3-301	SHADOW STUDIES - JUNE 21		
A3-302	SHADOW STUDIES - DEC 21		
A3-303	SHADOW STUDIES - DEC 10		l
A3-304	STREET STRIP ELEVATIONS		
A3-305	MATERIAL BOARDS		
A5-001	SAMPLE UNITS	EY PLAZA TREDGE ST Y, CA 94704	S
LO	TREE REMOVAL PLAN	PLA DGE 947	CA VENTURES
L1	GROUND LEVEL PRELIMINARY LANDSCAPE PLAN	LEY TTRE	
L2	EIGHTH FLOOR PRELIMINARY LANDSCAPE PLAN		
L3	RECOMMENDED PLANT LIST, SITE AMENITY IMAGES	BERKELE 2065 KITT BERKELEY,	× ×
L4	GROUND LEVEL PRELIMINARY IRRIGATION PLAN	ERF	
L5 L6	EIGHTH FLOOR PRELIMINARY IRRIGATION PLAN IRRIGATION NOTES AND DETAILS	B 2 B	
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09-16-21	SCHEMATIC DESIGN		
10-25-21	USE PERMIT		
12-10-21	USE PERMIT RESUBMISSION	0	
12-22-21	STRUCTURAL ALTERATION PERMIT	SHEET TITLE:	
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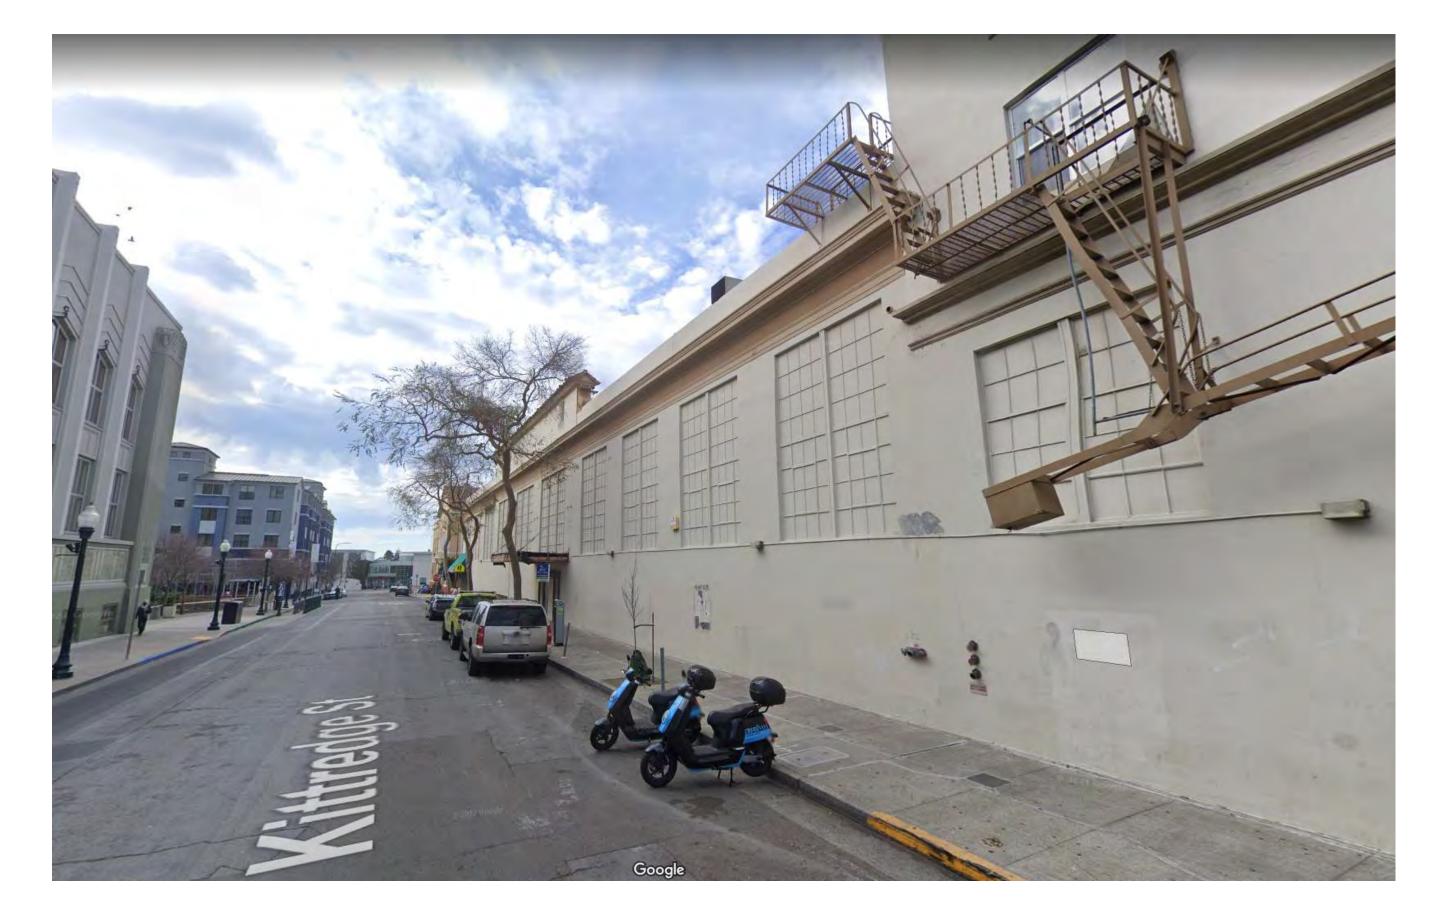
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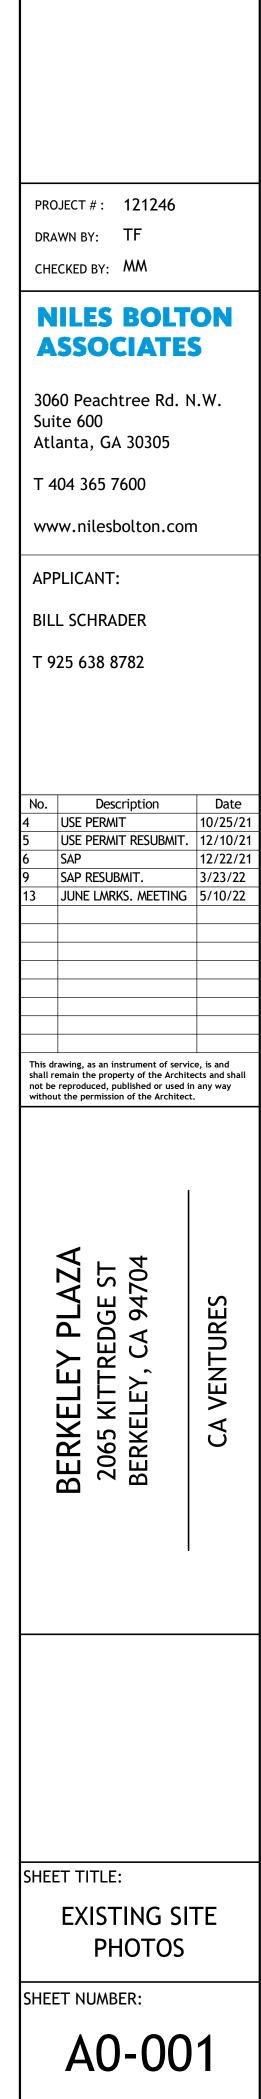
3 SITE PHOTO - HAROLD WAY - LOOKING SOUTH A0-001 12" = 1'-0"




2 SITE PHOTO - ALLSTON WAY AND HAROLD WAY - LOOKING EAST A0-001 12" = 1'-0"




4 SITE PHOTO - KITTREDGE ST - LOOKING WEST A0-001 12" = 1'-0"



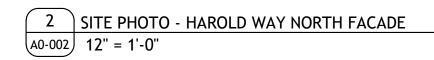




1SITE PHOTO - ALLSTON WAY FACADEA0-00212" = 1'-0"

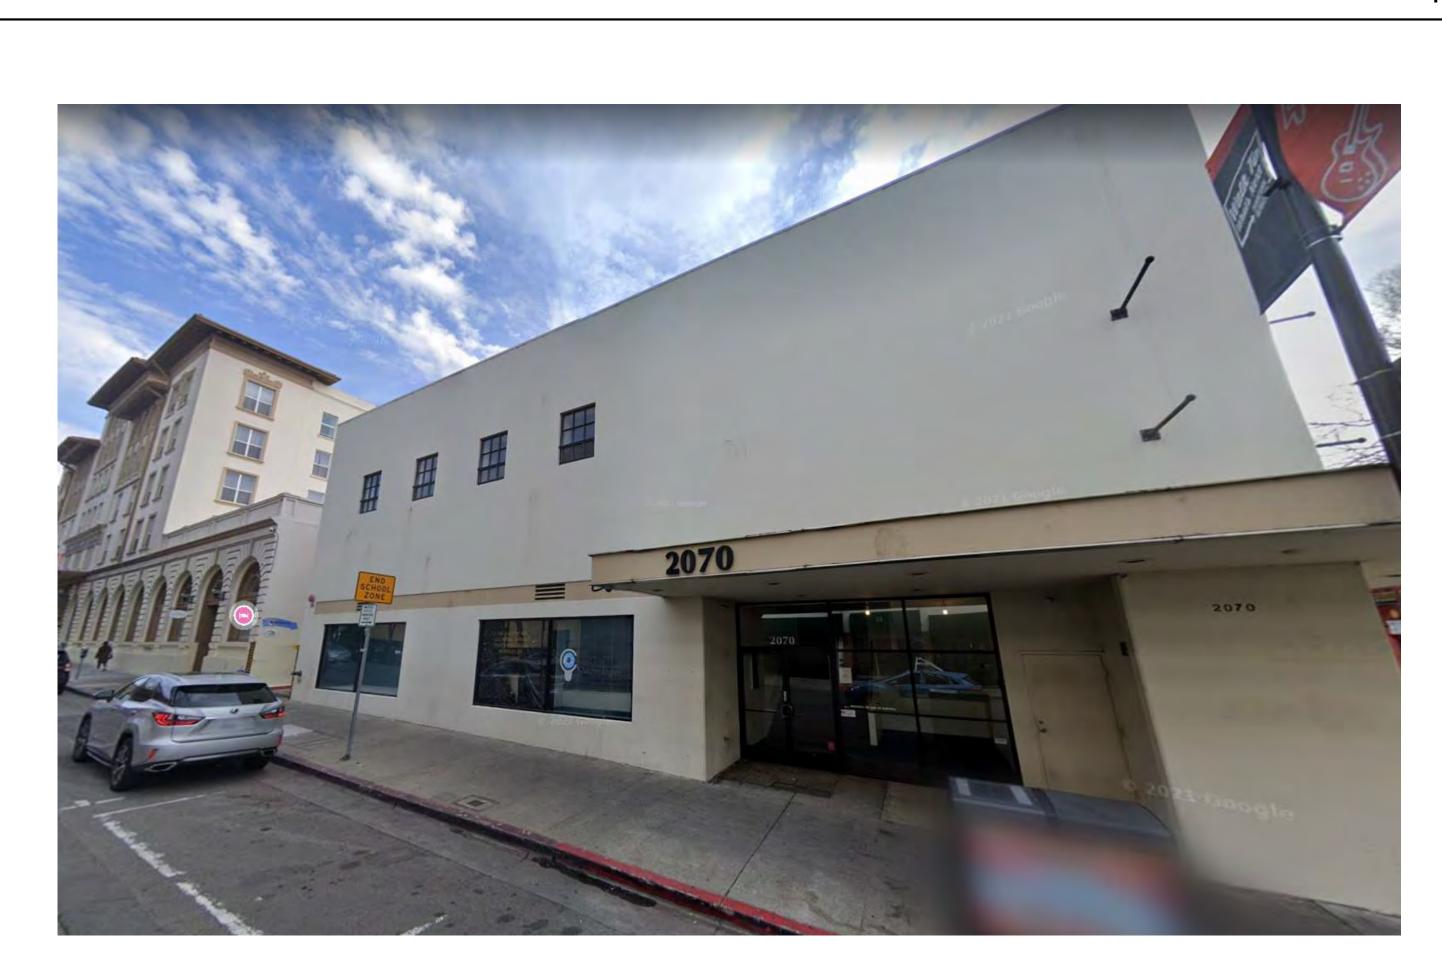




4SITE PHOTO - KITTREDGE ST FACADEA0-00212" = 1'-0"

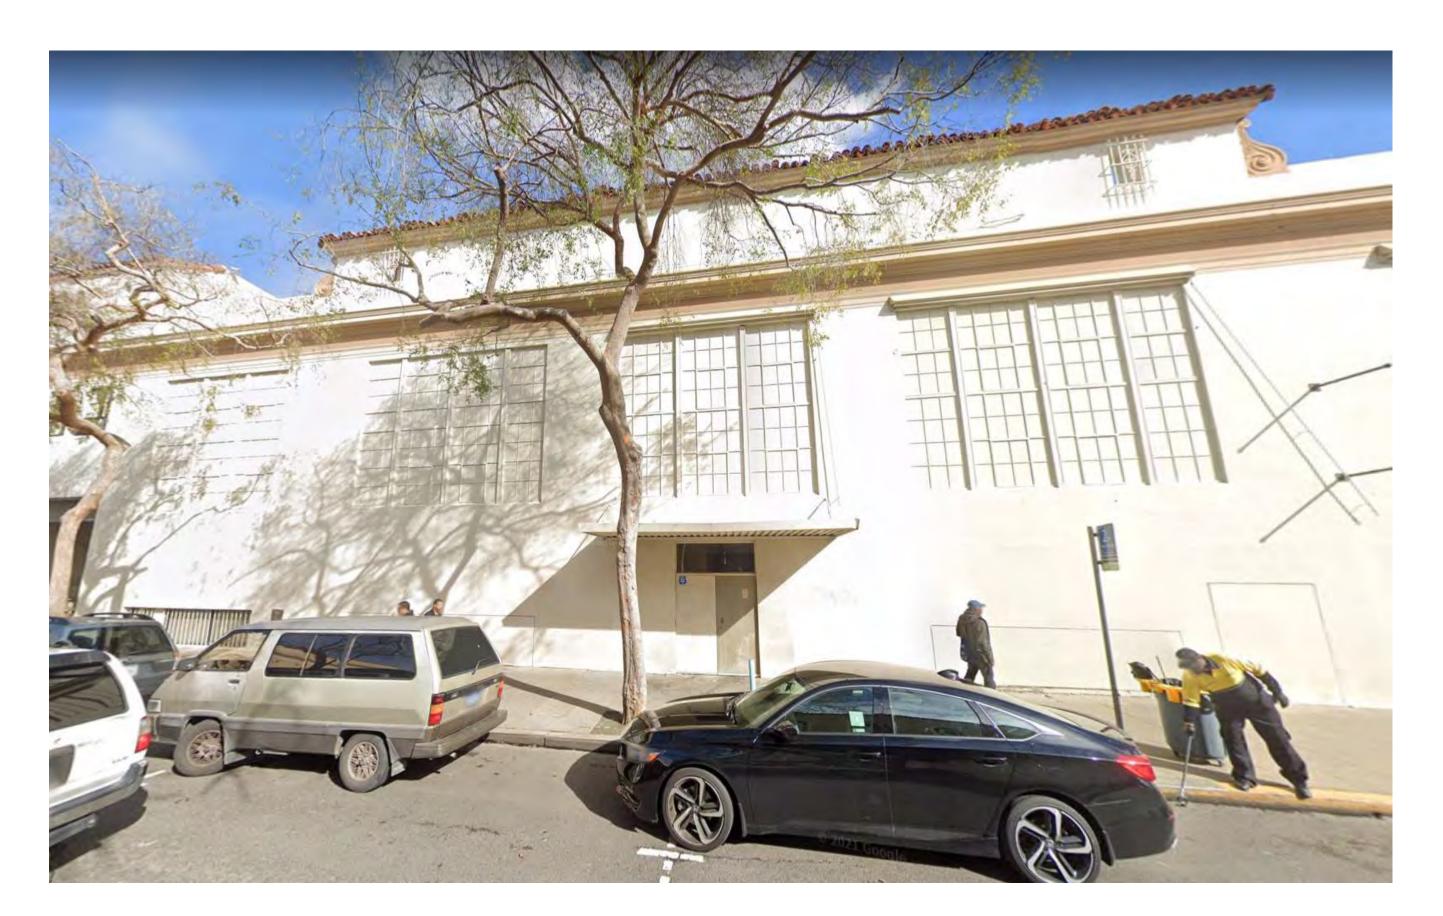

3 SITE PHOTO - HAROLD WAY SOUTH FACADE A0-002 12" = 1'-0"

PROJECT # : 121246 DRAWN BY: TF CHECKED BY: MM	
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3060 Peachtree Rd. N Suite 600 Atlanta, GA 30305	.W.
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www.nilesbolton.com	
BILL SCHRADER	
Т 925 638 8782	
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1SITE PHOTO - ALLSTON WAY - EXISTING HOTELA0-00312" = 1'-0"

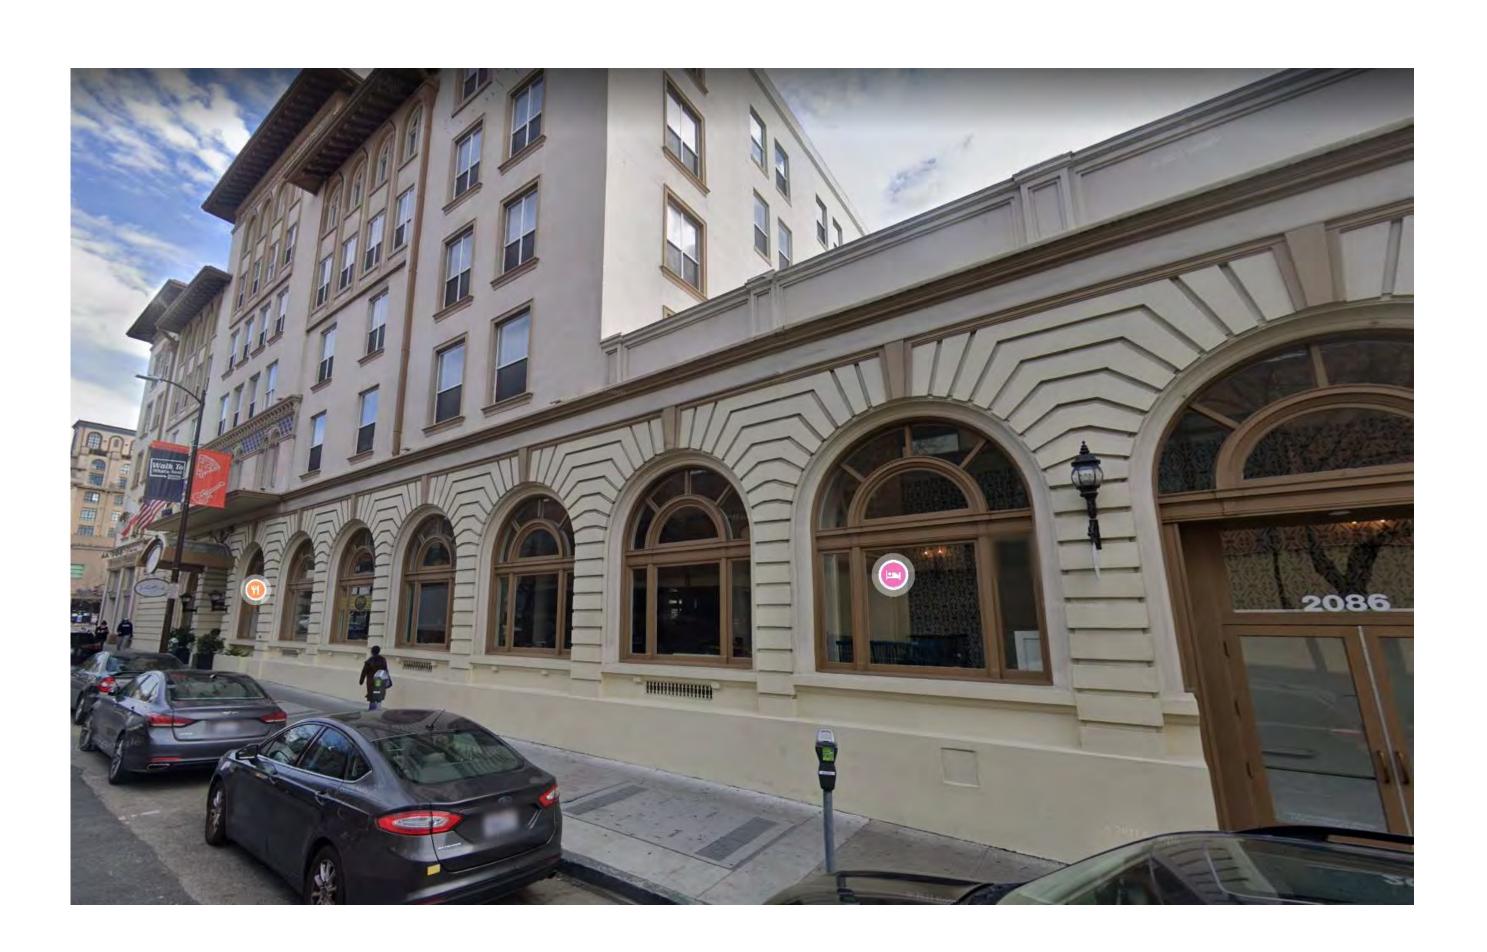

3 SITE PHOTO - SHATTUCK AVE AND ALLSTON WAY - EXISTING HOTEL A0-003 12" = 1'-0"



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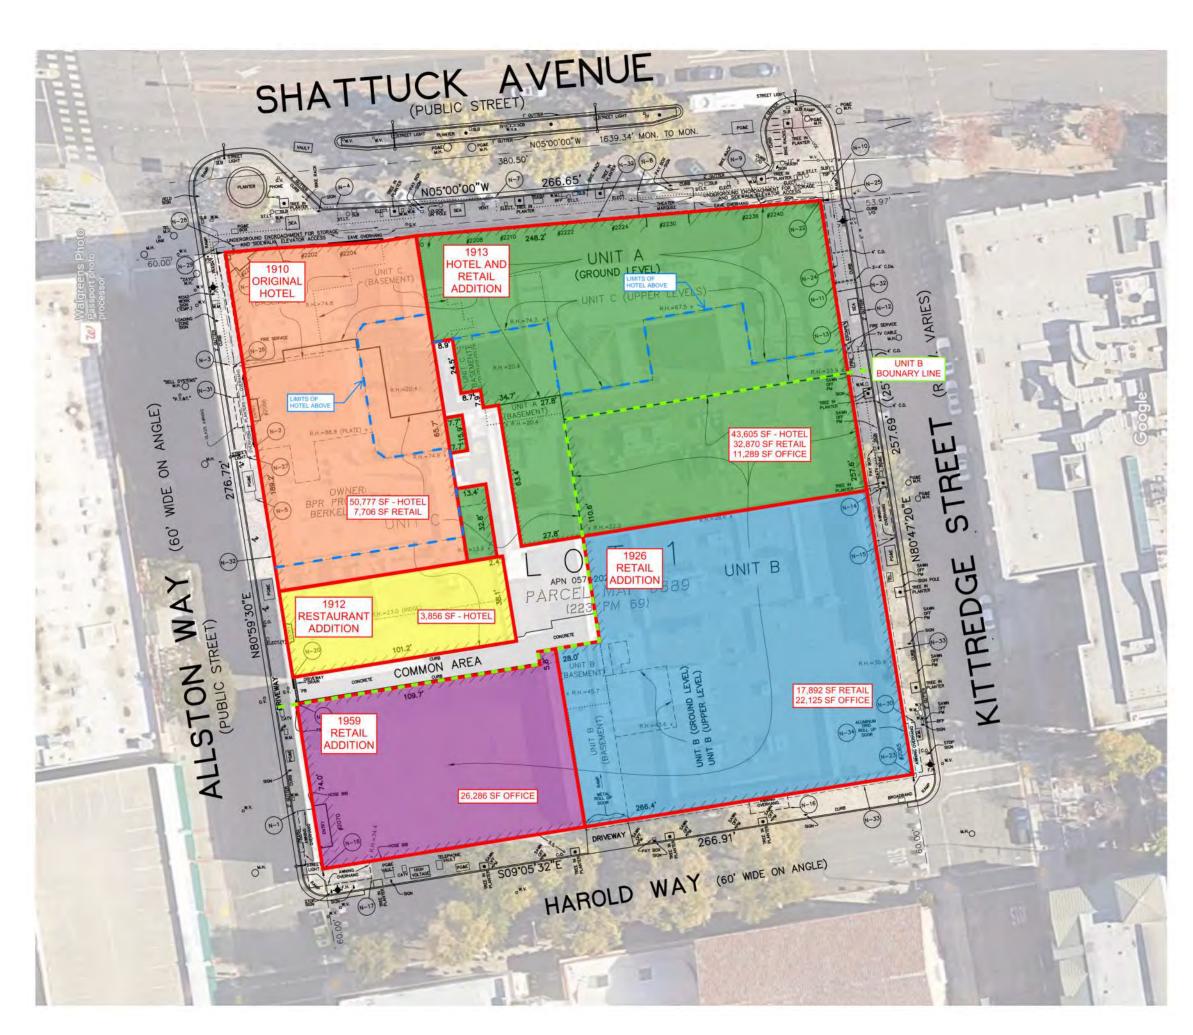


PROJECT # : 121246 DRAWN BY: TF CHECKED BY: MM **NILES BOLTON** ASSOCIATES 3060 Peachtree Rd. N.W. Suite 600 Atlanta, GA 30305 T 404 365 7600 www.nilesbolton.com APPLICANT: BILL SCHRADER Т 925 638 8782 Date Description 12/22/21 SAP SAP RESUBMIT. 3/23/22 JUNE LMRKS. MEETING 5/10/22 This drawing, as an instrument of service, is and shall remain the property of the Architects and shall not be reproduced, published or used in any way without the permission of the Architect. BERKELEY PLAZA 2065 KITTREDGE ST BERKELEY, CA 94704 CA VENTURES SHEET TITLE: EXISTING SITE PHOTOS


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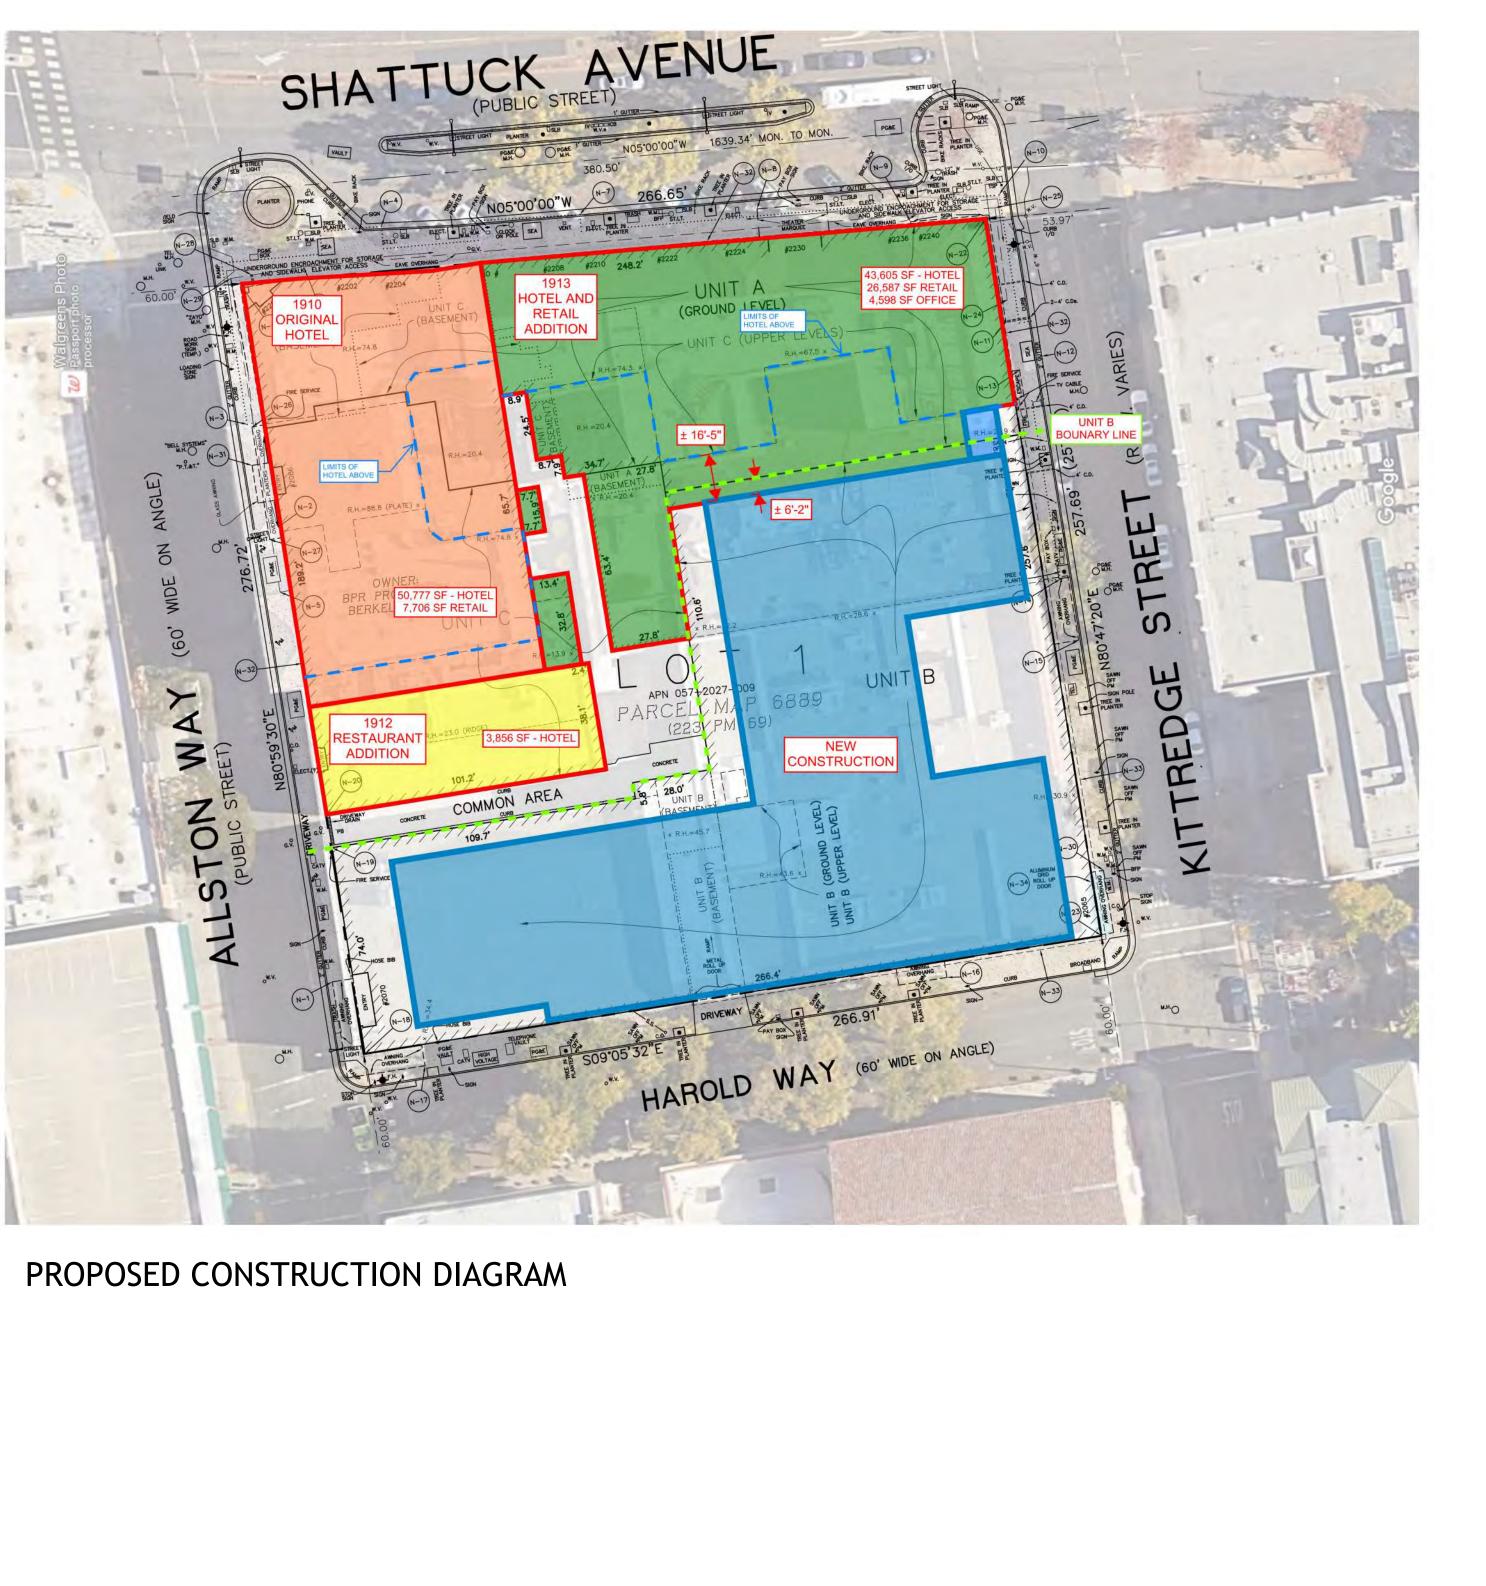
NOT RELEASED FOR CONSTRUCTION



EXISTING DIAGRAM



DEMO DIAGRAM

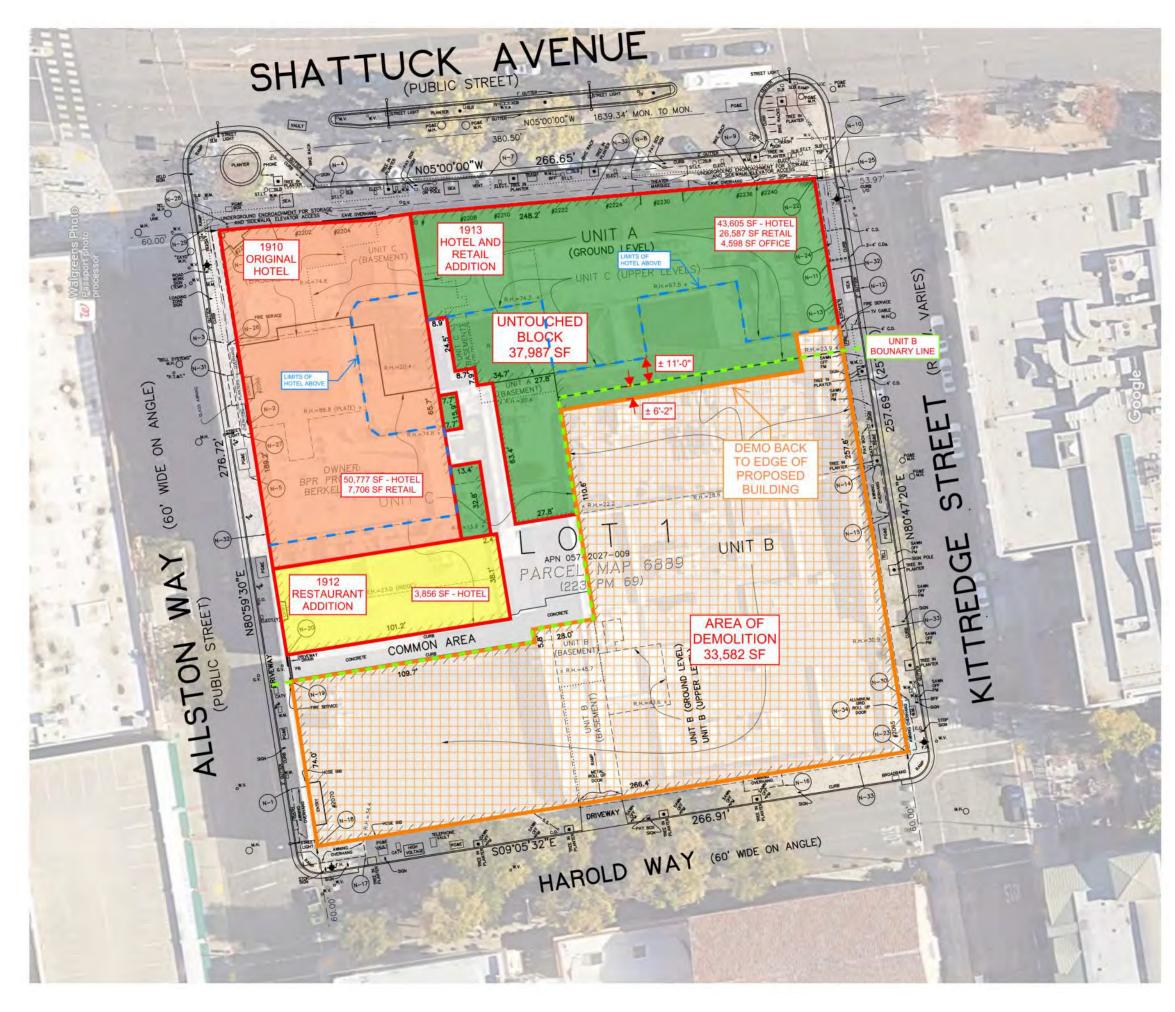

PROJECT # : 121246 DRAWN BY: TF CHECKED BY: MM **NILES BOLTON** ASSOCIATES 3060 Peachtree Rd. N.W. Suite 600 Atlanta, GA 30305 T 404 365 7600 www.nilesbolton.com APPLICANT: BILL SCHRADER Т 925 638 8782

Date Description 10/25/21 USE PERMIT USE PERMIT RESUBMIT. 12/10/2 SAP 12/22/2 SAP RESUBMIT 3/23/22 USE PERMIT RESUBMIT. 3/28/22 APRIL DRC MEETING 4/11/22 JUNE LMRKS. MEETING 5/10/22 This drawing, as an instrument of service, is and shall remain the property of the Architects and shall not be reproduced, published or used in any way without the permission of the Architect. BERKELEY PLAZA 2065 KITTREDGE ST BERKELEY, CA 94704 CA VENTURES SHEET TITLE: DEMO SITE PLAN EXHIBIT SHEET NUMBER:





UNIT MIX

Name S1 Bedrooms 1 Bathrooms 1 Beds 1 Unit GSF 436 Floor 8 Floor 7 Floor 6 Floor 5 Floor 4 Floor 3	1 1 6 381 1 - 1 - 1 - 1 - 1	1 1 1 1 1 1 31 375	5 S3 1 1 1	MS1-A 1		NS1 A1	-A A1-E	A2-A	A2-B	A3	B1-A	B1-B					-E B3-A	B3-B	I B4	B5	B6-A	B6-B	B7-A			B9					
Bathrooms 1 Beds 1 Unit GSF 436 Floor 8 Floor 7 Floor 6 Floor 5 Floor 4	1 - 1 - 1 -		1	-		1 1 3	1	1	1	1	2	2	2	2	2 2	2 2	2	2	2	2	2	2	2	в7-в 2	B8 2	2	C1 3	C2 3		Total Units	
Beds 1 Unit GSF 436 Floor 8 1 Floor 7 1 D Floor 6 Floor 5 1 Floor 4 1	1 - 1 - 1 -		1	1	1	1 1		1 ī	1	1	2	2	2	2	2 2	2 2	2	2	2	2	2	2	2	2	2	2	3	3	1.5		2010
Floor 8Floor 7Floor 6Floor 5Floor 4	1 - 1 - 1 -			ĩ	1	1 2	2	2	2	2	4	4	4	4	4 4	4 4	4	4	4	4	4	4	4	4	4	4	6	6	3		
Floor 8Floor 7Floor 6Floor 5Floor 4	1 - 1 - 1 -		1.1.1																												
D Floor 7 Floor 6 Floor 5 Floor 4	1 -	-	396	322	348 2	95 63	8 633	641	695	718	952	986	984	991 10	003 99	3 90	8 1030	973	953	956	962	909	977	932	953	971	1373	1374	867		
D Floor 6 Floor 5 Floor 4	1 -		1 -	2	-	1	2	1 2	-	-	4	1	-	-		-	1 -	1	1	1	-	1		1	1	-	100	1	-	23	69
Floor 5 Floor 4	-	-	1 -	2	1	1	1	1 2	+	+	4	1	1	1	-	1 -	-	1 –	1	1	1	-	1	-	1	1	1	1	-	27	86
Floor 4			1 -	2	1	1	1	1 2	+	-	4	1	1	1	-	1 -		1 -	1	1	1	-	1	-	1	1	1	1	-	27	86
	1 -		-	2	1	1	1	$\frac{1}{2}$	+	-	4	1	1	1	-	1 -		1 -	1	1	1		1	-	1	1	1	1	-	27	86
Floor 3	1 -	-	-	2	1	1	1	1 2	-	-	4	1	1	1	-	1 -		1 -	1 1	1	1	-	1	-	1	1	1	1	-	27	86
C Floor 2	1	1 -		2	1	1	2 -	-	2		4	1	1	1	1 -			1 -	1	1	1	-	1	-	1	1	1	1	-	27	86
A CONTRACTOR	1	1 -	-	-	-	-	3 -	-	-	1	4	4	-	-				1	1	1	1	-	-	-	1	-	-	-	-	23	66
Floor 1 -				-	-	-	2 -	-	-	-	T	-	-	-				-	-	-	-	-	-	-	-	-	-	-	4	- /	20
Floor -1 Total Units	7	2	5 1	1.4	5	7	12	5 10	2	1 1	29	10	5	5	1	1	1	5 2	7	7	6	1	5	1	7	E	5	6	1	188	585
	1	2	2 1	14	5	1	13	5 10 31	4	1 1	2.9	10	2			4		101	/	1	0	÷	5	1	/	2	1	1	4	100	202
Hait Min A®	2 1 1 0		1 1 0	70	2%	10 7			10	1.0	159	E 9.	2%	20	10 0	e 1	2 20		10	10	2%	10	2%	10	10	20		-	2%	0. af	
Unit Mix 4%	5 17	L% 3%	1%	16	36	4% 7	8 38	5%	1%	1%	15%	5%	3%	36	16 2	8 1	5 35	1%	46	48	26	16	35	1%	4%	3%	3%	3%	2%	% of	MIX
		-	22%				_	16%						_			-	54%			-	-		-	_		65	0	2%		
tal Bedrooms 7	2	5	1 1	14	5	7 13	5	10	2	1 1	58	20	10	10	2 8	2	10	4	14	14	12	2	10	2	14	10	15	18	4	311	
Bedroom Mix 2%	8 18	L% 2%	0%	5%	2%		% 2%	3%	1%	0%	19%	6%	3%		1% 3	% 1	39	18	5%	5%	4%	18	3%	18	5%	3%	5%	6%		100%	
	<u> </u>	20	00	50	20	20 1	0 20		10		120	0.0		50	10 5		0 00	10	1 00	50	10	4.0	50	10	50	50	50	0.0	10	1000	
Total Beds 7	2	2 5	1	14	5	7 26	5 10	20	4	2	116	40	20	20	4 16	5 4	20	8	28	28	24	4	20	4	28	20	30	36	12	585	
18	8 08	10	0.0	2%	1%	1% 4		3%	10	0%		70																			
Bed Mix			0%		10		0 40	20	10	05	205 1	18	38	38	18 3	8 1	8 38	18	5%	5%	48	18	3%	18	5%	38	5%	6%	2%	100%	
)% 1%	0%	20	1.0	10 4	0 20	11%	18	0%	20%	78	3%	38	1% 3	8 1	8 38	1% 69%	5%	5%	4%	1%	3%	1%	5%	3%	5% 11	6% %	2% 2%	100%	
S1 S2- 1 1 1 1 1 1	2-A S: 1 1		0% 3 MS1- 1 1 1 1			A1-A 1 1 2	° 2° A1−B 1 1 2	11%	A2-B 1 1 2	A3 1 1 2	B1-A 2 2 4	B1-B 2 2 4	3% B2-A 2 2 4	3% В2-В 2 2 4	1% 3 B2-C 2 2 4	8 1 B2-D 2 2 4		69%	B3-B 2 2 4	5% B4 2 2	4% B5 2 2 4	1% B6-A 2 2	3% B6-B 2 2	1% B7-A 2 2	5% В7-В 2 2	3% B8 2 2 4				100% LW-J 1 1.5 3	
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1 1 1 1 1 1 436 38	1 1 1 81 3	S2-B 1 1 1 375 3	3 MS1- 1 1 1 1 1 1 96 322	A MS1-E 1 1 1 348	NS1 1 1 1 295	A1-A 1 1 2 638	A1-B 1 1 2 633	11% A2-A 1 2 641			B1-A 2 2 4 952	B1-B 2 2 4 986					B2-E 2 2 4 908	69%	B3-B 2 2 4 973		B5 2 2 4 956	1% B6-A 2 2 4 962	3% B6-B 2 2 4 909		В7-В 2 2 4 932	B8 2 2 4 953	B9 2 2 4 971		2% C2 3 3 6 1374	LW-7 1 1.5 3 867	
1 1 1 1 1 1 436 38 r 8 436 -	1 1 1 81 3	S2-B 1 1 375 375	3 MS1- 1 1 1 1 1 1 96 322 - 6	A MS1-E 1 1 1 348 4 -	NS1 1 1 1 295 295	A1-A 1 1 2 638 1,276	A1-B 1 1 2 633 633	11% A2-A 1 1 2 641 1,282	A2-B 1 1 2	A3 1 1 2	B1-A 2 2 4 952 3,808	B1-B 2 2 4 986 986	B2-A 2 2 4 984	B2-B 2 2 4 991 -	B2-C 2 2 4	B2-D 2 2 4 993 -	B2-E 2 2 4 908 908	69% B3-A 2 2 4 1030 -	B3-B 2 2 4	B4 2 2 4 953 953	B5 2 2 4 956 956	2 2 4 962 -	2 2 4	B7-A 2 2 4 977	В7-В 2 2 4	B8 2 2 4 953 953	11 B9 2 2 4 971 -	° C1 3 3 6 1373 −	2% C2 3 3 6 1374 1,374	LW-7 1 1.5 3 867	
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$ \begin{array}{cccccccccccccccccccccccccccccccccccc$	1 1 1 81 3 - -	S2-B 1 1 375 375 375 375	3 MS1- 1 1 1 1 1 1 96 322 - 6 - 6 - 6	A MS1-E 1 1 1 348 4 - 4 348 4 348	NS1 1 1 295 295 295 295 295	A1-A 1 1 2 638 1,276 638 638 638	A1-B 1 2 633 633 633 633	11% A2-A 1 1 2 641 1,282 1,282 1,282	A2-B 1 1 2	A3 1 1 2 718 -	B1-A 2 2 4 952 3,808 3,808 3,808	B1-B 2 2 4 986 986 986 986	B2-A 2 2 4 984 - 984 984	B2-B 2 2 4 991 - 991 991	B2-C 2 2 4	B2-D 2 2 4 993 - 993 993	B2-E 2 2 4 908 908 -	69% B3-A 2 2 4 1030 - 1,030 1,030	B3-B 2 2 4 973	B4 2 2 4 953 953 953	B5 2 2 4 956 956 956 956	2 2 4 962 	2 2 4 909 909	B7-A 2 2 4 977 - 977 977	В7-В 2 2 4 932	B8 2 2 4 953 953 953 953	11 B9 2 2 4 971 - 971 971 971	% C1 3 3 6 1373 − 1,373 1,373	2% C2 3 3 6 1374 1,374 1,374 1,374	LW-2 1 1.5 3 867 4 - 4 - 4 -	
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1 1 1 1 1 1 1 1 436 38 r 8 436 - r 7 436 - r 6 436 - r 5 436 - r 5 436 - r 3 436 - r 3 436 - r 2 436 - r 1 - - r 1 - -	1 1 1 1 81 3 381 381	S2-B 1 1 1 375 375 375 375 375 375 375 375	3 MS1- 1 1 1 1 96 322 - 6 - 6 - 6 - 6 - 6 - 6 - 6 - 6	A MS1-E 1 1 1 348 4 - 4 348 4 348 4 348 4 348 4 348 4 348 4 - -	NS1 1 1 1 295 295 295 295 295 295 295 295 295 295	A1-A 1 1 2 638 1,276 638 638 638 638 638 638 1,276 1,914 1,276	A1-B 1 2 633 633 633 633 633 633 633 633 633 7 -	11% A2-A 1 1 2 641 1,282 1,282 1,282 1,282 1,282	A2-B 1 1 2 695 - - - - 1,390 -	A3 1 1 2 718 - - - - - - 718	B1-A 2 2 4 952 3,808 3,808 3,808 3,808 3,808 3,808 3,808 3,808 3,808	B1-B 2 2 4 986 986 986 986 986 986 986 986 3,944	B2-A 2 2 4 984 984 984 984 984 984 984 984 984 	B2-B 2 2 4 991 991 991 991 991 991 991 	B2-C 2 2 4 1003 	B2-D 2 2 4 993 993 993 993 993 993 1 	B2-E 2 2 4 908 908 	69% B3-A 2 2 4 1030 - 1,030 1,030 1,030 1,030 1,030 1,030 1,030 1,030 1,030	B3-B 2 2 4 973 973 973 - - - - - - - - - - - - - - - - - - -	B4 2 2 4 953	B5 2 2 4 956 956 956 956 956 956 956 956 956 956 956 956 956 956 956 956 956	2 2 4 962 962 962 962 962 962 962 962	2 2 4 909 	B7-A 2 2 4 977 - 977 977 977 977 977 977 977	B7-B 2 2 4 932 932 - - - - - - - - - - - - -	B8 2 2 4 953 953 953 953 953 953 953 953 953 953	B9 2 2 4 971 - 971 971 971 971 971 971 971 - -	% C1 3 6 1373 - 1,373 1,373 1,373 1,373 1,373 1,373 1,373 - - - - - - - - - - - - - - - - - - -	2% C2 3 3 6 1374 1,374 1,374 1,374 1,374 1,374 1,374 1,374 1,374 1,374	LW-1 1 1.5 3 867 4 4 4 4 4 4 4 4 -	58

Name																																			
Naille	ie	S1	S2-A	S2-B	S3	MS1-A	MS1-B	NS1	A1-7	A A1-B	A2-A	A2-B	A3	B1-A	B1-B	B2-A	B2-B	B2-C	B2-D 1	32-E	B3-A	В3-В	В4	B5	B6-A	B6-B	B7-A	в7-в	B8	В9	C1	C2	LW-A	Total	Total
Bed	lrooms	1	1	1	1	1	1	1	1	1	1	1	1	2	2	2	2	2	2	2	2	2	2	2	2	2	2	2	2	2	3	3	1 [Units	Beds
Bat	hrooms	1	1	1	1	1	1	1	1	1	1	1	1	2	2	2	2	2	2	2	2	2	2	2	2	2	2	2	2	2	3	3	1.5		
Beds	ls	1	1	1	1	1	1	1	2	2	2	2	2	4	4	4	4	4	4	4	4	4	4	4	4	4	4	4	4	4	6	6	3		
Un	it GSF	436	381	375	396	322	348	295	638	633	641	695	718	952	986	984	991	1003	993	808	1030	973	953	956	962	909	977	932	953	971	1373	1374	867		
Floo	or 8	1	1	1	-	2	÷		1	2 1	. 2	-	-	4	1	-	+	-	-	1	+	1	1	1	÷	1	ŧ	1	1	-	÷	1	-	23	69
Floo	or 7	1	+	1	-	2	1		1	1 1	. 2	+	+	4	1	1	1	-	1	+	1	-	1	1	1	-	1	+	1	1	1	1	-	27	86
WOOD Floc	or 6	1	-	1	-	2	1	8	1	1 1	. 2	+	-	4	1	1	1	-	1	-	1	-	1	1	1	-	1	-	1	1	1	1	-	27	86
Floo	or 5	1	-	1	-	2	1		1	1 1	. 2	+	-	4	1	1	1	-	1	-	1		1	1	1	-	1	-	1	1	1	1	-	27	86
Floc	or 4	1	-	1	-	2	1		1	1 1	. 2	+	-	4	1	1	1	-	1	+	1		1	1	1	-	1	+	1	1	1	1	-	27	86
Floc	or 3	1	1	-	-	2	1	1 T	1	2 -	-	2	-	4	1	1	1	1	-	-	1	1-1-1	1	1	1	-	1	-	1	1	1	1	-	27	86
CONC Floo	or 2	1	1	-	1	2	-		1	3 -	-	+	1	4	4	-	-	-	-	+	+	1	1	1	1	-	-	-	1	-	-	-	-	23	66
Floc	or 1	-	-	-	-	-	-	+	3	2 -	-	-	-	1	÷	-	+	24 July 1	-	+	4	-	+	-	÷		+	-	+	-	-	-	4	7	20
Flor	or -1																							1	_										-
Total	L Units	7	2	5	1	14	5		7 1	.3 5	5 10	2	1	29	10	5	5	1	4	1	5	2	7	7	6	1	5	1	7	5	5	6	4	188	585
							-	1.00			31											101									11		4		
Un	nit Mix	4%	1%	3%	1%	7%	3%	4%	78	3%	5%	1%	1%	15%	5%	3%	3%	1%	2%	1%	3%	1%	4%	4%	3%	1%	3%	1%	48	3%	3%	3%	2%	% of 1	lix
					22%						16%		0							0		54%		2							6%		2%		
1.1.1.1.1.1.1.1		1.74	1.1	1.11.1		1.16.1				. U	1.755			Contraction of the	100 U U	N. V. MIL		1	1.11	9. V			1.1.1	1.10		1.1.1.1.1.1	2.5		1.11						
Total Be	edrooms	7	2	5	1	14	5	7	13	5	10	2	1	58	20	10	10	2	8	2	10	4	14	14	12	2	10	2	14	10	15	18	4	311	
Bedro	oom Mix	2%	1%	2%	0%	5%	2%	2%	4%	2%	3%	1%	0%	19%	6%	3%	3%	1%	3%	1%	3%	1%	5%	5%	4%	1%	3%	1%	5%	3%	5%	6%	1%	100%	
Tot	al Beds	7	2	5	1	14	5	7	26	10	20	4	2	116	40	20	20	4	16	4	20	8	28	28	24	4	20	4	28	20	30	36	12	585	
D.	ed Mix	1%	0%	1%	0%	2%	1%	1%	4%	2%	3%	1%	0%	20%	7%	3%	3%	1%	3%	1%	3%	1%	5%	5%	4%	1%	3%	1%	5%	3%	5%	6%	2%	100%	
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9			40 P		NO1	3 V01		NS1	21.2	41 D	A2-A	А2-В	Δ3	D1 3	D1 D	B2-A	в2-в	B2-C	B2-D		E B3-		3-в	54	DE	B6-A	B6-B	B7-A	87-B	20	50	01		TNLA	mater 3
	S1	S2-A	S2-B	S3	MS1-2	A MS1	в г	1	A1-A	A1-B	AZ-A	AZ-D	1	B1-A	B1-B	52-A	<u>Б2</u> -Б 2	2	B2-D	B2-I	ະ າ	-A D.	2	D4	2	2 DO-A	2	57-A	2	2	2	3	C2	LW-A	Total
	1	-	1	-	1	1		4		1	1	1	-	2	2	2	2	2	2	2	2		2	2	2	2	2	2	2	2	2	3	2	1 5	
	1	-	1	-	-	1		1	1	1	1	1	1	2	2	4	2	4	2	2	2		4	2	4	4	4	2	2	2	4	5	5	1.5	
		1	1	-				+	2	2	2	2	2	4	4	4	4	4	4	4	4		4	4	4	4	4	4	4	4	4	0	0	3	
	436	381	375	396	322			295	638	633	641	695	718	952	986	984	991	1003	993	908	and the second second		73		956	962	909	977	932	953	971	1373	1374		
Floor 8	436	=	375		64				1,276	633	1,282	-		3,808	986		-		-	-	- 80		973	953	956	=	909	-	932	953	-	-	1,374		17,693
Floor 7	436	÷	375		64			295	638	633	1,282	-	-	3,808	986	984	991	-	993		1,0		-	953	956	962		977	+	953	971	1,373			21,962
Floor 6	436	-	375		64			295	638	633	1,282	-		3,808	986	984	991	-	993	-	1,0		-	953	956	962	-	977	-	953	971	1,373		_	21,962
Floor 5	436	-	375		64			295	638	633	1,282	-	-	3,808	986	984	991	-	993	-	1,0		-	953	956	962	-	977	-	953	971	1,373			21,962
Floor 4	436	+	375	-	64		348	295	638	633	1,282	-	-	3,808	986	984	991	-	993	-	1,0		-	953	956	962	+	977	÷	953	971	1,373			21,962
Floor 3	436	381	-	-	64		348		1,276	+	-	1,390	-	3,808	986	984	991	1,003	-	-	1,0		-	953	956	962	-	977	-	953	971	1,373	1,374	+	22,091
Floor 2	436	381	-	396	5 64	4 -	-		1,914	-	-	-	718	3,808	3,944	-	-	-	-	-	-	-	973	953	956	962	-	-	-	953	-	-	-	+	17,333
Floor 1	-		-	-	-	-	-	-	1,276	-	-	-	-	952	-	-	-	-	-	-	-		-	-	-	-	-	-	-	-	-	-	-	3,46	5,696
Floor -1					-	-								-	-	-	-	-	-	-			-	-	-	-	-	-	-	-	-	-	-	-	-
	3,052	762	1,875	396	5 4,50	8 1,7	740 2,	,065	8,294	3,165	6,410	1,390	718	27,608	9,860	4,920	4,955	1,003	3,972	90	08 5,1	150 1,	946	6,671 6	692	5,772	909	4,885	932	6,671	4,855	6,865	8,244	3,46	8 150,661
r	AVG.	351							AVG.	644				AVG.	967																	AVG.	1,374		7

AREA TABLE


Floors	GSF	Common	Utility	Res.	Amenity / Lobby	Retail	Parking	Exterior SF (not in GSF)	# Units	# Parking	Efficiency	Height
Floor 8	22,755	3,511	440	17,739	1,065	÷		2,946	23		78.0%	85
Floor 7	26,150	3,694	417	22,039	-		÷		27	6 S	84.3%	74
Floor 6	26,150	3,694	417	22,039			-		27		84.3%	64
Floor 5	26,150	3,694	417	22,039		= =		=	27		84.3%	54
Floor 4	26,150	3,694	417	22,039	-		÷		27		84.3%	44
Floor 3	26,150	3,694	417	22,039	· · · ·		-	÷	27		84.3%	34
Floor 2	24,002	3,709	628	17,541	2,124	-	-	-	23		73.1%	24
Floor 1	23,818	3,025	3,850	4,203	5,434	4,181	3,125		7		17.6%	14
Floor -1	19,657	878	1,023			+	17,756	-		43	0.0%	(10
Total	220,982	29,593	8,026	149,678	8,623	4,181	20,881	2,946	188	43		

EXISTING SITE DESCRIPTION

THE USE OF THE THE PROPOSED PROJECT IS A MIX-USED OFF-CAMPUS APPROXIMATELY 95,000 SF STUDENT HOUSING COMMUNITY THAT CONTAINS 188 EXISTING BUILDING UNITS (585 BEDS). THE PROJECT UNIT TYPES INCLUDE STUDIOS, 1 BEDROOM, 2 BEDROOM, 3 BEDROOM, AND INCLUDES SERVICE AND OFFICE SPACE LIVE/WORK UNITS. (APPROXIMATELY 3,000 RSF) ON 4 LEVELS THE BUILDING TOTALS 220,982 GSF, WHICH (BASEMENT THROUGH INCLUDES 149,687 SF OF RESIDENTIAL AREA AND PARTIAL THIRD FLOOR). 8,623 SF OF INDOOR RESIDENTIAL AMENITY AREA IN THERE WERE NO PREVIOUS ADDITION TO 2,946 SF OF ELEVATED ROOF TERRACE **RESIDENTIAL USES ON THE** AMENITY. THERE IS ALSO 4,181 SF OF GROUND LEVEL PROJECT SITE. THE ENTIRE COMMERCIAL. EXISTING BUILDING AND BASEMENT WILL BE THE PROJECT IS DESIGNED AS TYPE-IIIA DEMOLISHED WITHIN THE CONSTRUCTION (WOOD) OVER TYPE-IA (PODIUM) PROPERTY BOUNDARY. WITH A TOTAL OF 8 RESIDENTIAL LEVELS. A PARTIAL

PROPOSED PROJECT DESCRIPTION

BASEMENT IS ALSO PROVIDED TO HOUSE 43 PARKING SPACES. ADDITIONALLY, THE PROJECT WILL PROVIDE 129 BIKE PARKING SPACES ON LEVEL 1.

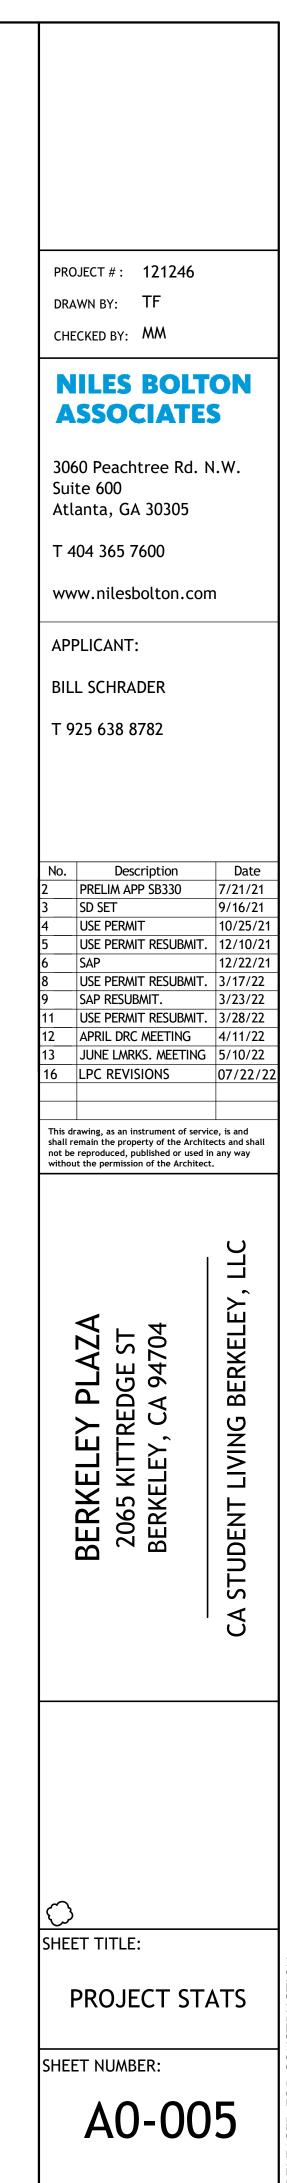

CONSTRUCTION	INFORMATION
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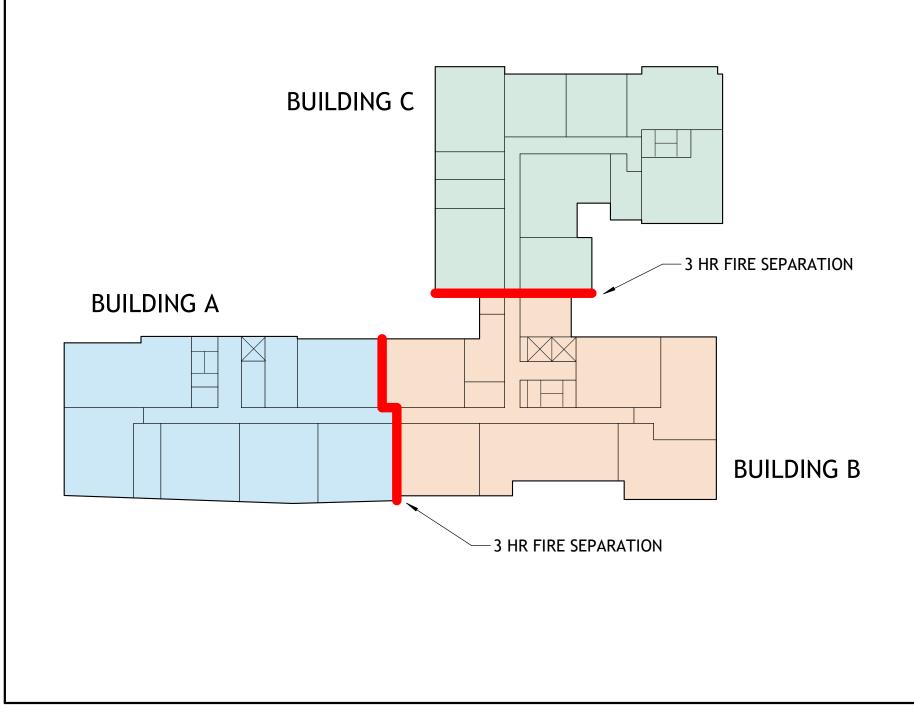
	BERKEL	EY PLAZA		
CONSTRUCTION TYPE	5 LEVELS OF TYPE I AND 1 BASEMENT LI		N OVER 3 LEVELS O	F TYPE IA
SPRINKLER SYSTEM	NFPA 13			
CLIMATE ZONE	3			
SEISMIC CATEGORY	D			
JURISDICTION	CITY OF BERKELEY			
	BUILDING HEIG	HTS AND AREAS		
		NSTRUCTION		
	MAX ALLOWABLE S			
BUILDING HEIGHT, PER CBC TABLE				
504.3 AND 504.4	MAX ALLOWABLE H		-	
	ACTUAL HEIGHT (AE	A VE A LOCK BOOK BOOK AND A	: 84'	
BUILDING AREA, PER CBC TABLE 506.2 [At+(NS x If)]xSa	LEVEL	BLDG A AREA	BLDG B AREA	BLDG C AREA
	4	8,441 SF	8,841 SF	8,727 SF
	5	8,441 SF	8,841 SF	8,727 SF
	6	8,441 SF	8,841 SF	8,727 SF
	7	8,441 SF	8,841 SF	8,727 SF
	8	5,268 SF	8,784 SF	8,629 SF
TOTAL PROPOSED BUILD	7	39,032 SF	44,148 SF	43,537 SF
At: Tabular Area per Table 506.2 SM NS: Tabular Area Factor for non Sprinkled If: Frontage Increase Sa: 2 (R Occupancy)		24,000 + (24,000 X 0) X2 =	24,000 + (24,000 X 0) X2 =	24,000 + (24,000 X 0) X2=
TOTAL ALLOWABLE	AREA	48,000 SF	48,000 SF	48,000 SF
	TYPE IA CO	NSTRUCTION		
	MAX ALLOWABLE S	TORIES: UNLIMITE	D	
BUILDING HEIGHT PER CBC TABLE	ACTUAL STORIES: 3			
504.3 AND 504.4	MAX ALLOWABLE H	EIGHT: UNLIMITED	0	
	ACTUAL HEIGHT (AE	BOVE AVG GRADE)	: 34'	
BUILDING AREA, PER CBC TABLE	TOTAL ALLOWABLE		0	
506.2	TOTAL PROPOSED A	REA: 98,305 SF		
FIRE RESISTANCE RA	TING REQUIREMENT		I EMENTS PER TABI	F 601
BUILDING ELEMENT	REQUIRED HO		the second states and states	OURLY RATING
	TYPE IA	TYPE IIIA	TYPE IA	TYPE IIIA
PRIMARY STRUCTURAL FRAME	3	1	3	1
EXTERIOR BEARING WALL	3	2	3	2
INTERIOR BEARING WALL	3	1	3	1
NON-BEARING EXTERIOR WALL	2	2	2	2
FLOOR CONSTRUCTION	2	1	2	1
ROOF CONSTRUCTION	1.5	1	1.5	1
ACCESSIBILITY PROVISIONS				
UNITS	ALL UNITS TO COMP HARBOR. ALL UNITS 1128A.1		1997년 전 전 전 전 전 전 전 전 전 전 전 전 전 전 전 전 전 전 전	120 H X 17 F AL L AND
PUBLIC AREAS	ALL AREAS OF COM WITH 2010 ADA AC			

CODE INFORMATION

systems.

WAIVER/CONCESSION LIST

- allowed by right.
- setbacks above 75'



EXITS TO BE 1/3 DIAGONAL OF THE LENGTH OF THE MAXIMUM OVERALL DIAGONAL DIMENSION OF THE AREA SERVED, MEASURED ALONG THE SHORTEST DIRECT LINE OF TRAVEL WITHIN A ONE HOUR RATED CORRIDOF

AREAS OF REFUGE NOT REQUIRED PER CBC 1009.3 EXCEPTION 8


The proposed project will comply with the Berkeley Energy Code (BMC Chapter 19.36) and Berkeley Green Code (BMC Chapter 19.37), adopted by City Council on December 3rd., 2019, where building design must incorporate all-electric

• <u>Waiver</u> to exceed the height limit -Proposed at 87'-0", where 60 ft/75 ft with use permit is the limit. The 87'-0" proposed is measured to top of roof and does not include the additional 5 feet parapet

• <u>Waiver</u> to construct rooftop projections, such as mechanical appurtenances or architectural elements which exceed the maximum heigh limit for the district. • <u>Waiver</u> to reduce the 15' minimum front

• <u>Waiver</u> to increase the 5' maximum front setbacks between 0' to 20'

• <u>Waiver</u> to reduce the minimum landscape coverage of usable open space from 40% of the provided usable open space to 25% of the provided usable open space • <u>Waiver</u> to reduce the required parking spaces for the commercial spaces from 6 required spaces to 0 provided spaces. • <u>Concession</u> for 20% reduction in useable open space and the percentage of associated landscaped area.

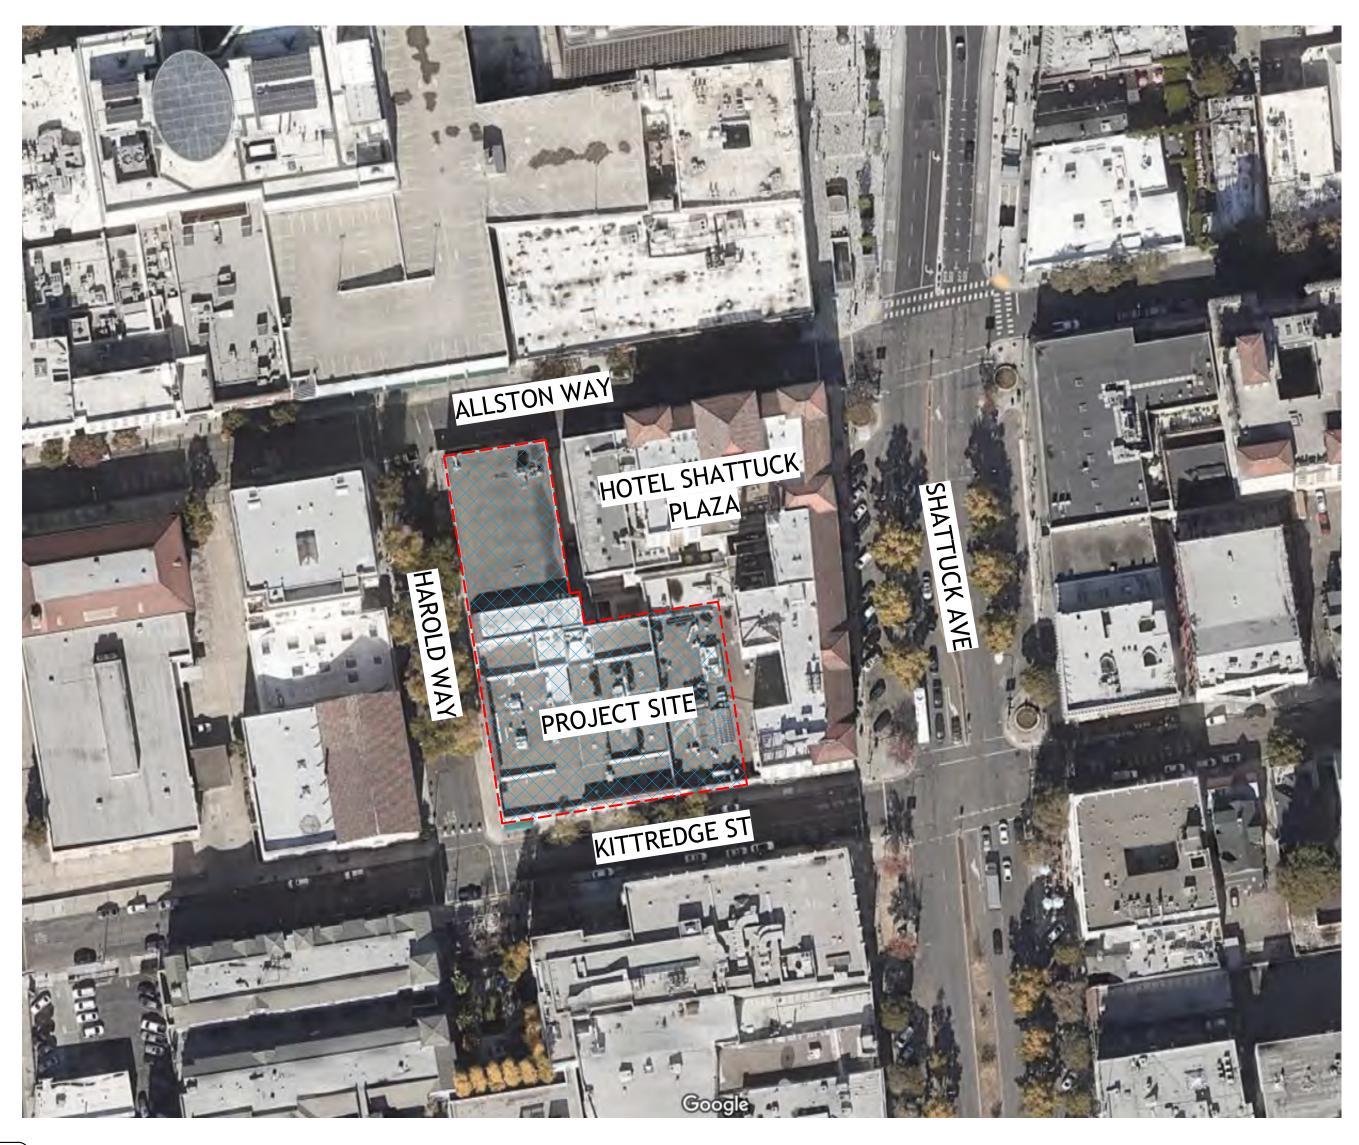

1 SITE MAP A0-006 12" = 1'-0"

TABULATION FORM

PROJECT ADDRESS: 2065 KITTREDGE ST APPLICANT'S NAME: BILL SCHRADER

DATE: 07-22-22 ZONING DISTRICT: C-DMU CORE

UNIT, PARKING SPACES, AND BEDROOMS	Existing	Proposed	Permitted/ Required		COMMERCIAL SPACE REQUIREMENTS	Existing	Proposed	Permitted/ Required	
NUMBER OF DWELING UNITS	0	188	NA	-	4,181 SF TOTAL 1,717 SF ALLSTON RETAIL SUITE				
NUMBER OF PARKING SPACES MAX 0.5 SPACES PER UNIT	0	43	0 MIN 94 MAX	-	949 SF KITTREDGE RETAIL SUITE 1,515 SF WORK SPACE IN LIVE/WORK UNITS				
NUMBER OF BIKE PARKING SPACES 311 BEDROOMS 1 LONG TERM SPACE PER 3 BEDROOMS = 104 SPACES 1 SHORT TERM SPACE PER 40 BEDROOMS = 8 SPACES	0	129 LOCATED ON LEVEL 1	112	-	NUMBER OF PARKING SPACES 1.5 SPACES PER 1,000 SF OF RETAIL SUITE = 4 SPACES 1 SPACE PER FIRST 1,000 SF OF WORK AREA AND 1 SPACE PER ADDITIONAL 750 SF OF WORK AREA = 2 SPACES	0	0	6	WAIV
ARDS AND HEIGHTS				-	NUMBER OF BIKE PARKING SPACES 1 BIKE SPACE PER 2,000 SF OF COMMERCIAL FLOOR AREA	0	3	3	
FRONT YARD SETBACK (FT)			0' MIN (0'-75' HEIGHT)	-	SPACES LOCATED AT EXTERIOR BIKE RACKS				
	0'	0'	15' MIN (75'+ HEIGHT) 5' MAX (0'-20' HEIGHT)	WAIVER	USEABE OPEN SPACE	0	84	84	-
BUILDING HEIGHT (STORIES)	3	8	-	WAIVER	1 SF OF USABLE OPEN SPACE PER 50 SF OF COMMERCIAL FLOOR AREA	U	04	04	
MAXIMUM (FT)	25'	87'	-	WAIVER					
REAS				-					
LOT AREA	33,582 SF	33,582 SF	-	-					
TOTAL GROSS FLOOR AREA TOTAL AREA COVERED BY ALL FLOORS	92,531 SF	186,126 SF	-						
BUILDING FOOTPRINT	33,582 SF	27,619 SF	-						
LOT COVERAGE	100%	82%	-						
USEABLE OPEN SPACE 80 SF OF USABLE OPEN SPACE PER UNIT	0	12,032 SF	15,040 SF	CONCESSION					
FLOOR AREA RATIO	2.8:1	5.5:1	-						



PROJECT # : 121246 DRAWN BY: TF CHECKED BY: MM NILES BOL ASSOCIAT 3060 Peachtree Rd Suite 600 Atlanta, GA 30305 T 404 365 7600 www.nilesbolton.c APPLICANT: BILL SCHRADER	TON ES . n.w.
No. Description 4 USE PERMIT 5 USE PERMIT RESUBM 6 SAP 7 USE PERMIT RESUBM 8 USE PERMIT RESUBMIT. 11 USE PERMIT RESUBMIT. 12 APRIL DRC MEETING 13 JUNE LMRKS. MEETIN 16 LPC REVISIONS This drawing, as an instrument of sa shall remain the property of the Arr not be reproduced, published or us without the permission of the Architer	12/22/21 IT. 1/11/22 IT. 3/17/22 3/23/22 IT. 3/28/22 4/11/22 IG 5/10/22 07/22/22 IT. IT. IT. IT. 3/23/22 IT. 3/23/22 IT. 3/28/22 4/11/22 IG 5/10/22 07/22/22
BERKELEY PLAZA 2065 KITTREDGE ST BERKELEY, CA 94704	CA STUDENT LIVING BERKELEY, LLC
SHEET TITLE: ZONING AND INFO SHEET NUMBER: AO-O(


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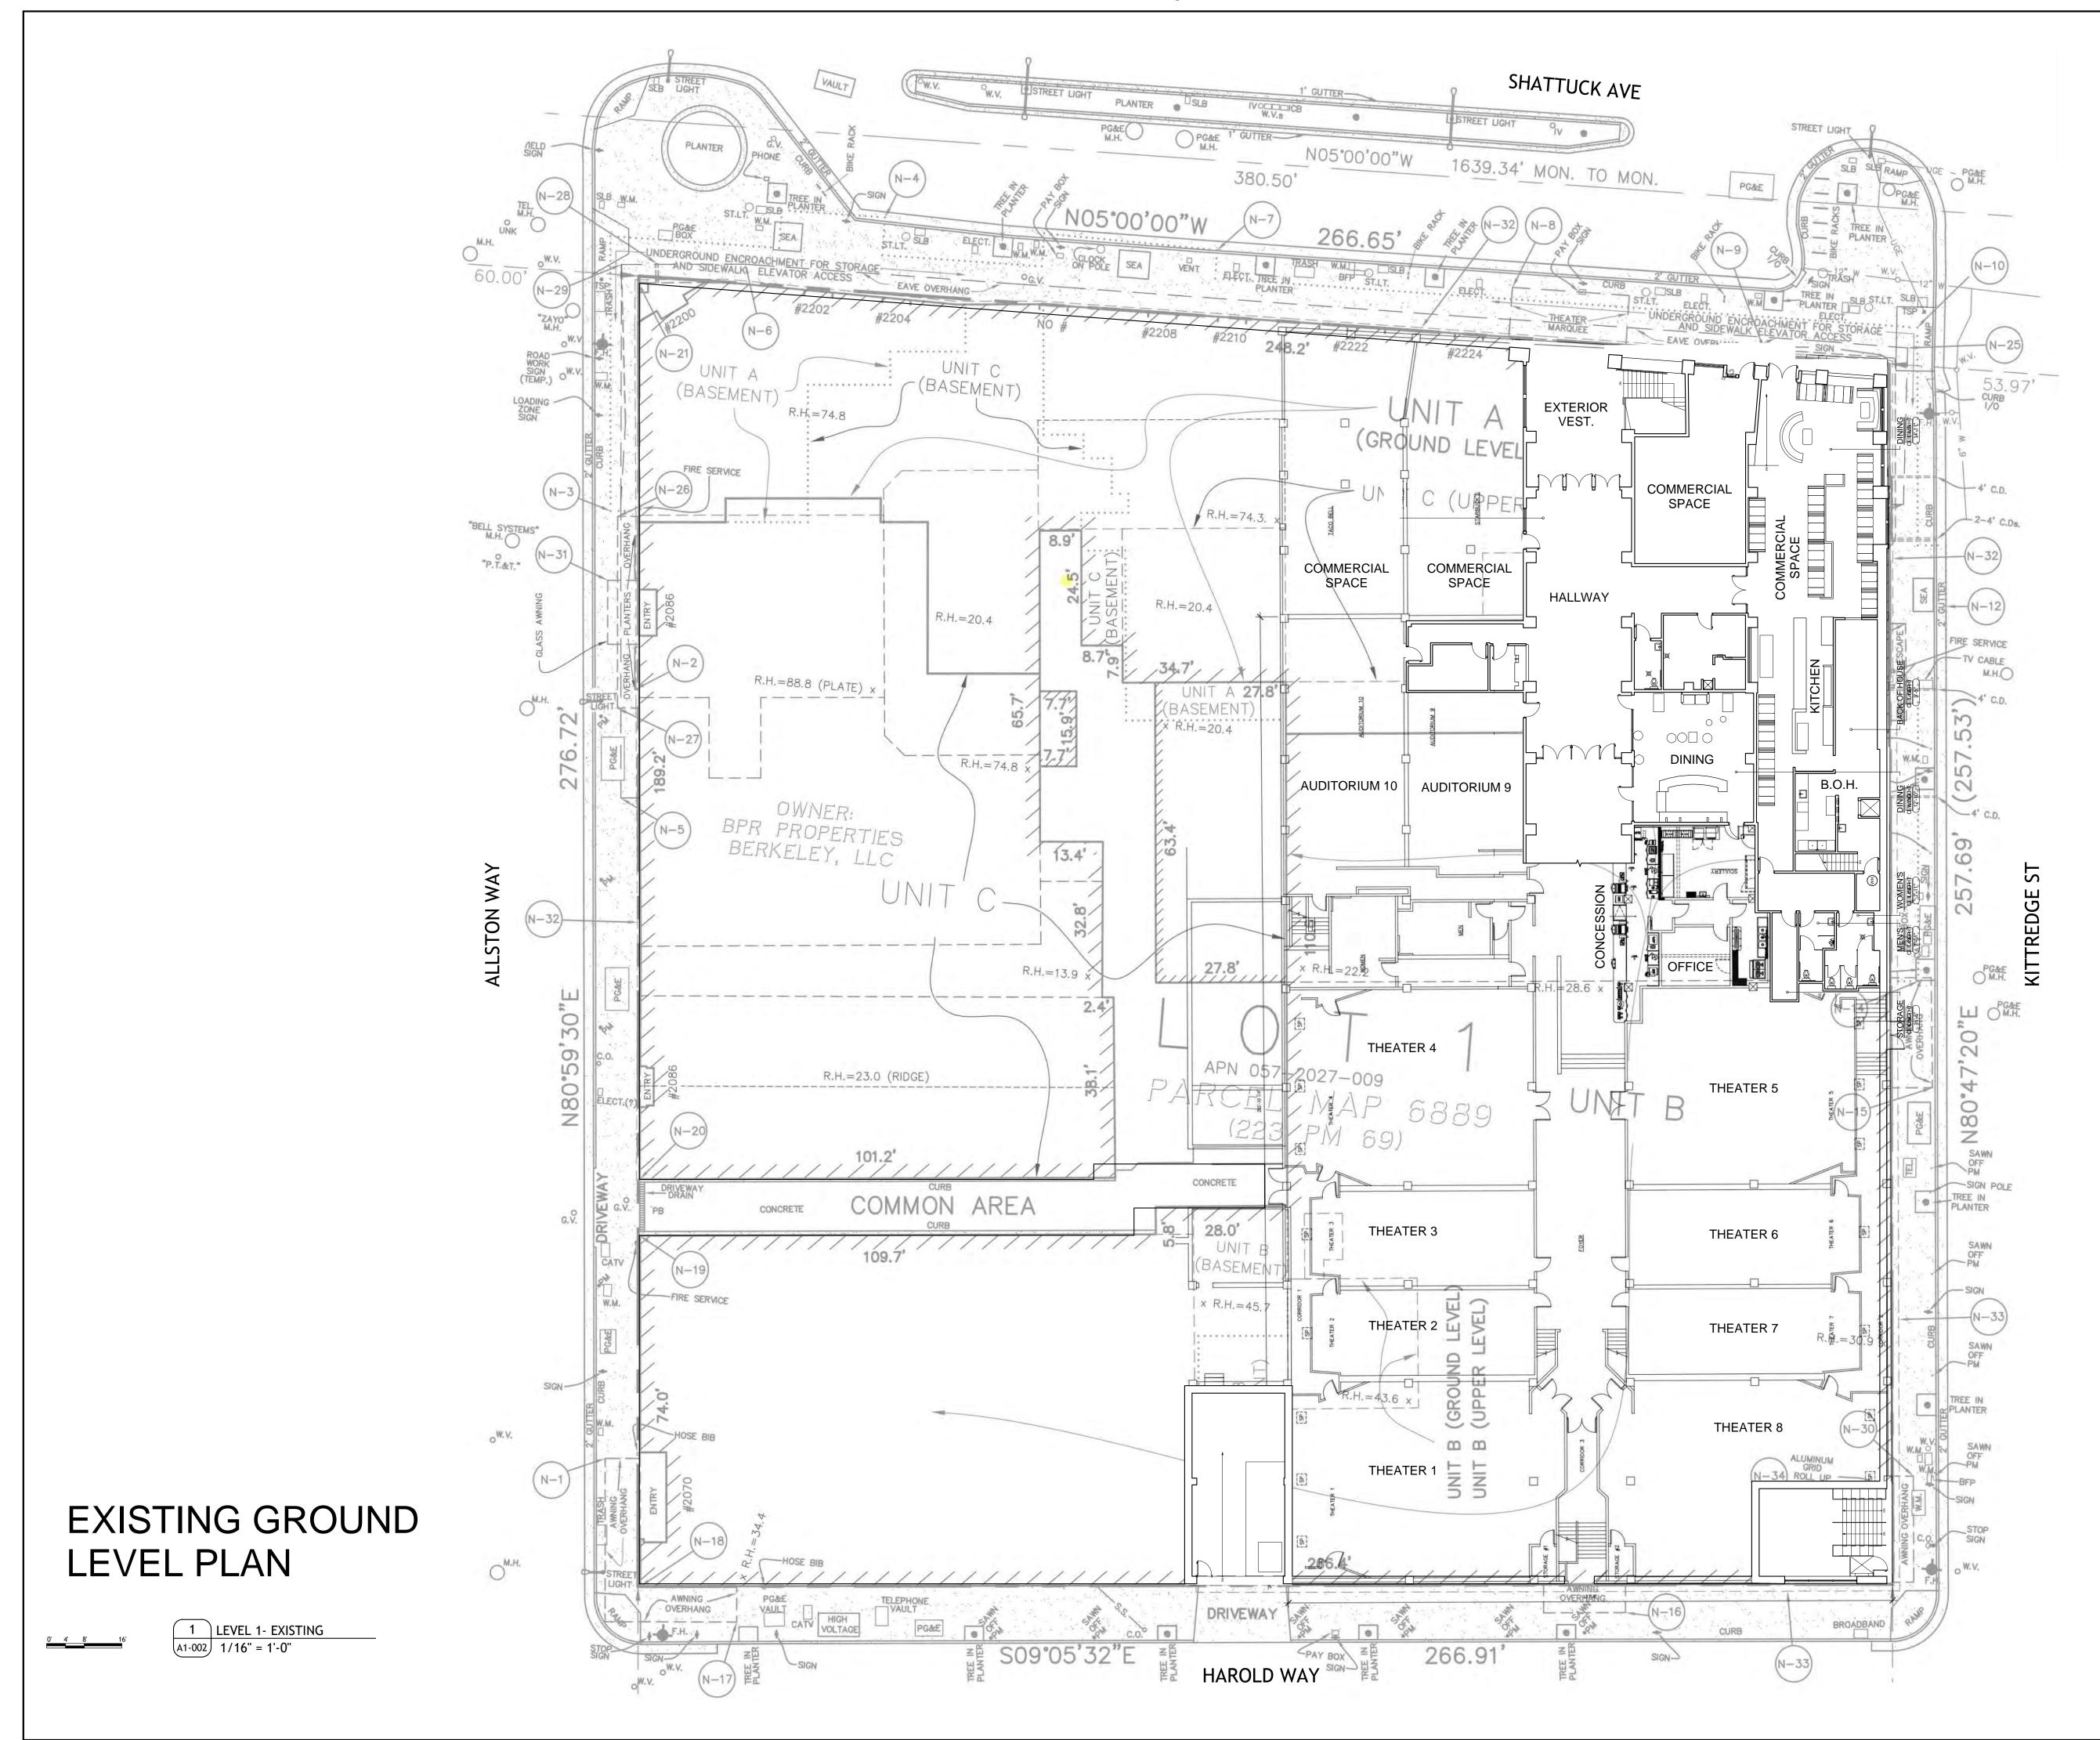
ON WAY ALLST






1 LEVEL U1- EXISTING A1-001 1/16" = 1'-0"



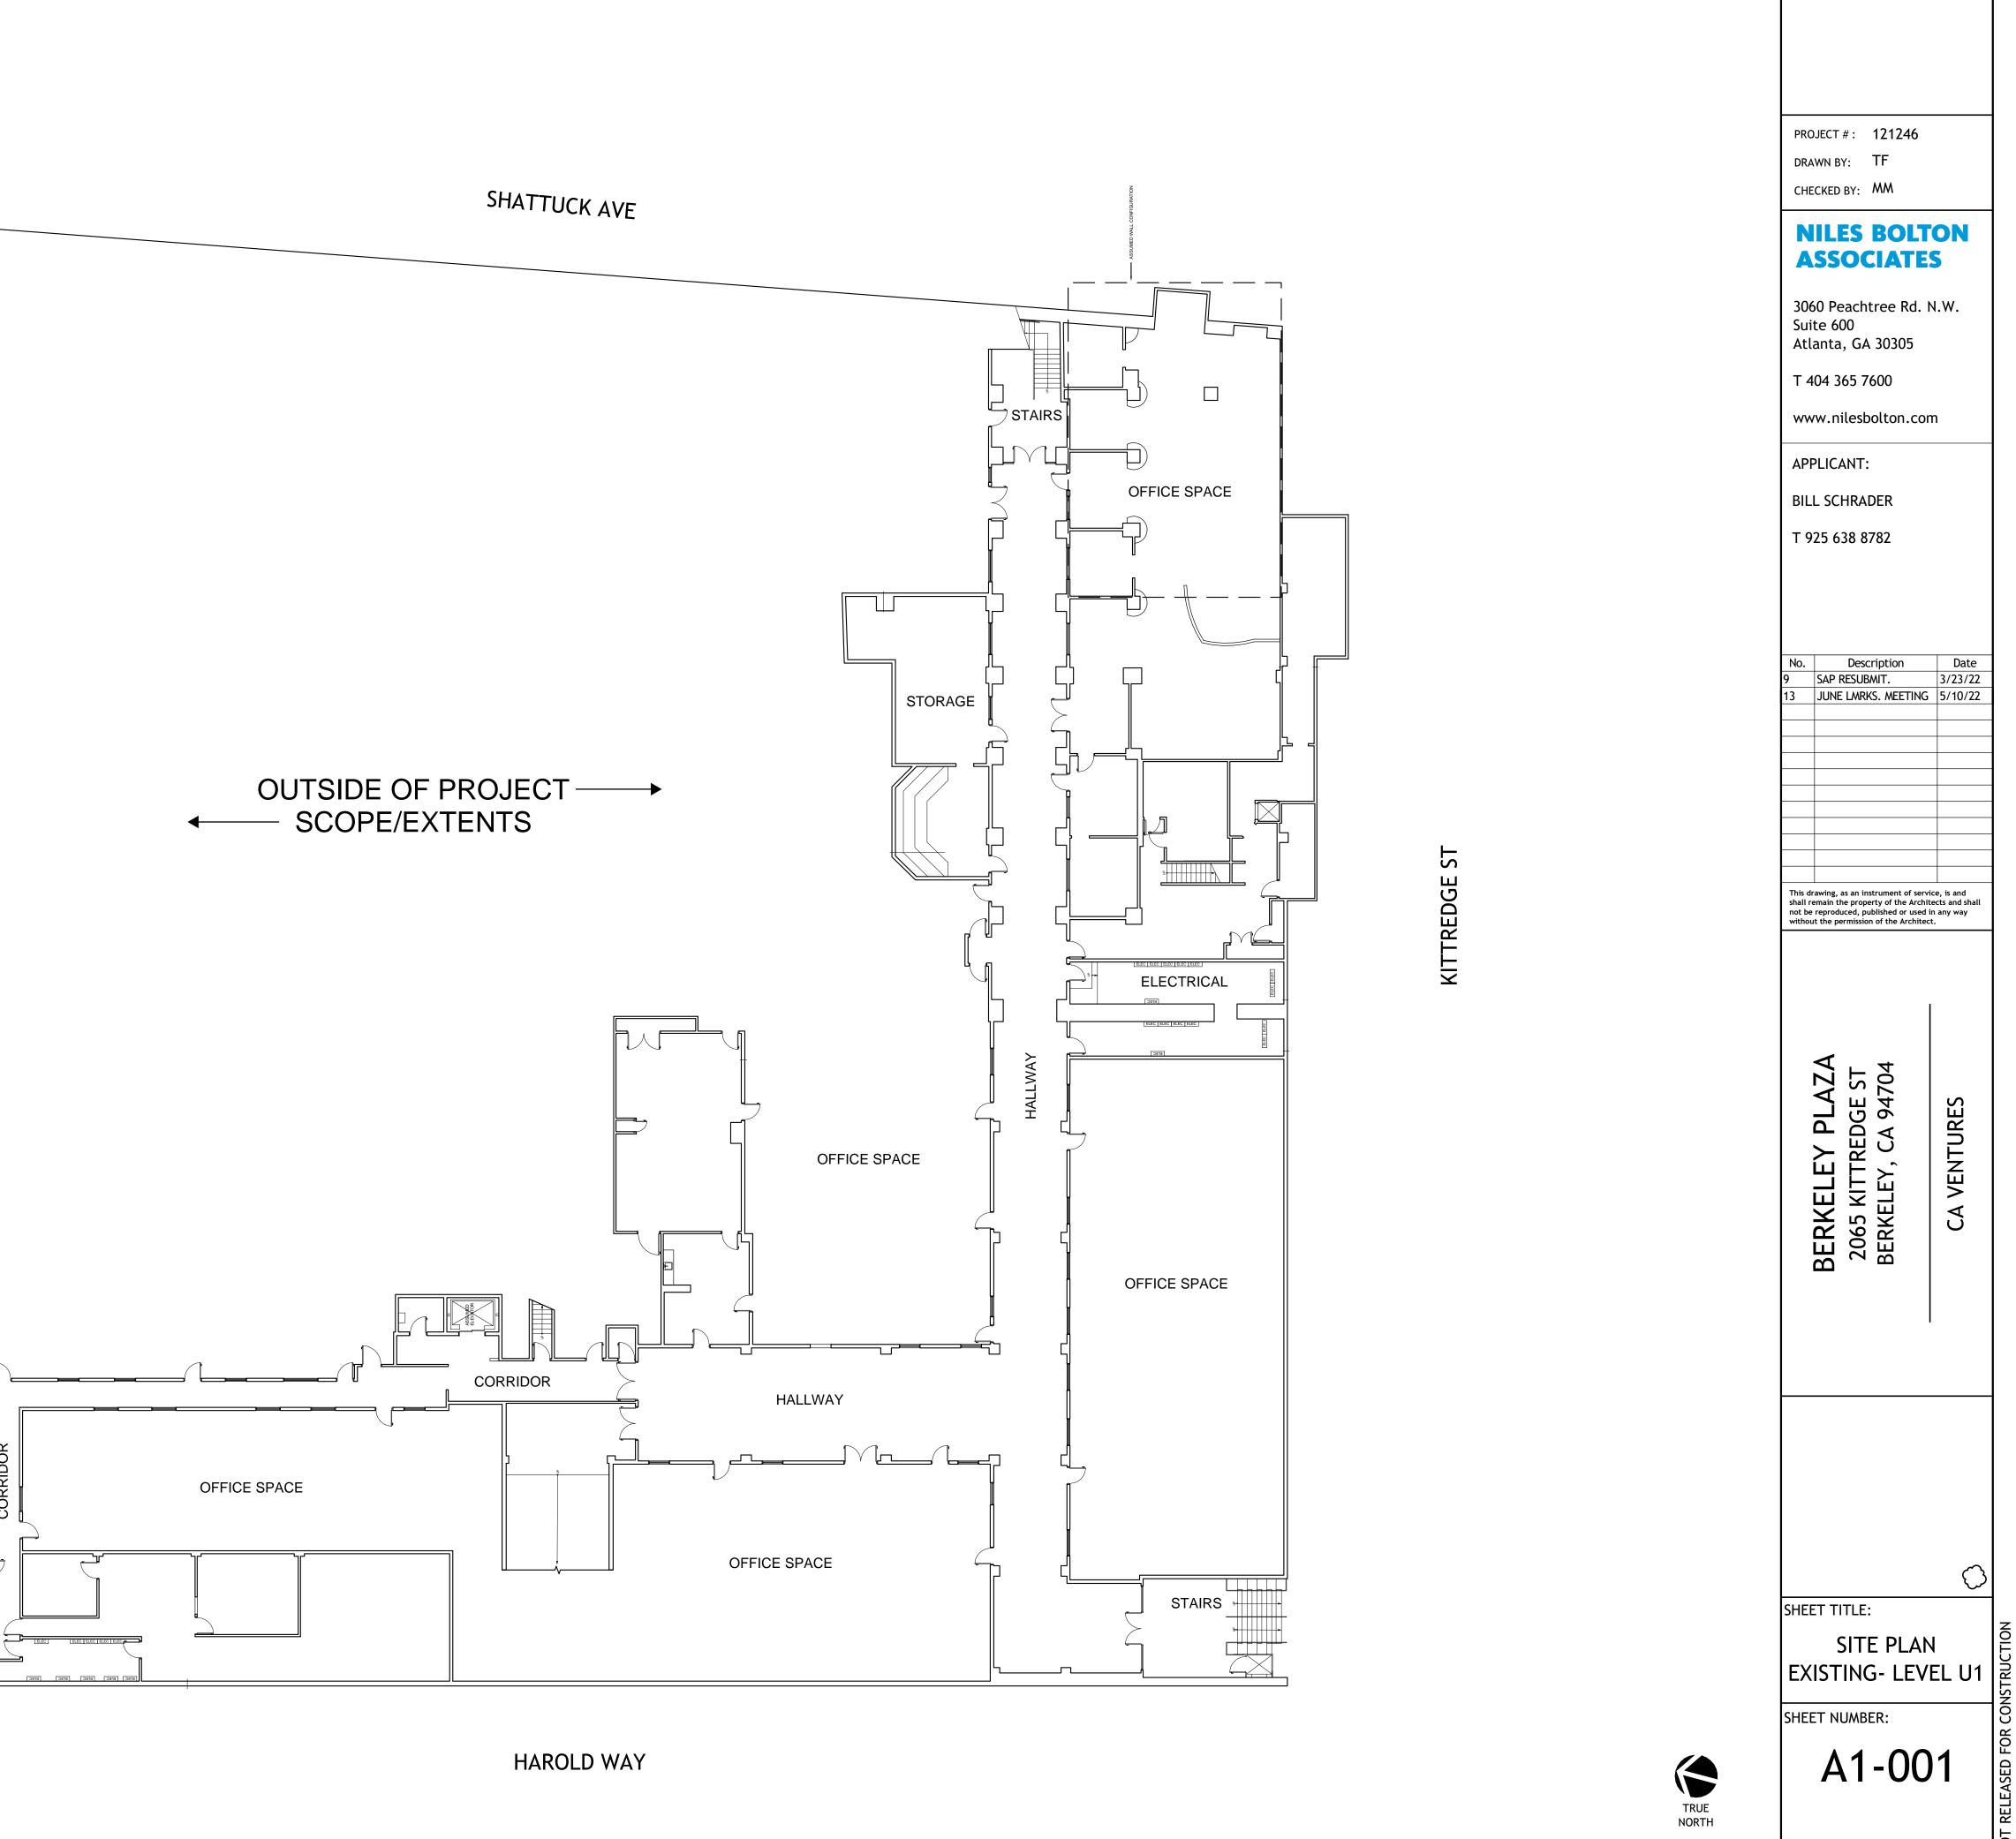

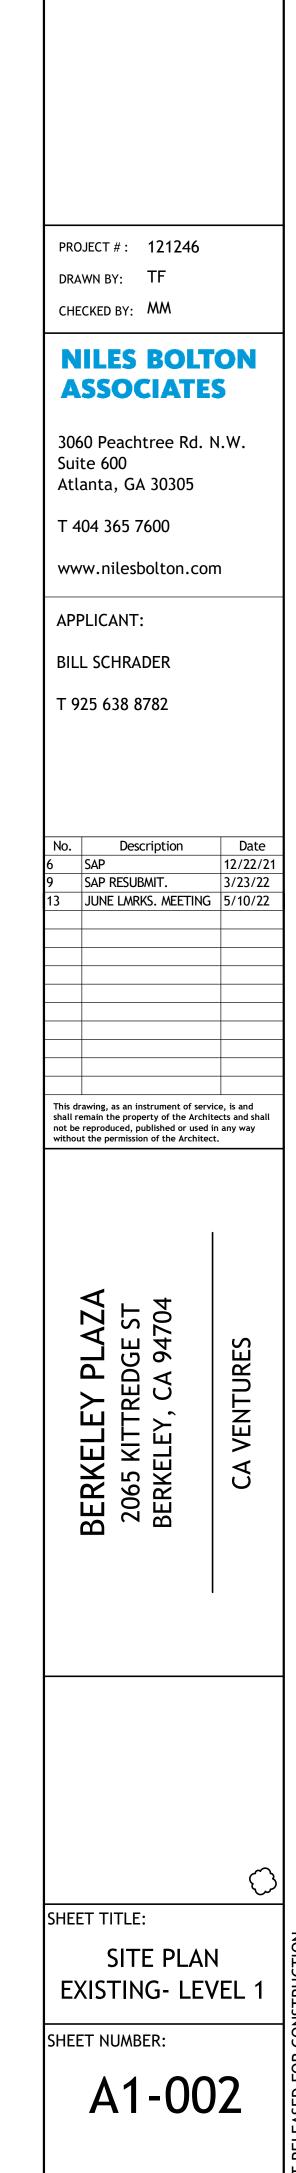


TRUE NORTH

WAΥ NO ALLST


PROPOSED BASEMENT PLAN

0' 4' 8'


1 LEVEL U1- PROPOSED A1-003 1/16" = 1'-0"

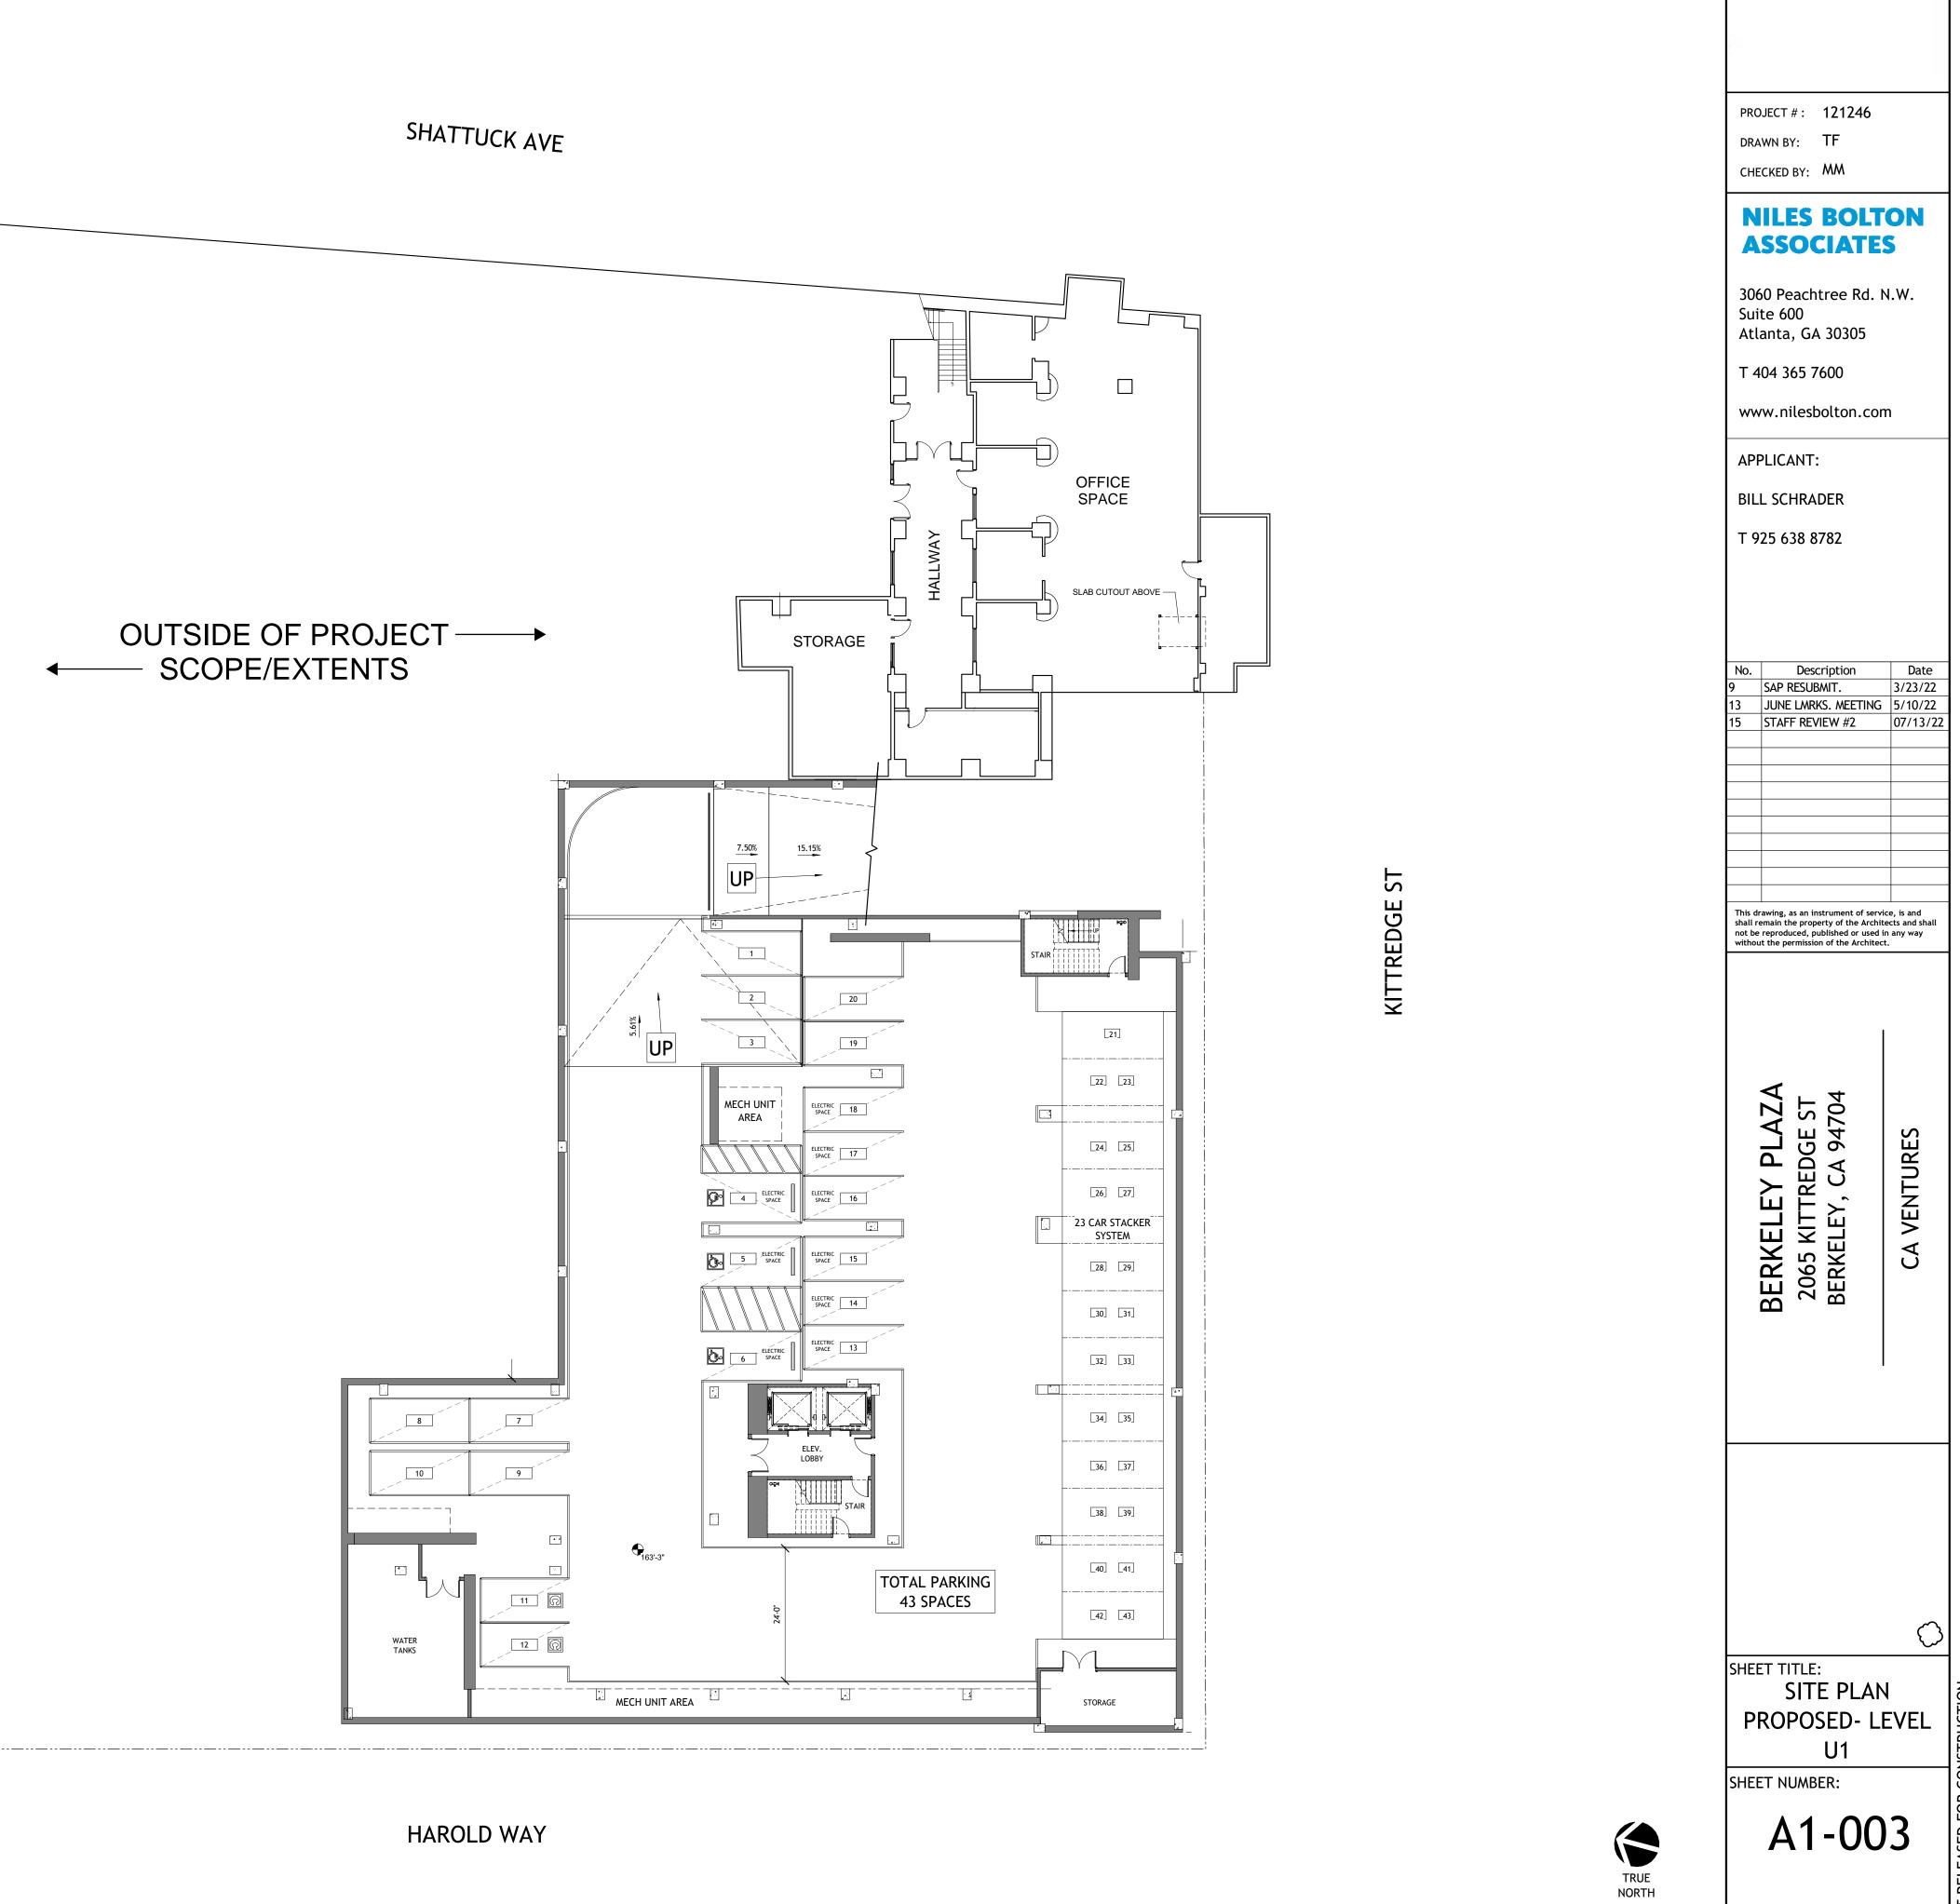

\SED

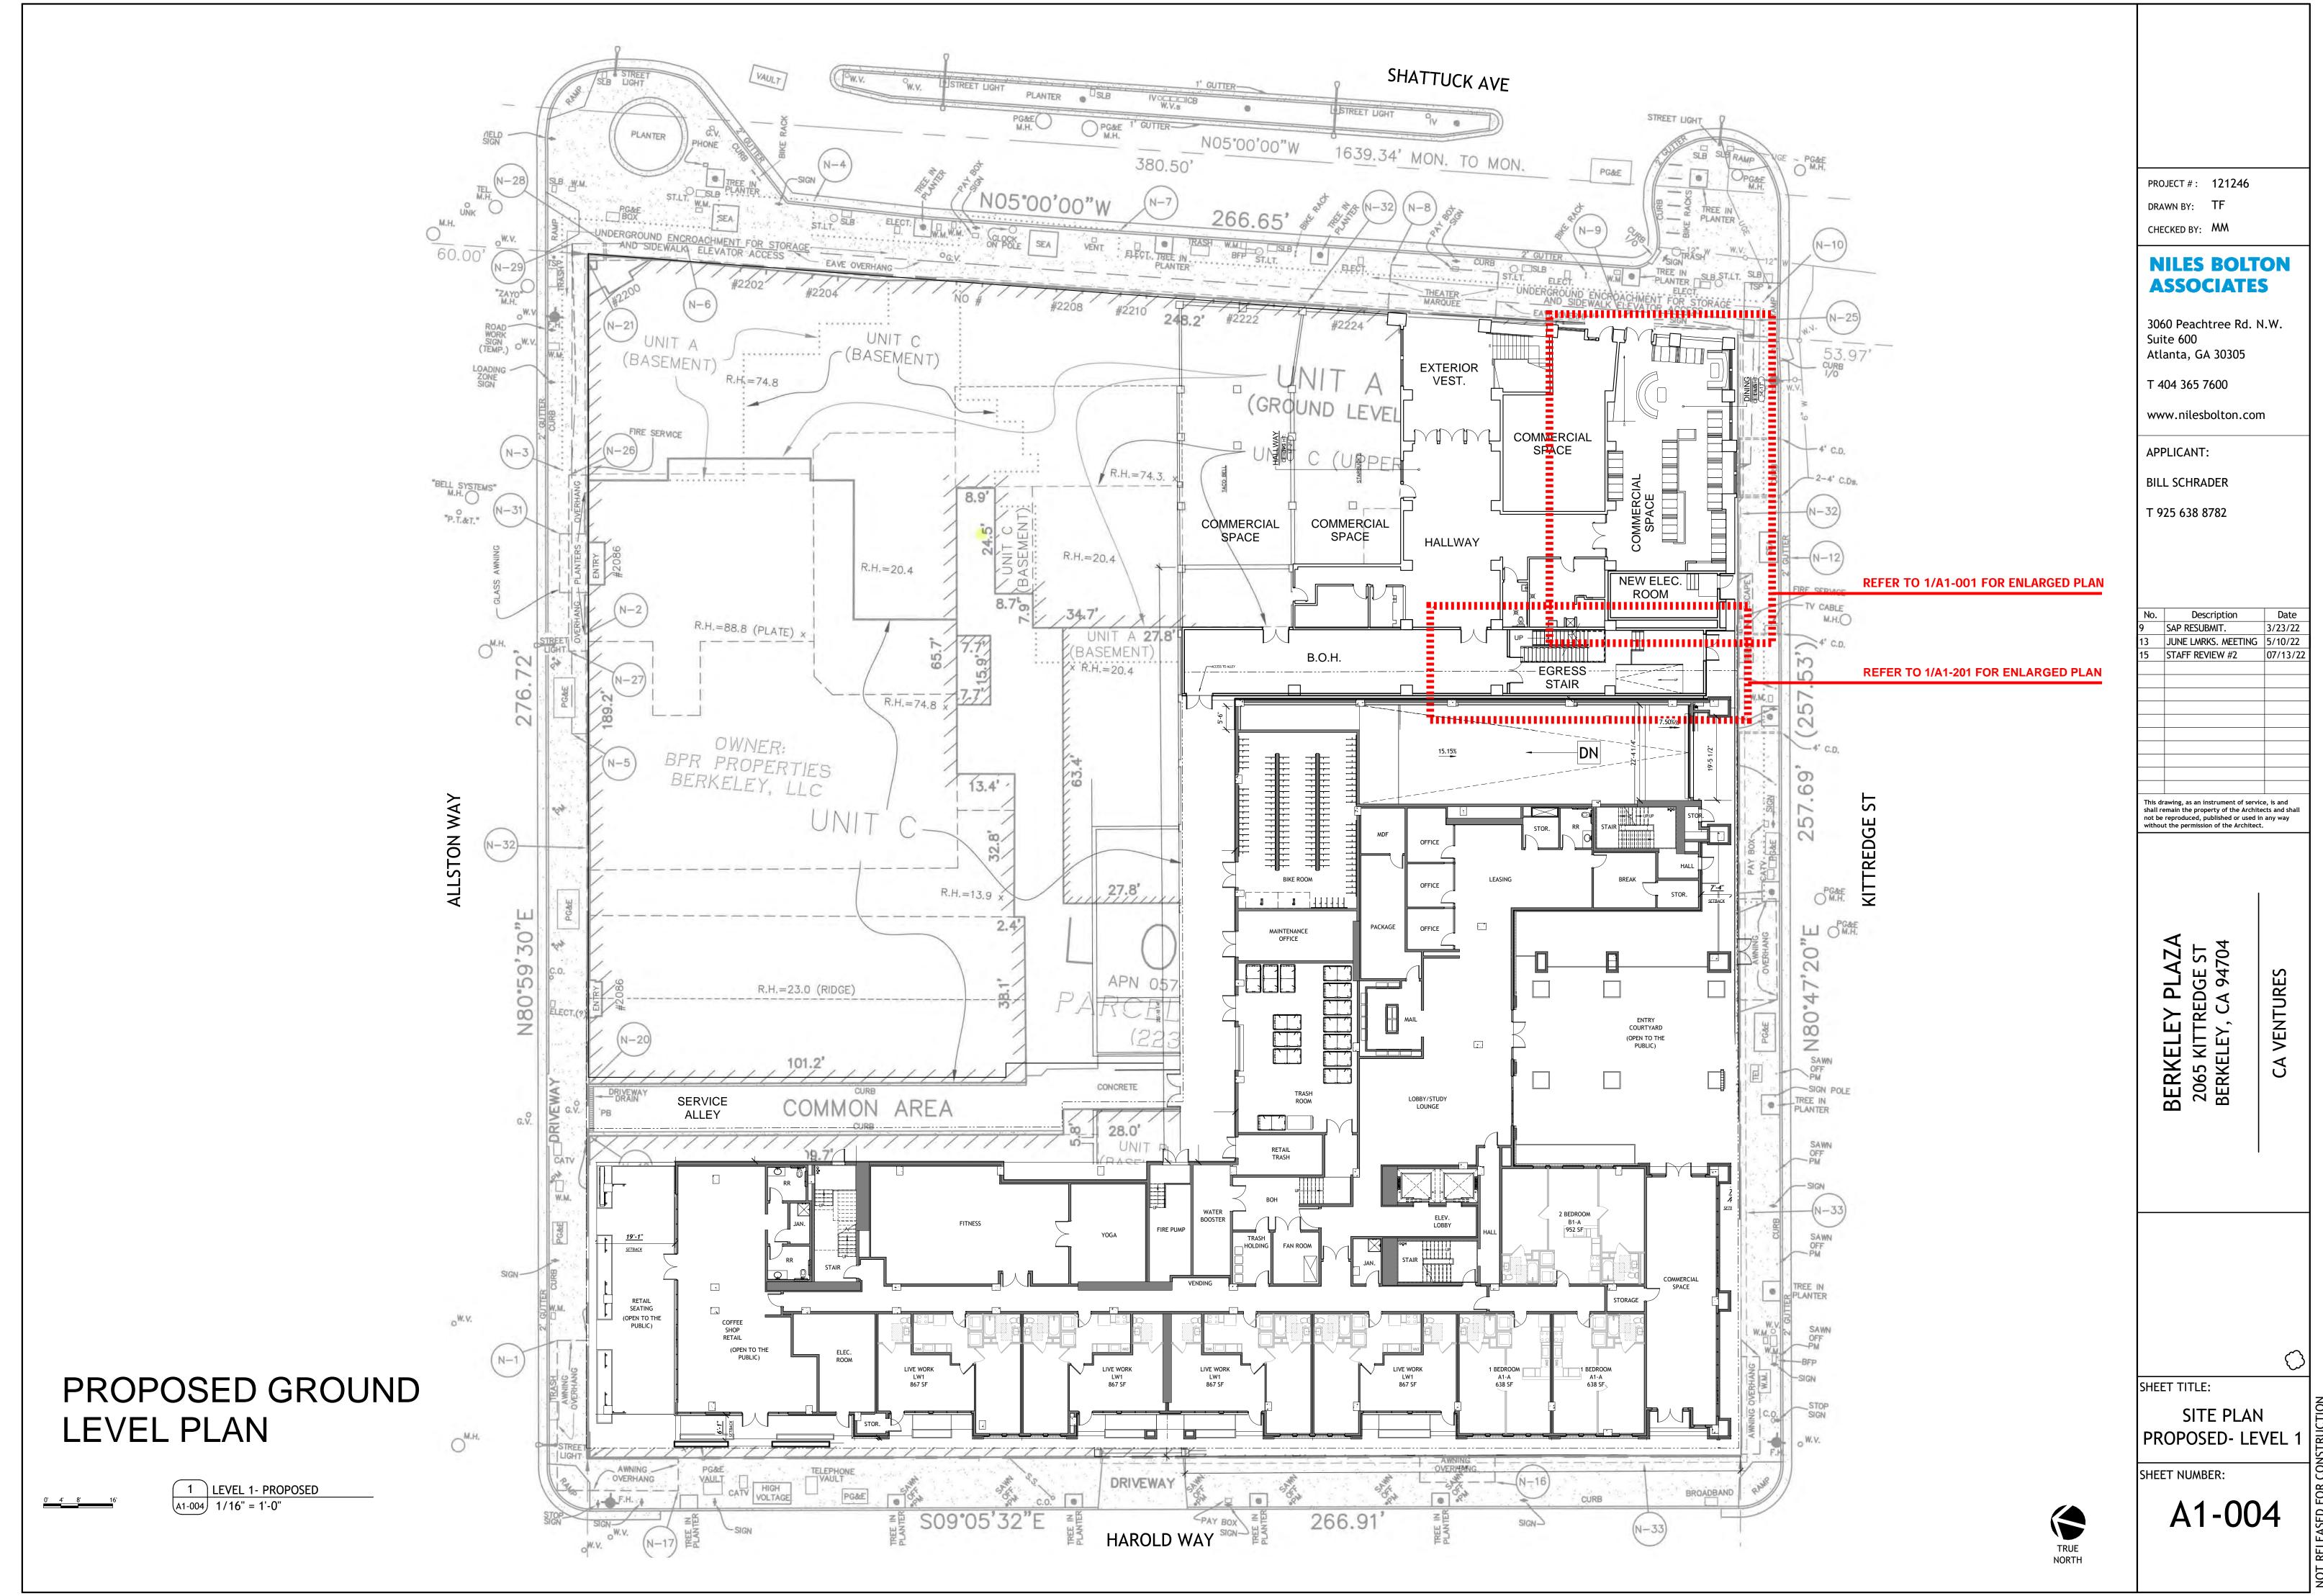


Page 21 of 54

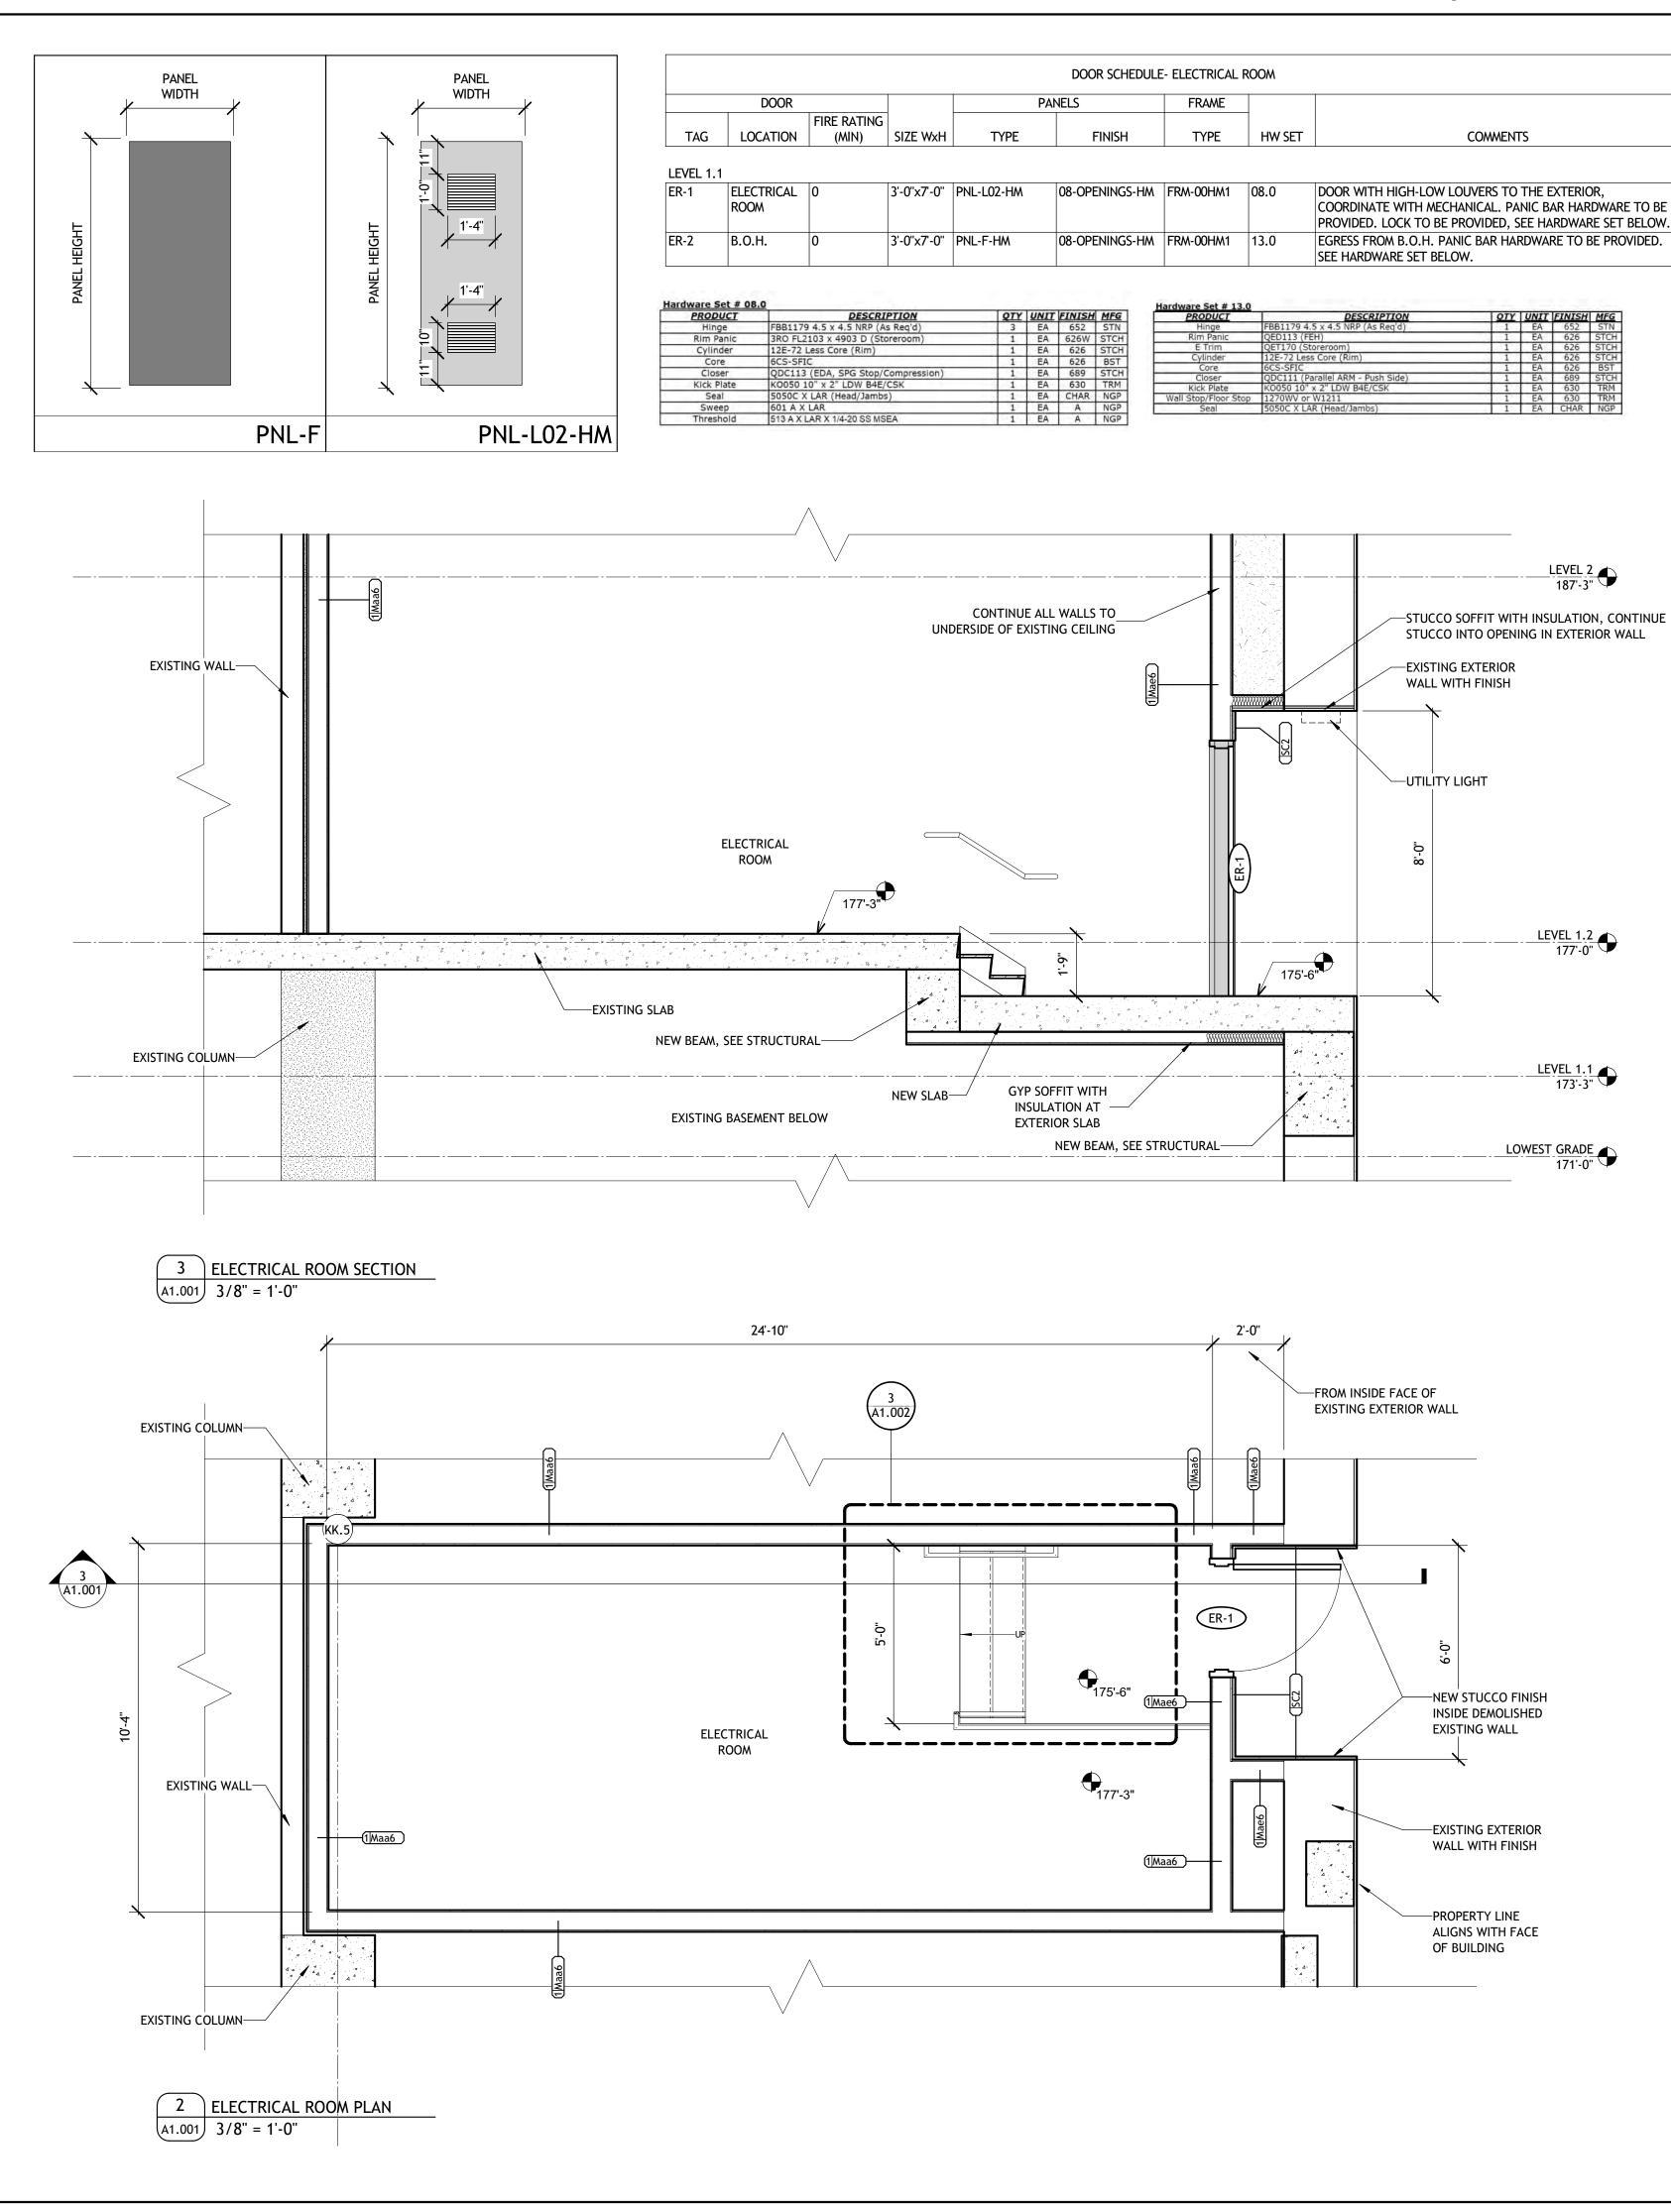



Page 22 of 54


	DOOR SCHEDULE	- ELECTRICAL	ROOM	
Р	ANELS	FRAME		
TYPE	FINISH	TYPE	HW SET	COMMENTS
PNL-L02-HM	08-OPENINGS-HM	FRM-00HM1	08.0	DOOR WITH HIGH-LOW LOUVERS TO THE EXTERIOR, COORDINATE WITH MECHANICAL. PANIC BAR HARDWARE TO BE PROVIDED. LOCK TO BE PROVIDED, SEE HARDWARE SET BELOW.

QTY	UNIT	FINISH	MFG	PRODUCT	DESCRIPTION	QTY	UNIT	FINISH	MFG
3	EA	652	STN	Hinge	FBB1179 4.5 x 4.5 NRP (As Reg'd)	1	EA	652	STN
1	EA	626W	STCH	Rim Panic	QED113 (FEH)	1	EA	626	STCH
1	EA	626	STCH	E Trim	QET170 (Storeroom)	1	EA	626	STCH
 1	EA	626	BST	Cylinder	12E-72 Less Core (Rim)	1	EA	626	STCH
 				Core	6CS-SFIC	1	EA	626	BST
 1	EA	689	STCH	Closer	QDC111 (Parallel ARM - Push Side)	1	EA	689	STCH
 1	EA	630	TRM	Kick Plate	K0050 10" x 2" LDW B4E/CSK	1	EA	630	TRM
1	EA	CHAR	NGP	Wall Stop/Floor Stop	1270WV or W1211	1	EA	630	TRM
1	EA	A	NGP	Seal	5050C X LAR (Head/Jambs)	1	EA	CHAR	NGP
1	EA	A	NGP			1. State 1.			

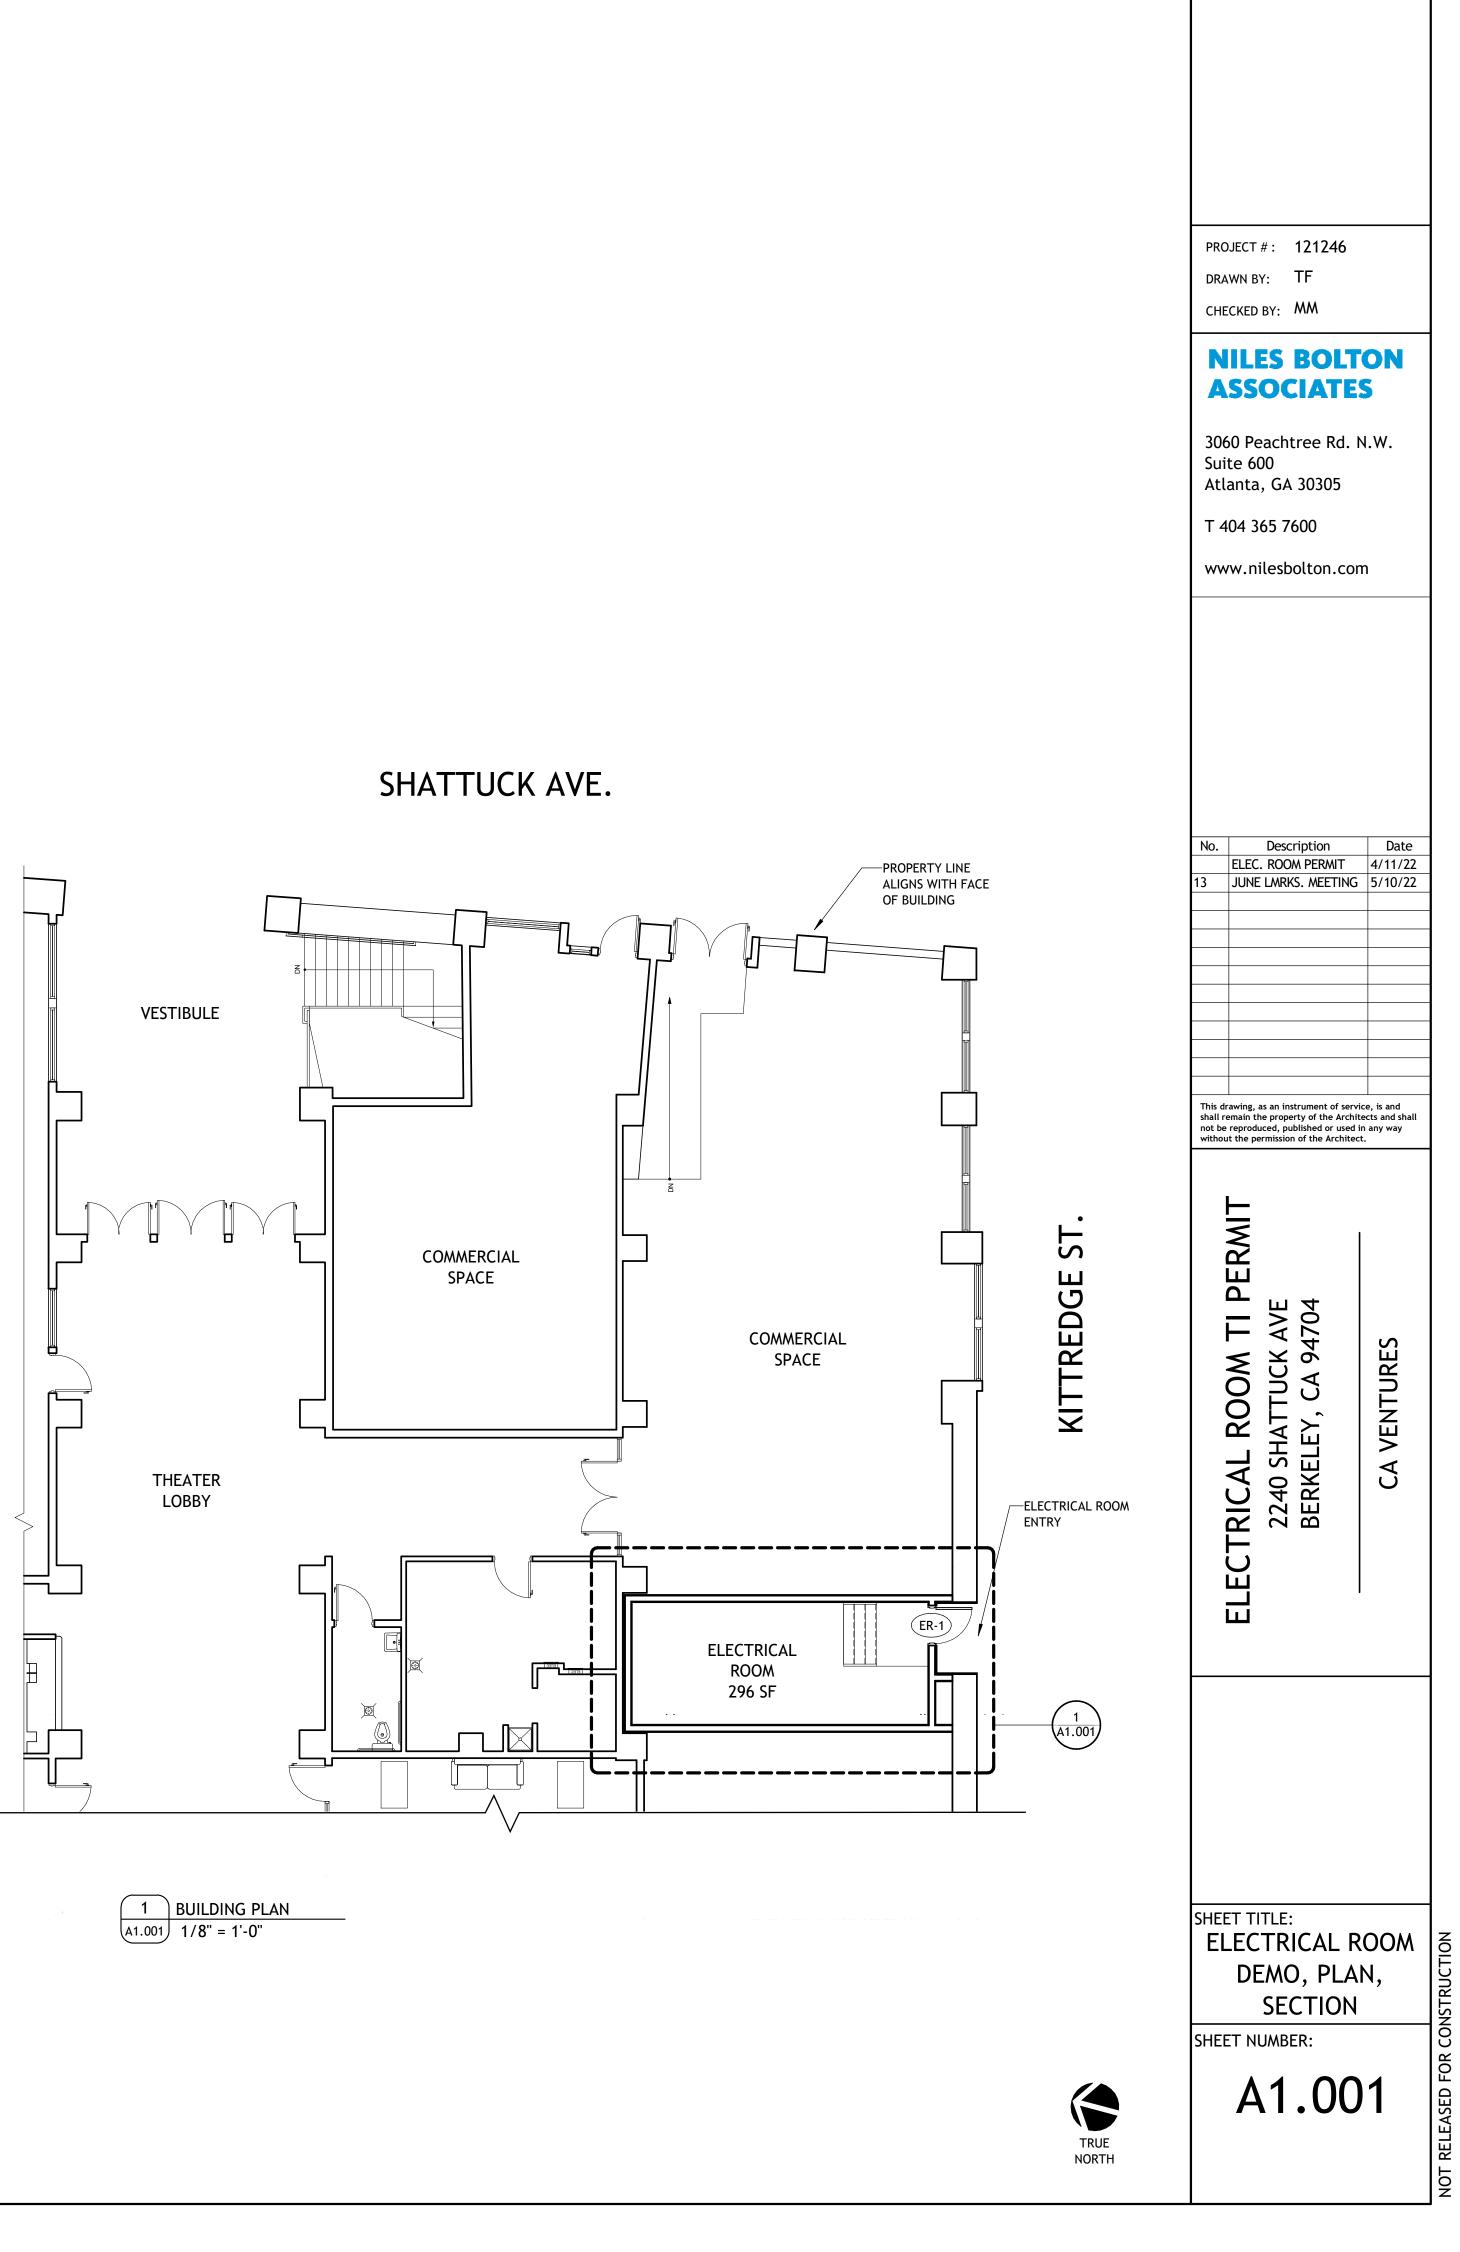

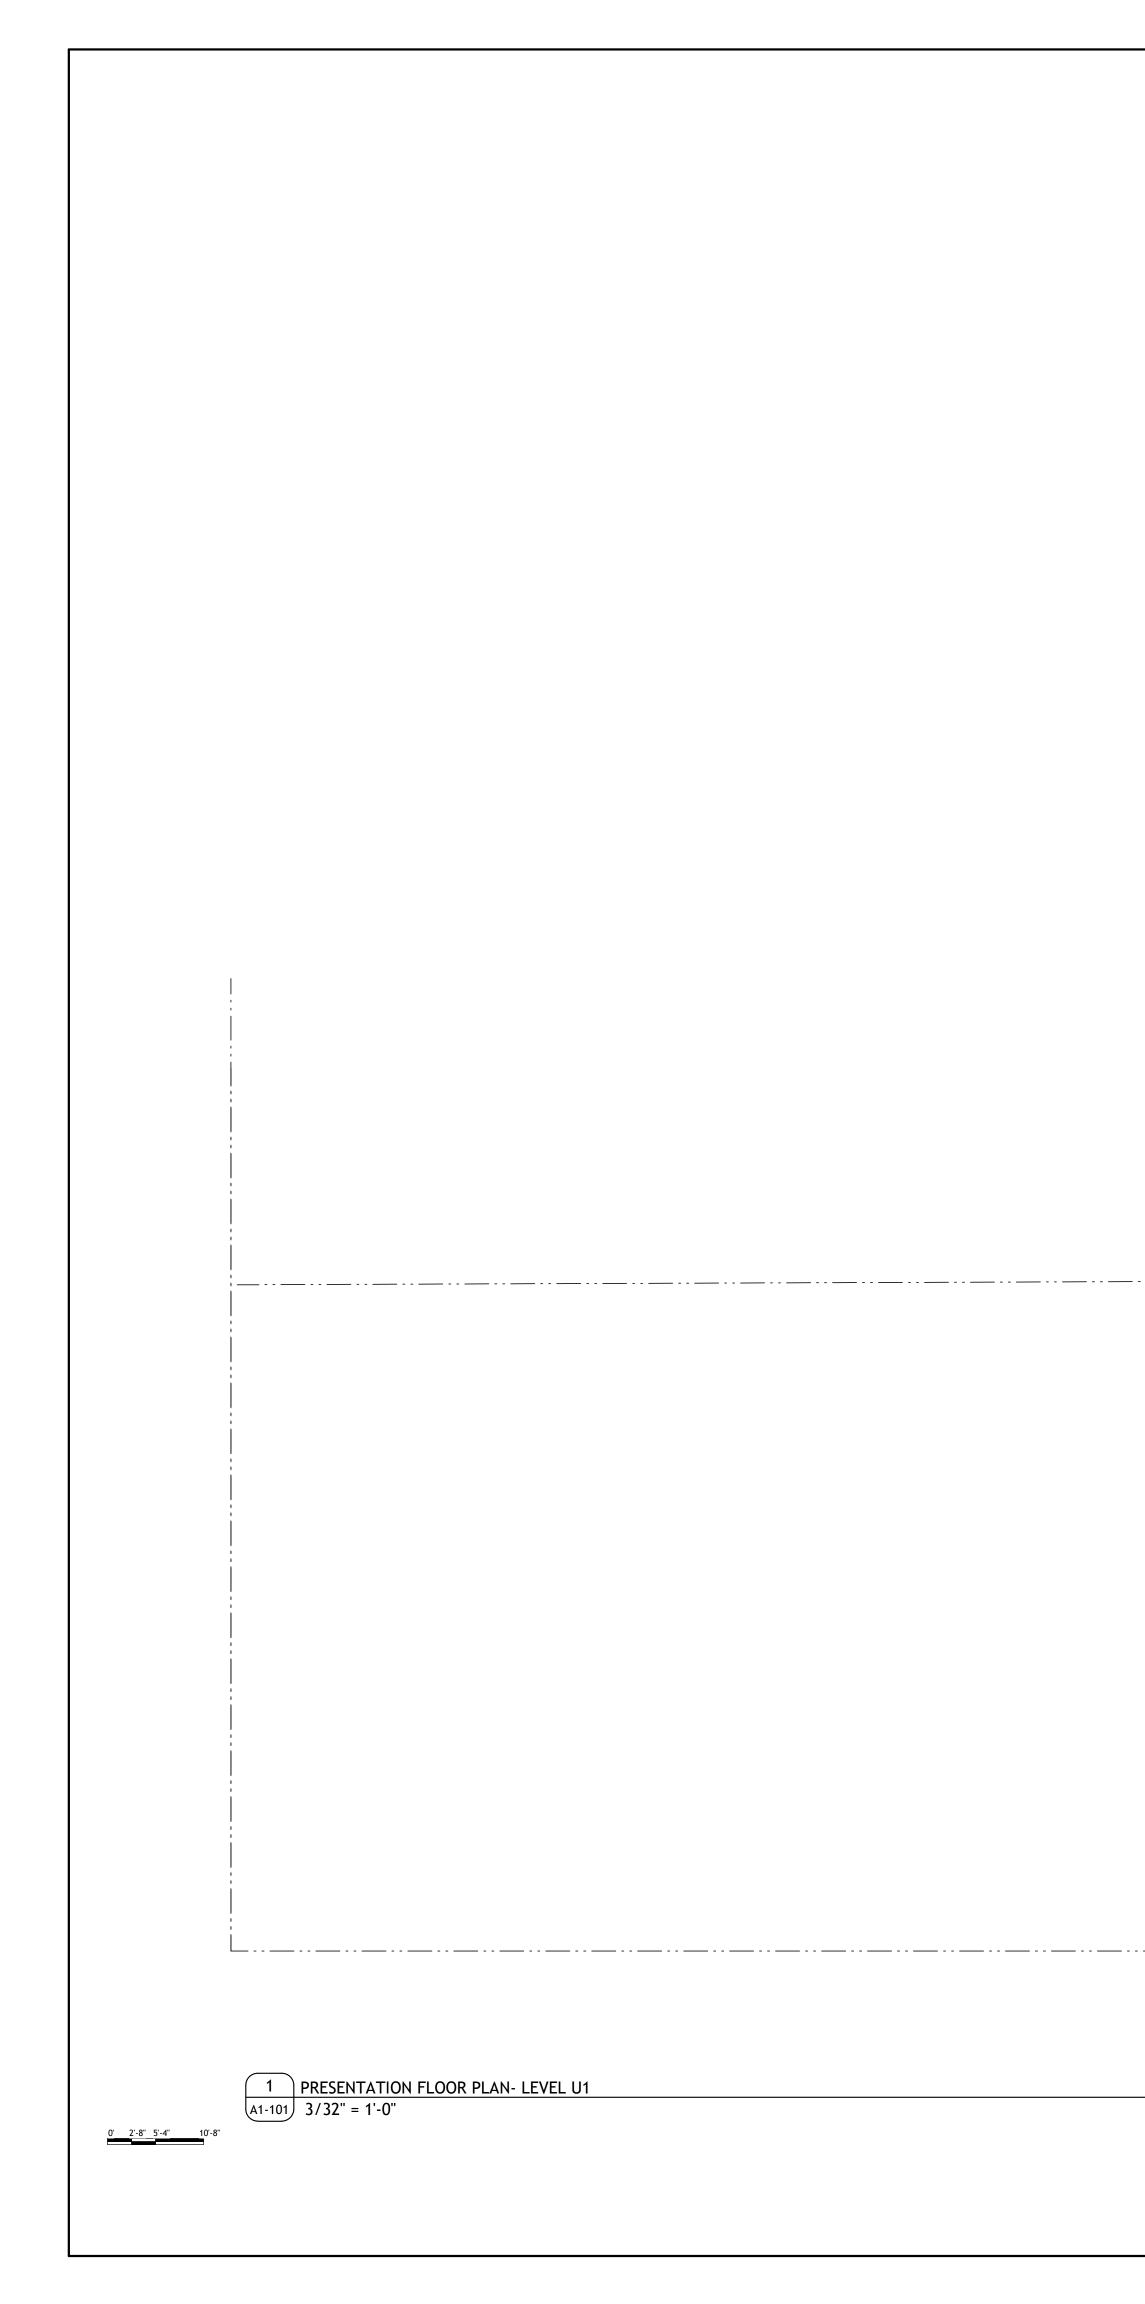

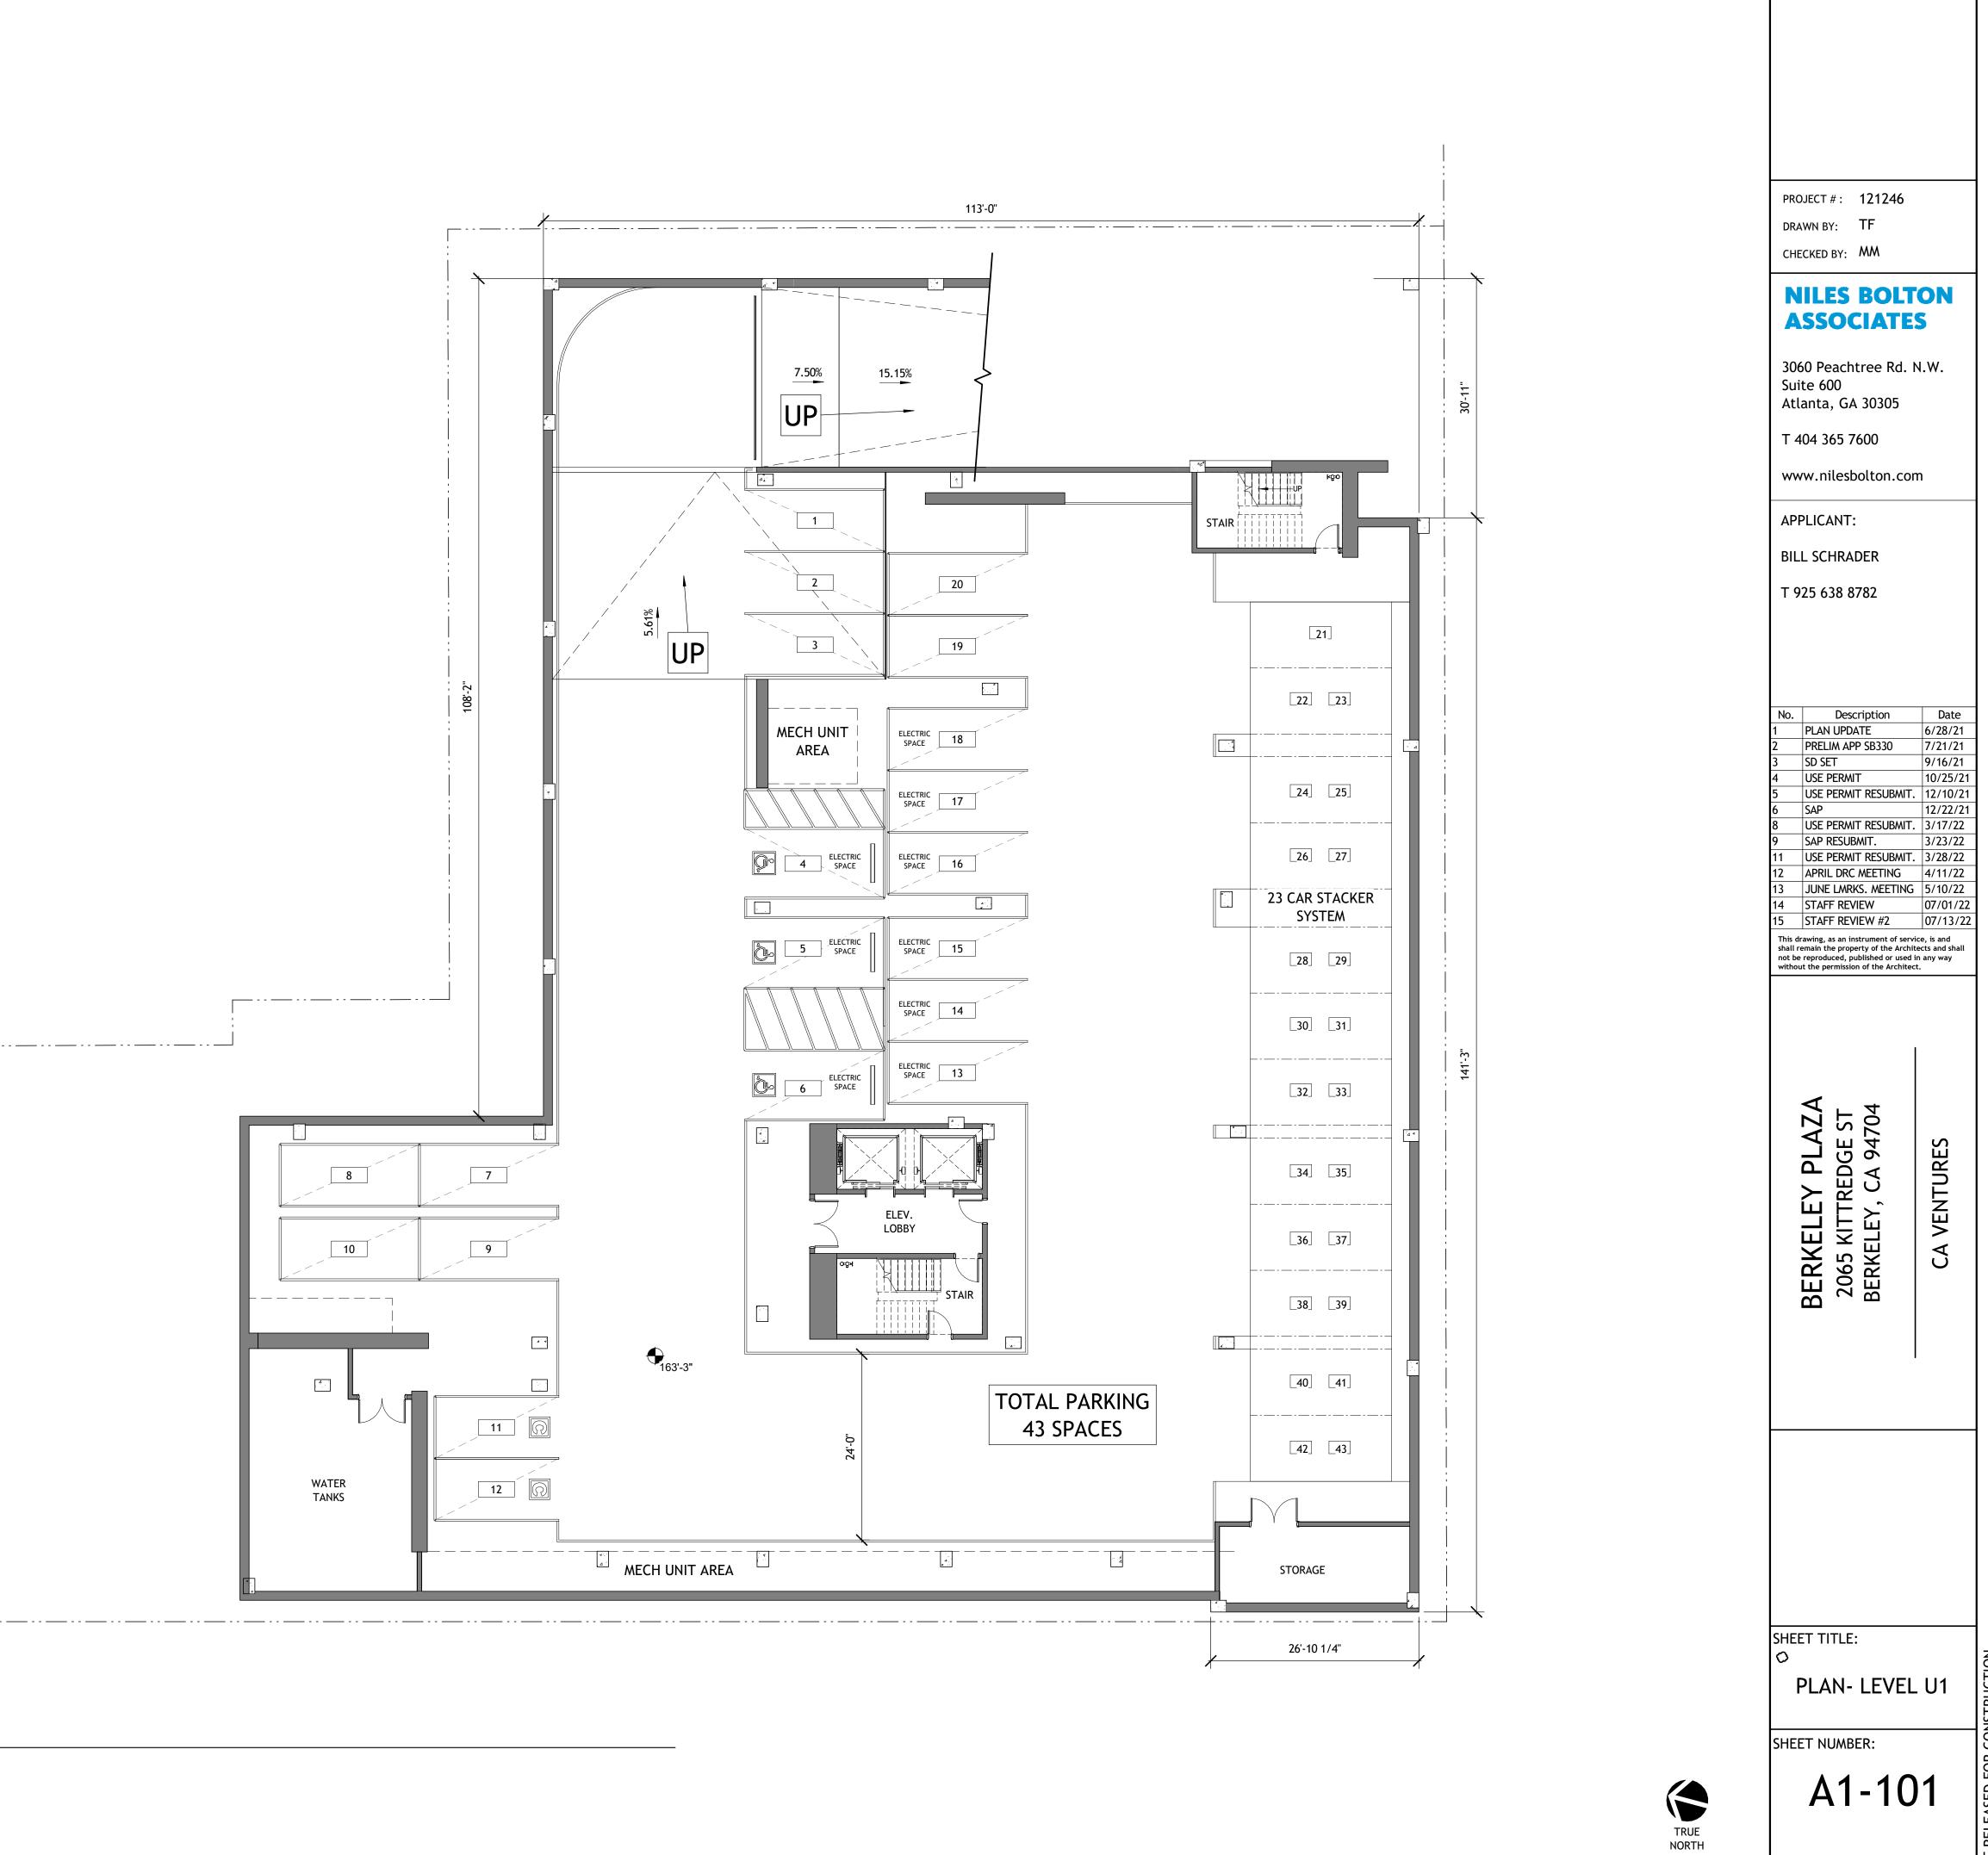


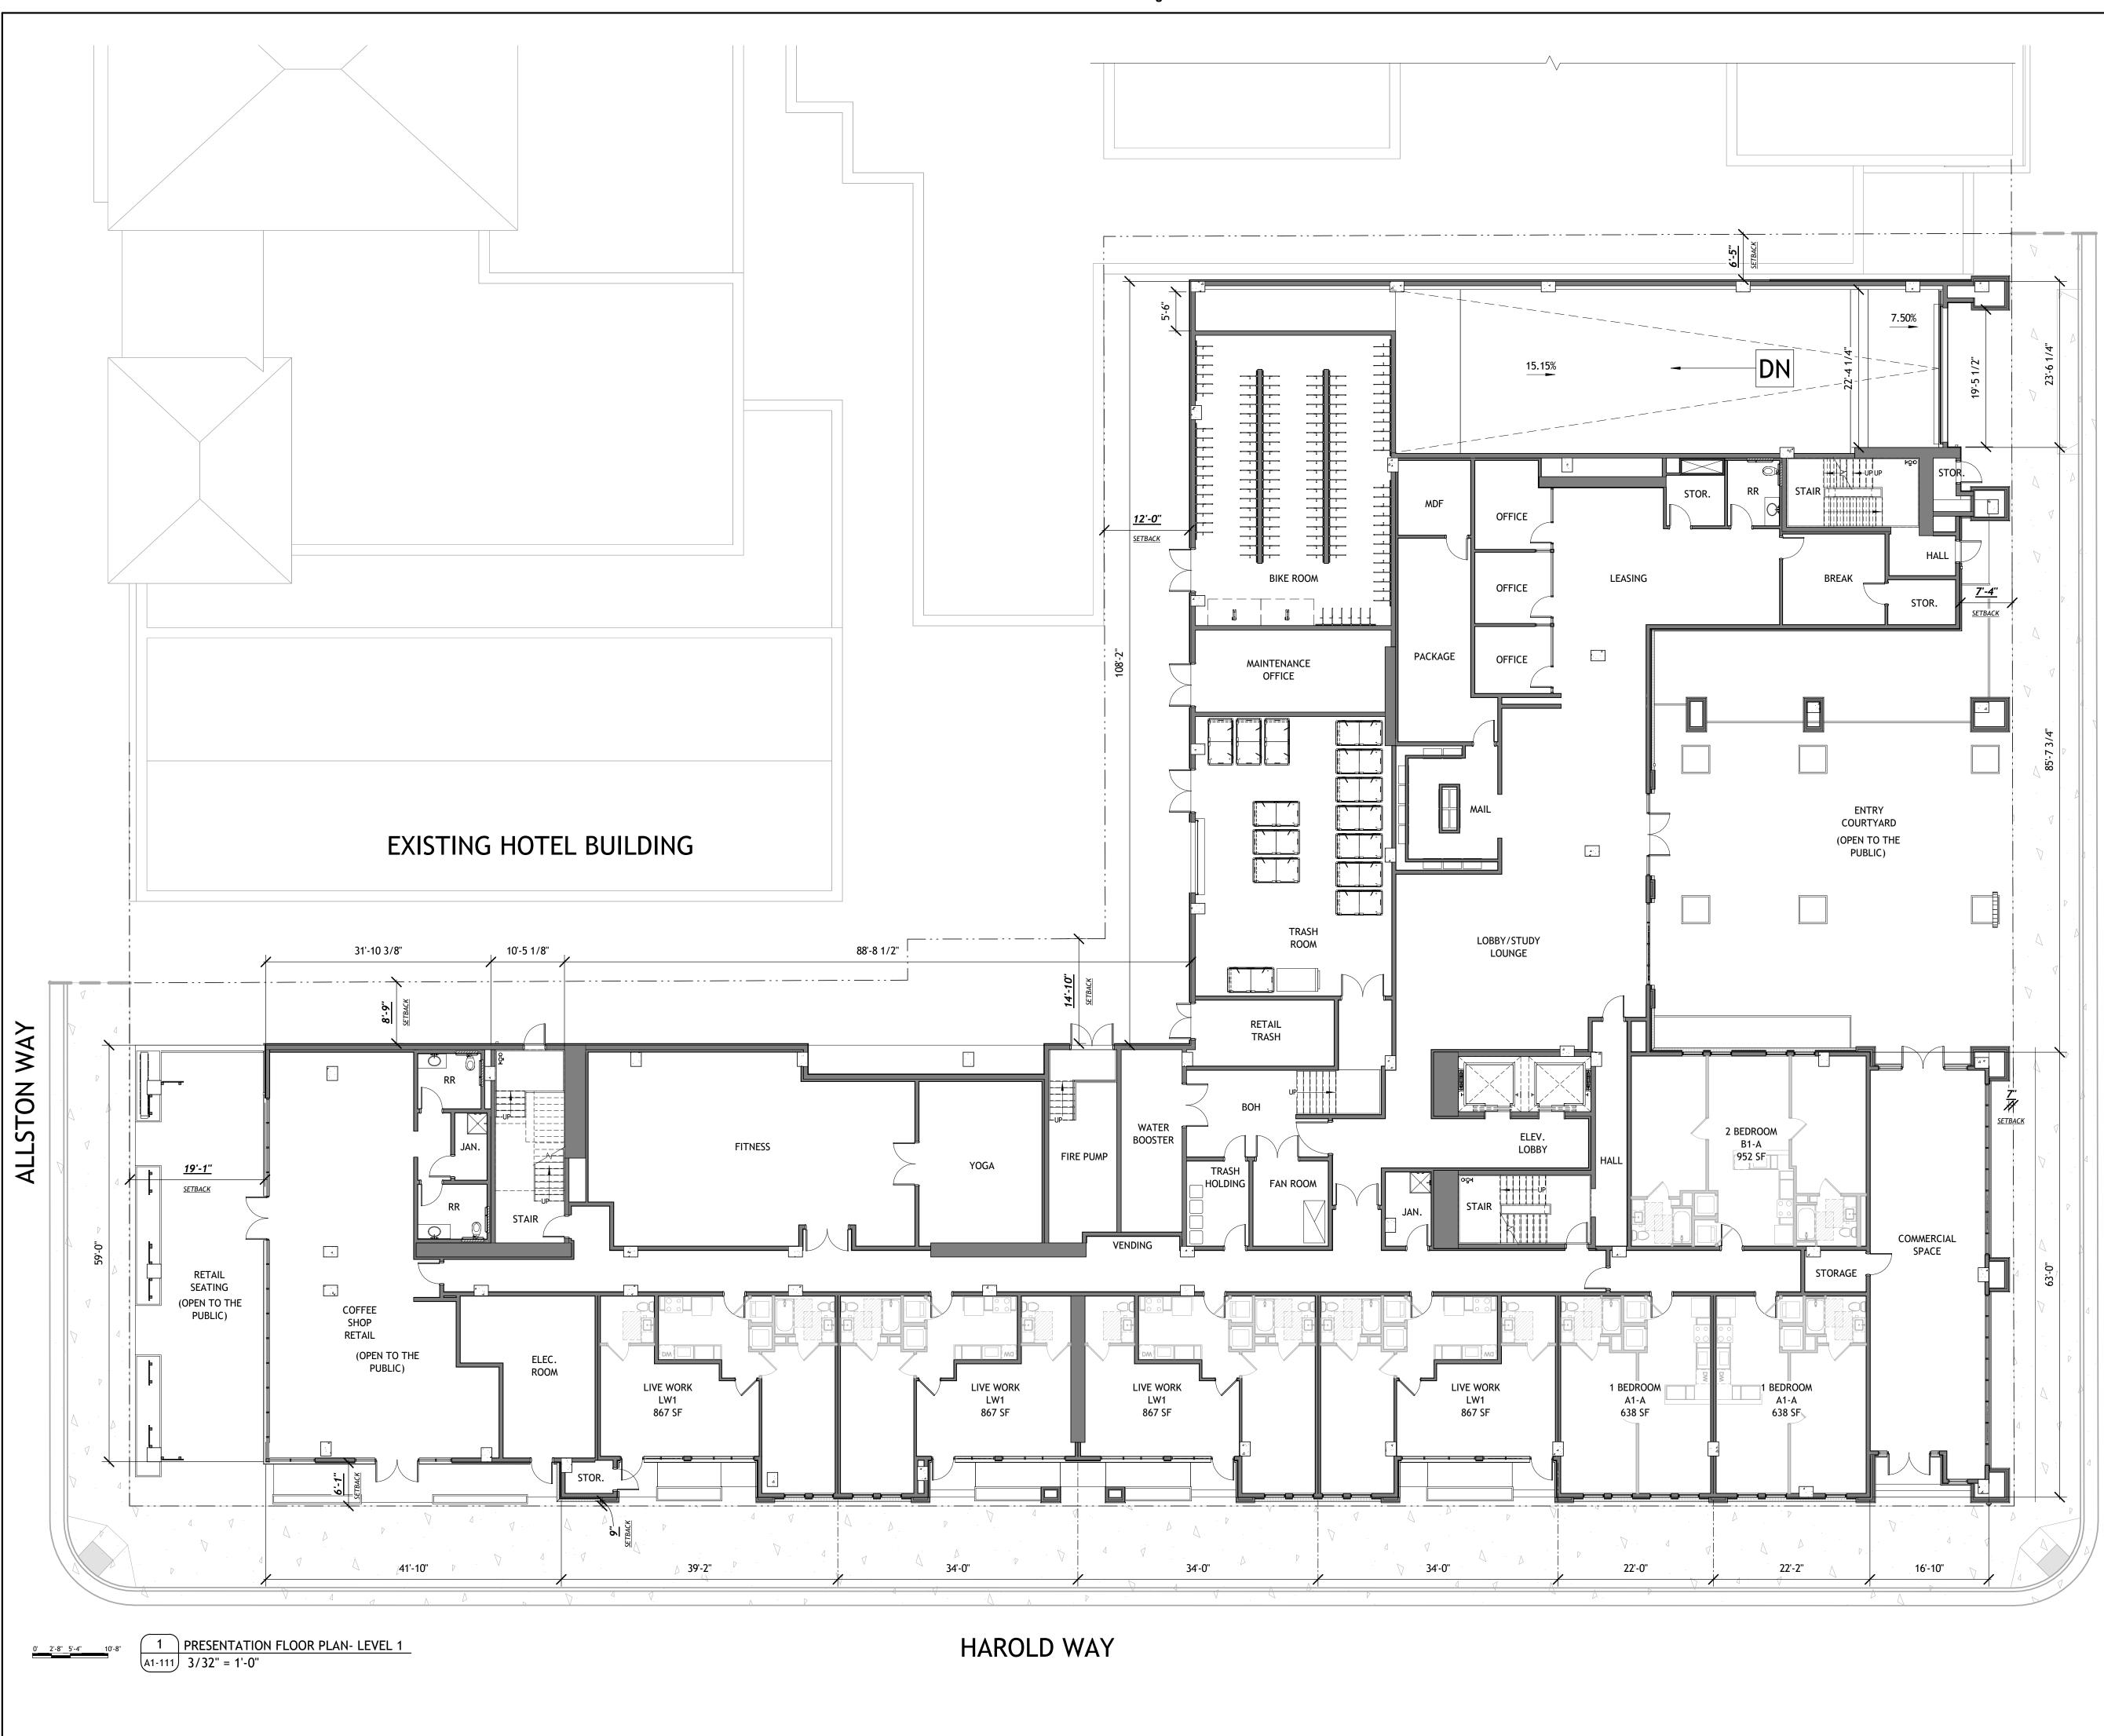


ST TREDGE KIT


TRUE NORTH

PROJECT # : 12124	6
DRAWN BY: TF CHECKED BY: MM	
NILES BOI ASSOCIAT	' ES J. N.W.
No.Description1PLAN UPDATE2PRELIM APP SB3303SD SET4USE PERMIT5USE PERMIT RESUBA6SAP8USE PERMIT RESUBA9SAP RESUBMIT.11USE PERMIT RESUBA12APRIL DRC MEETING13JUNE LMRKS. MEETI14STAFF REVIEW15STAFF REVIEW #2This drawing, as an instrument of shall remain the property of the A not be reproduced, published or u without the permission of the Arch	12/22/21 AIT. 3/17/22 3/23/22 AIT. 3/28/22 AIT. 3/28/22 G 4/11/22 NG 5/10/22 07/01/22 07/01/22 service, is and architects and shall used in any way
BERKELEY PLAZA 2065 KITTREDGE ST BERKELEY, CA 94704	CA VENTURES
SHEET TITLE: PLAN- LEV SHEET NUMBER: A1-1	

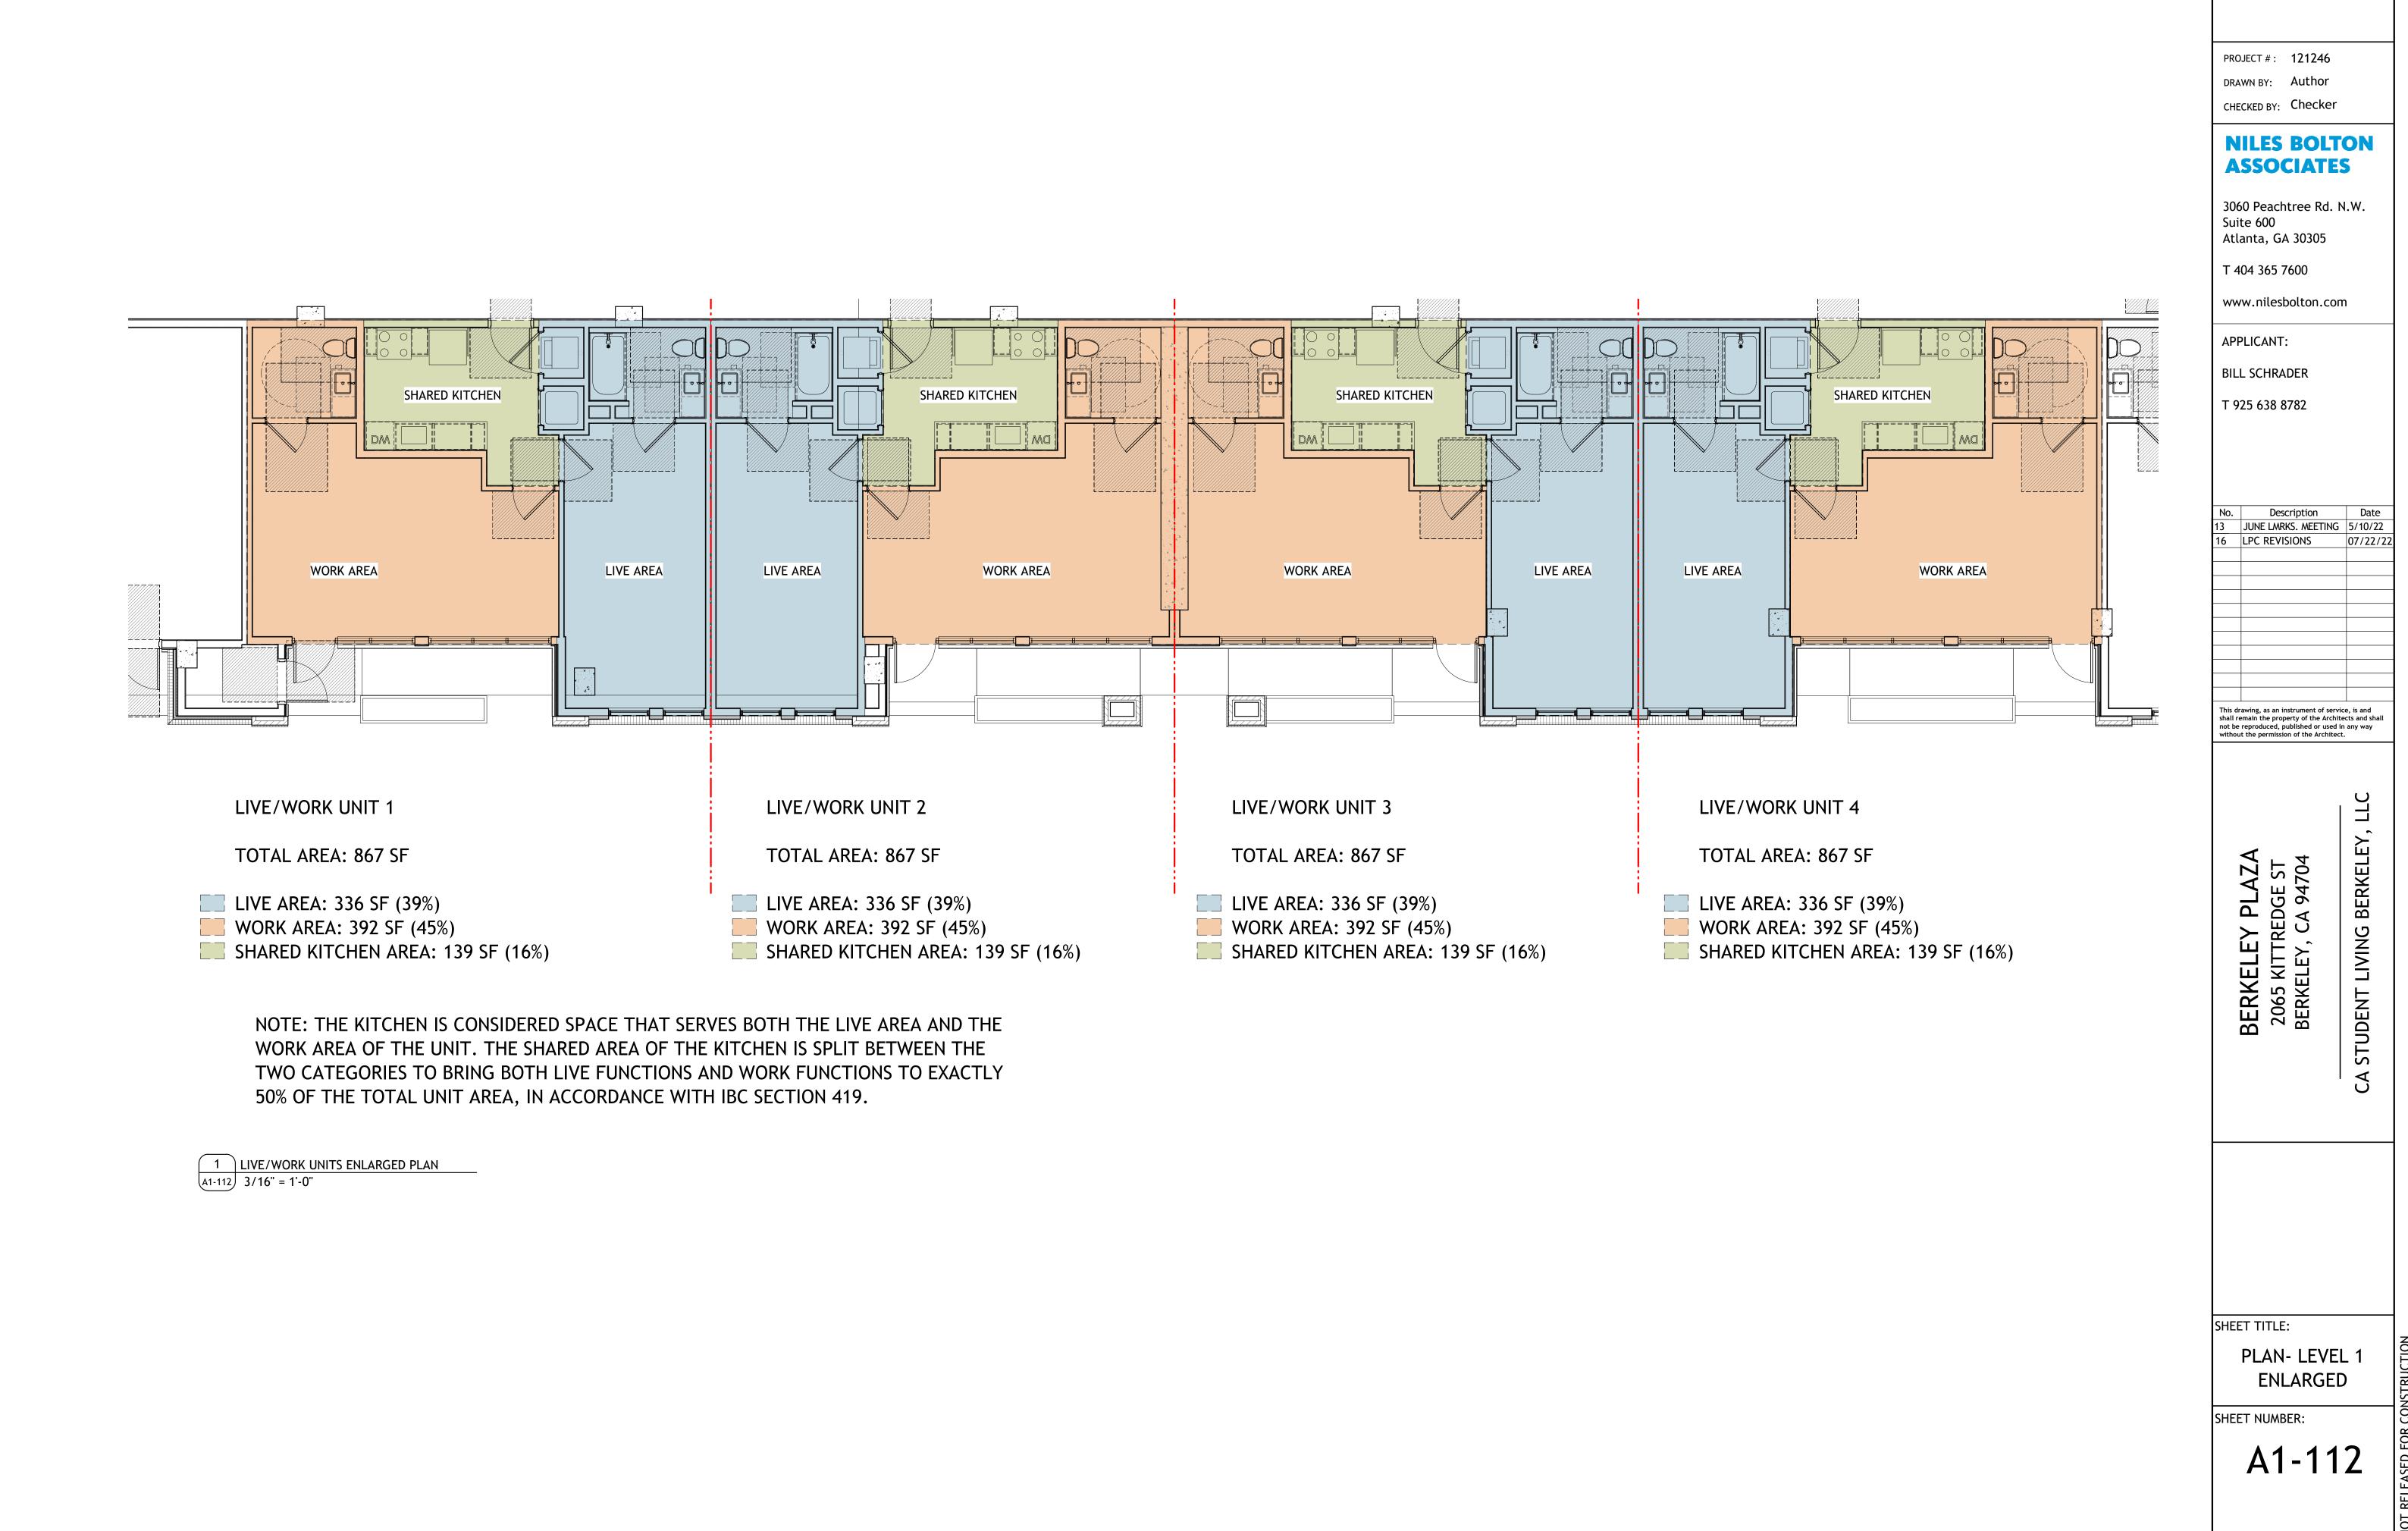

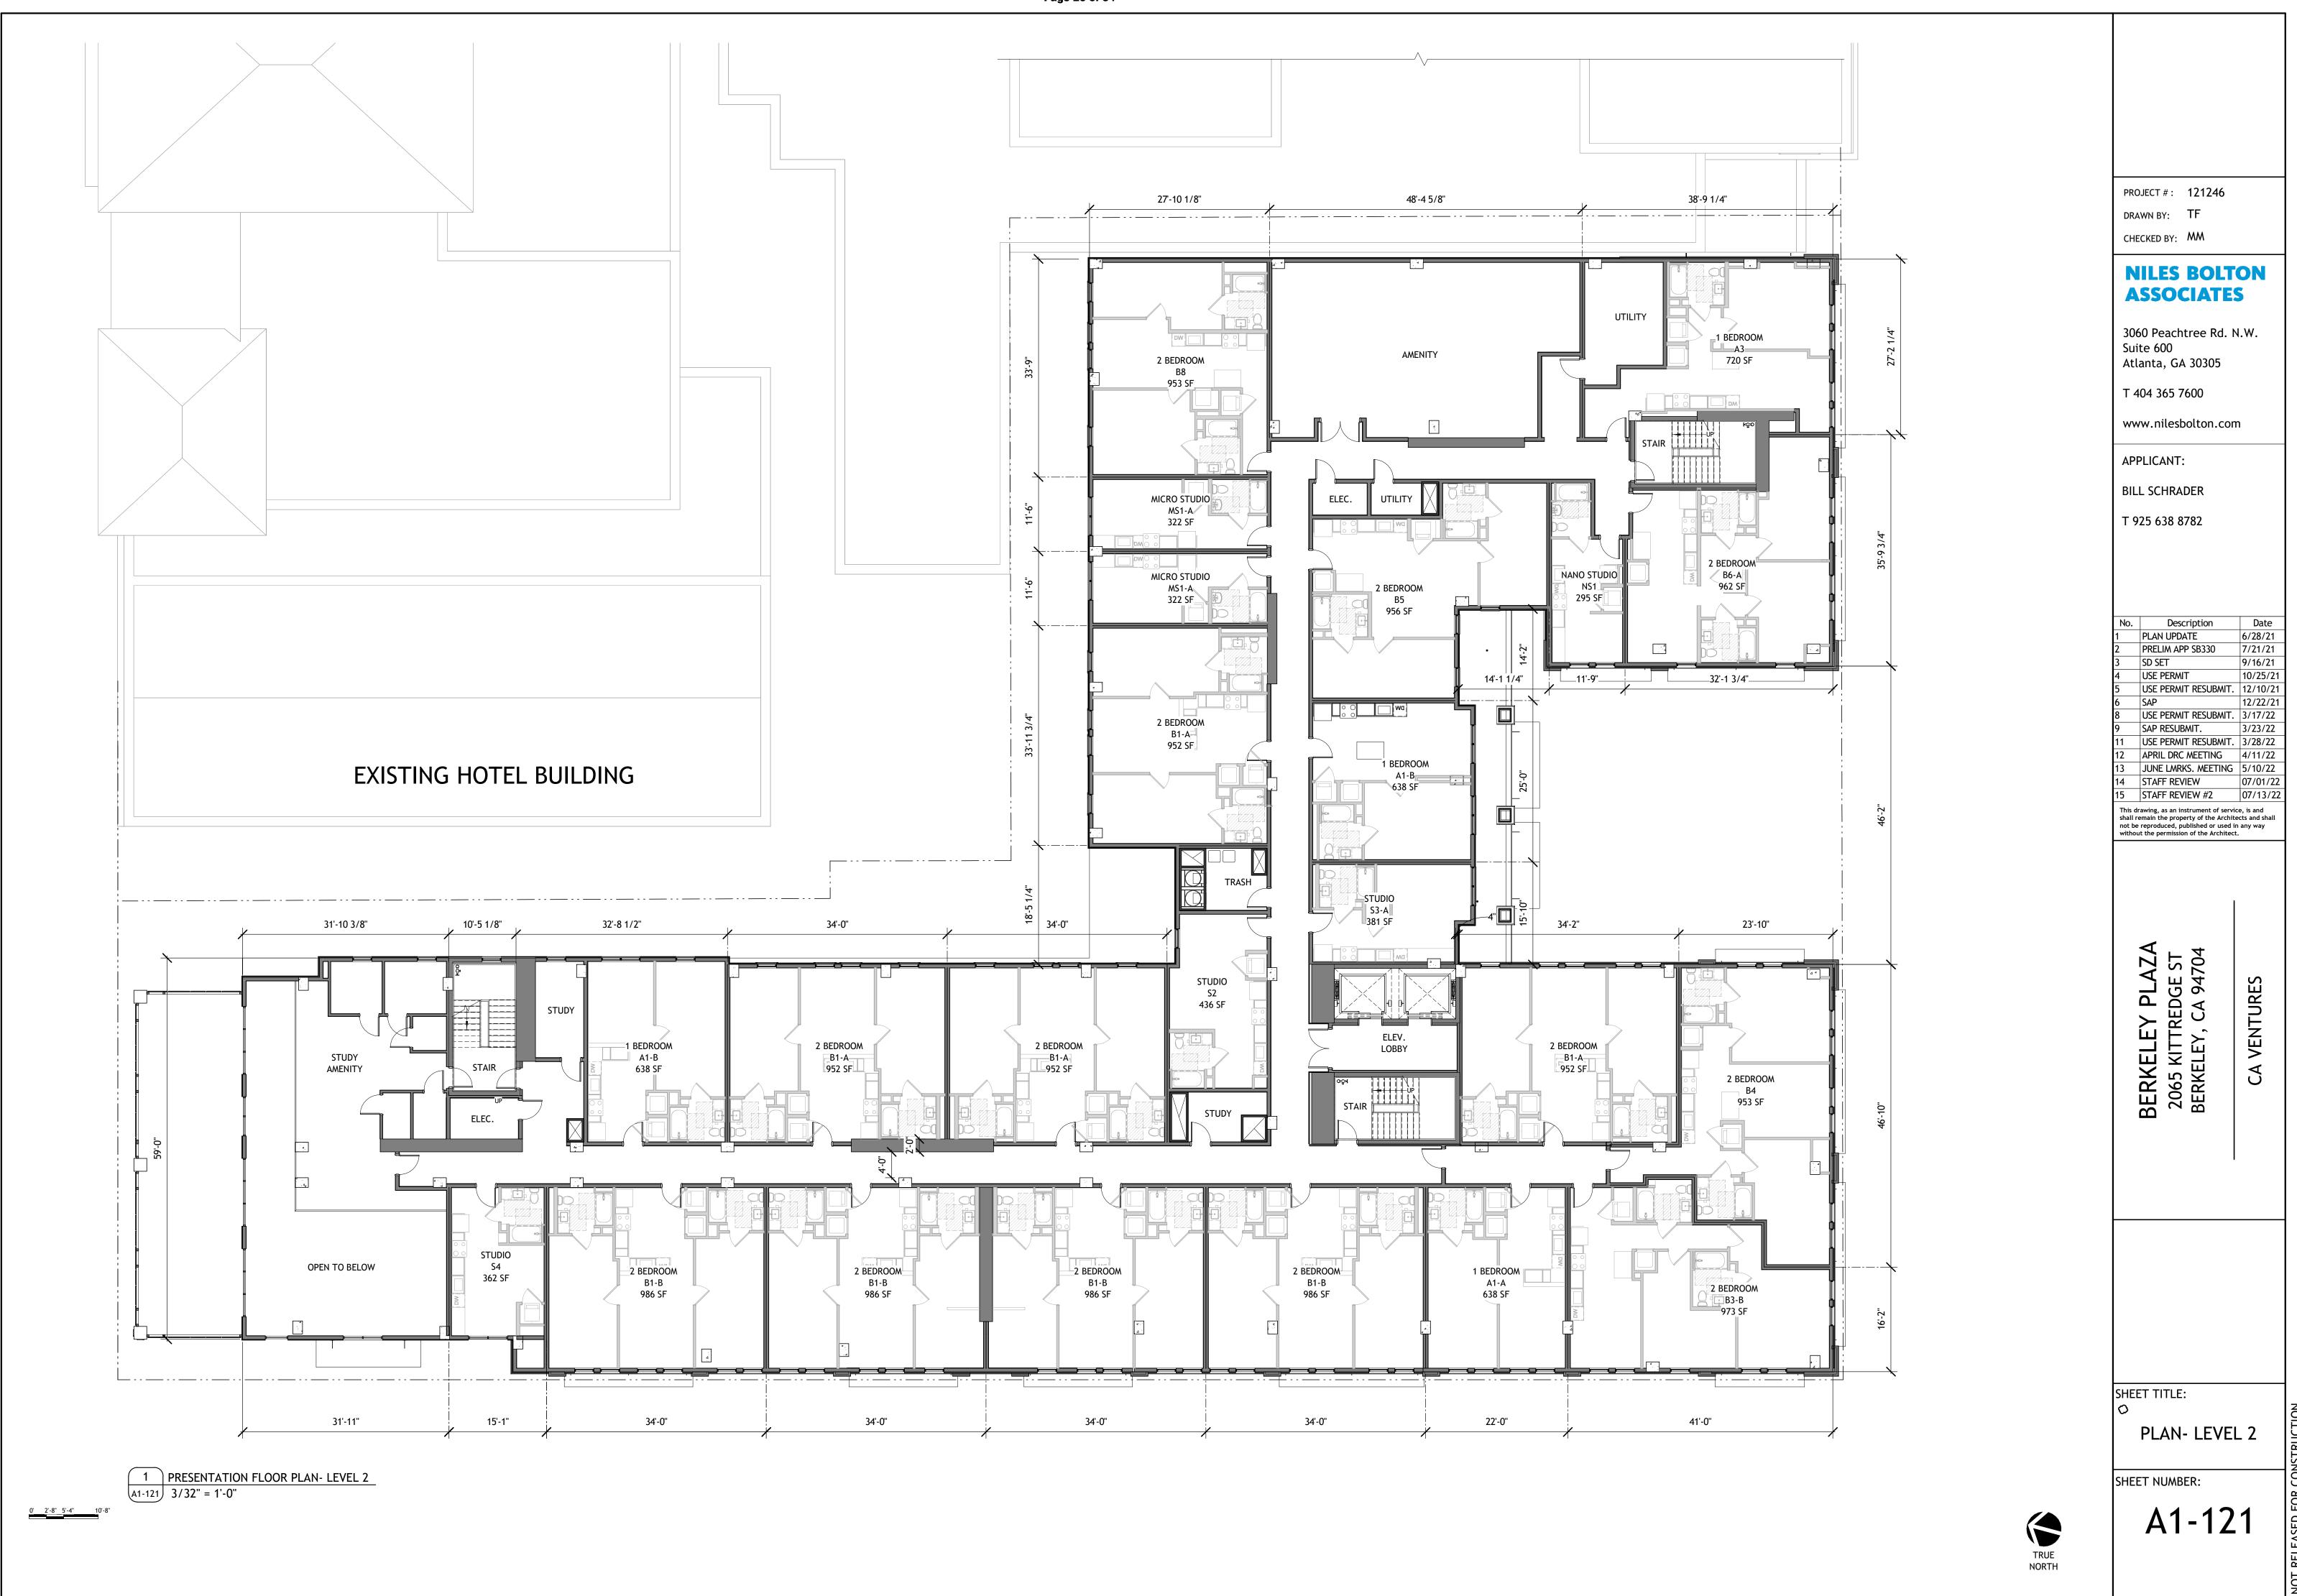



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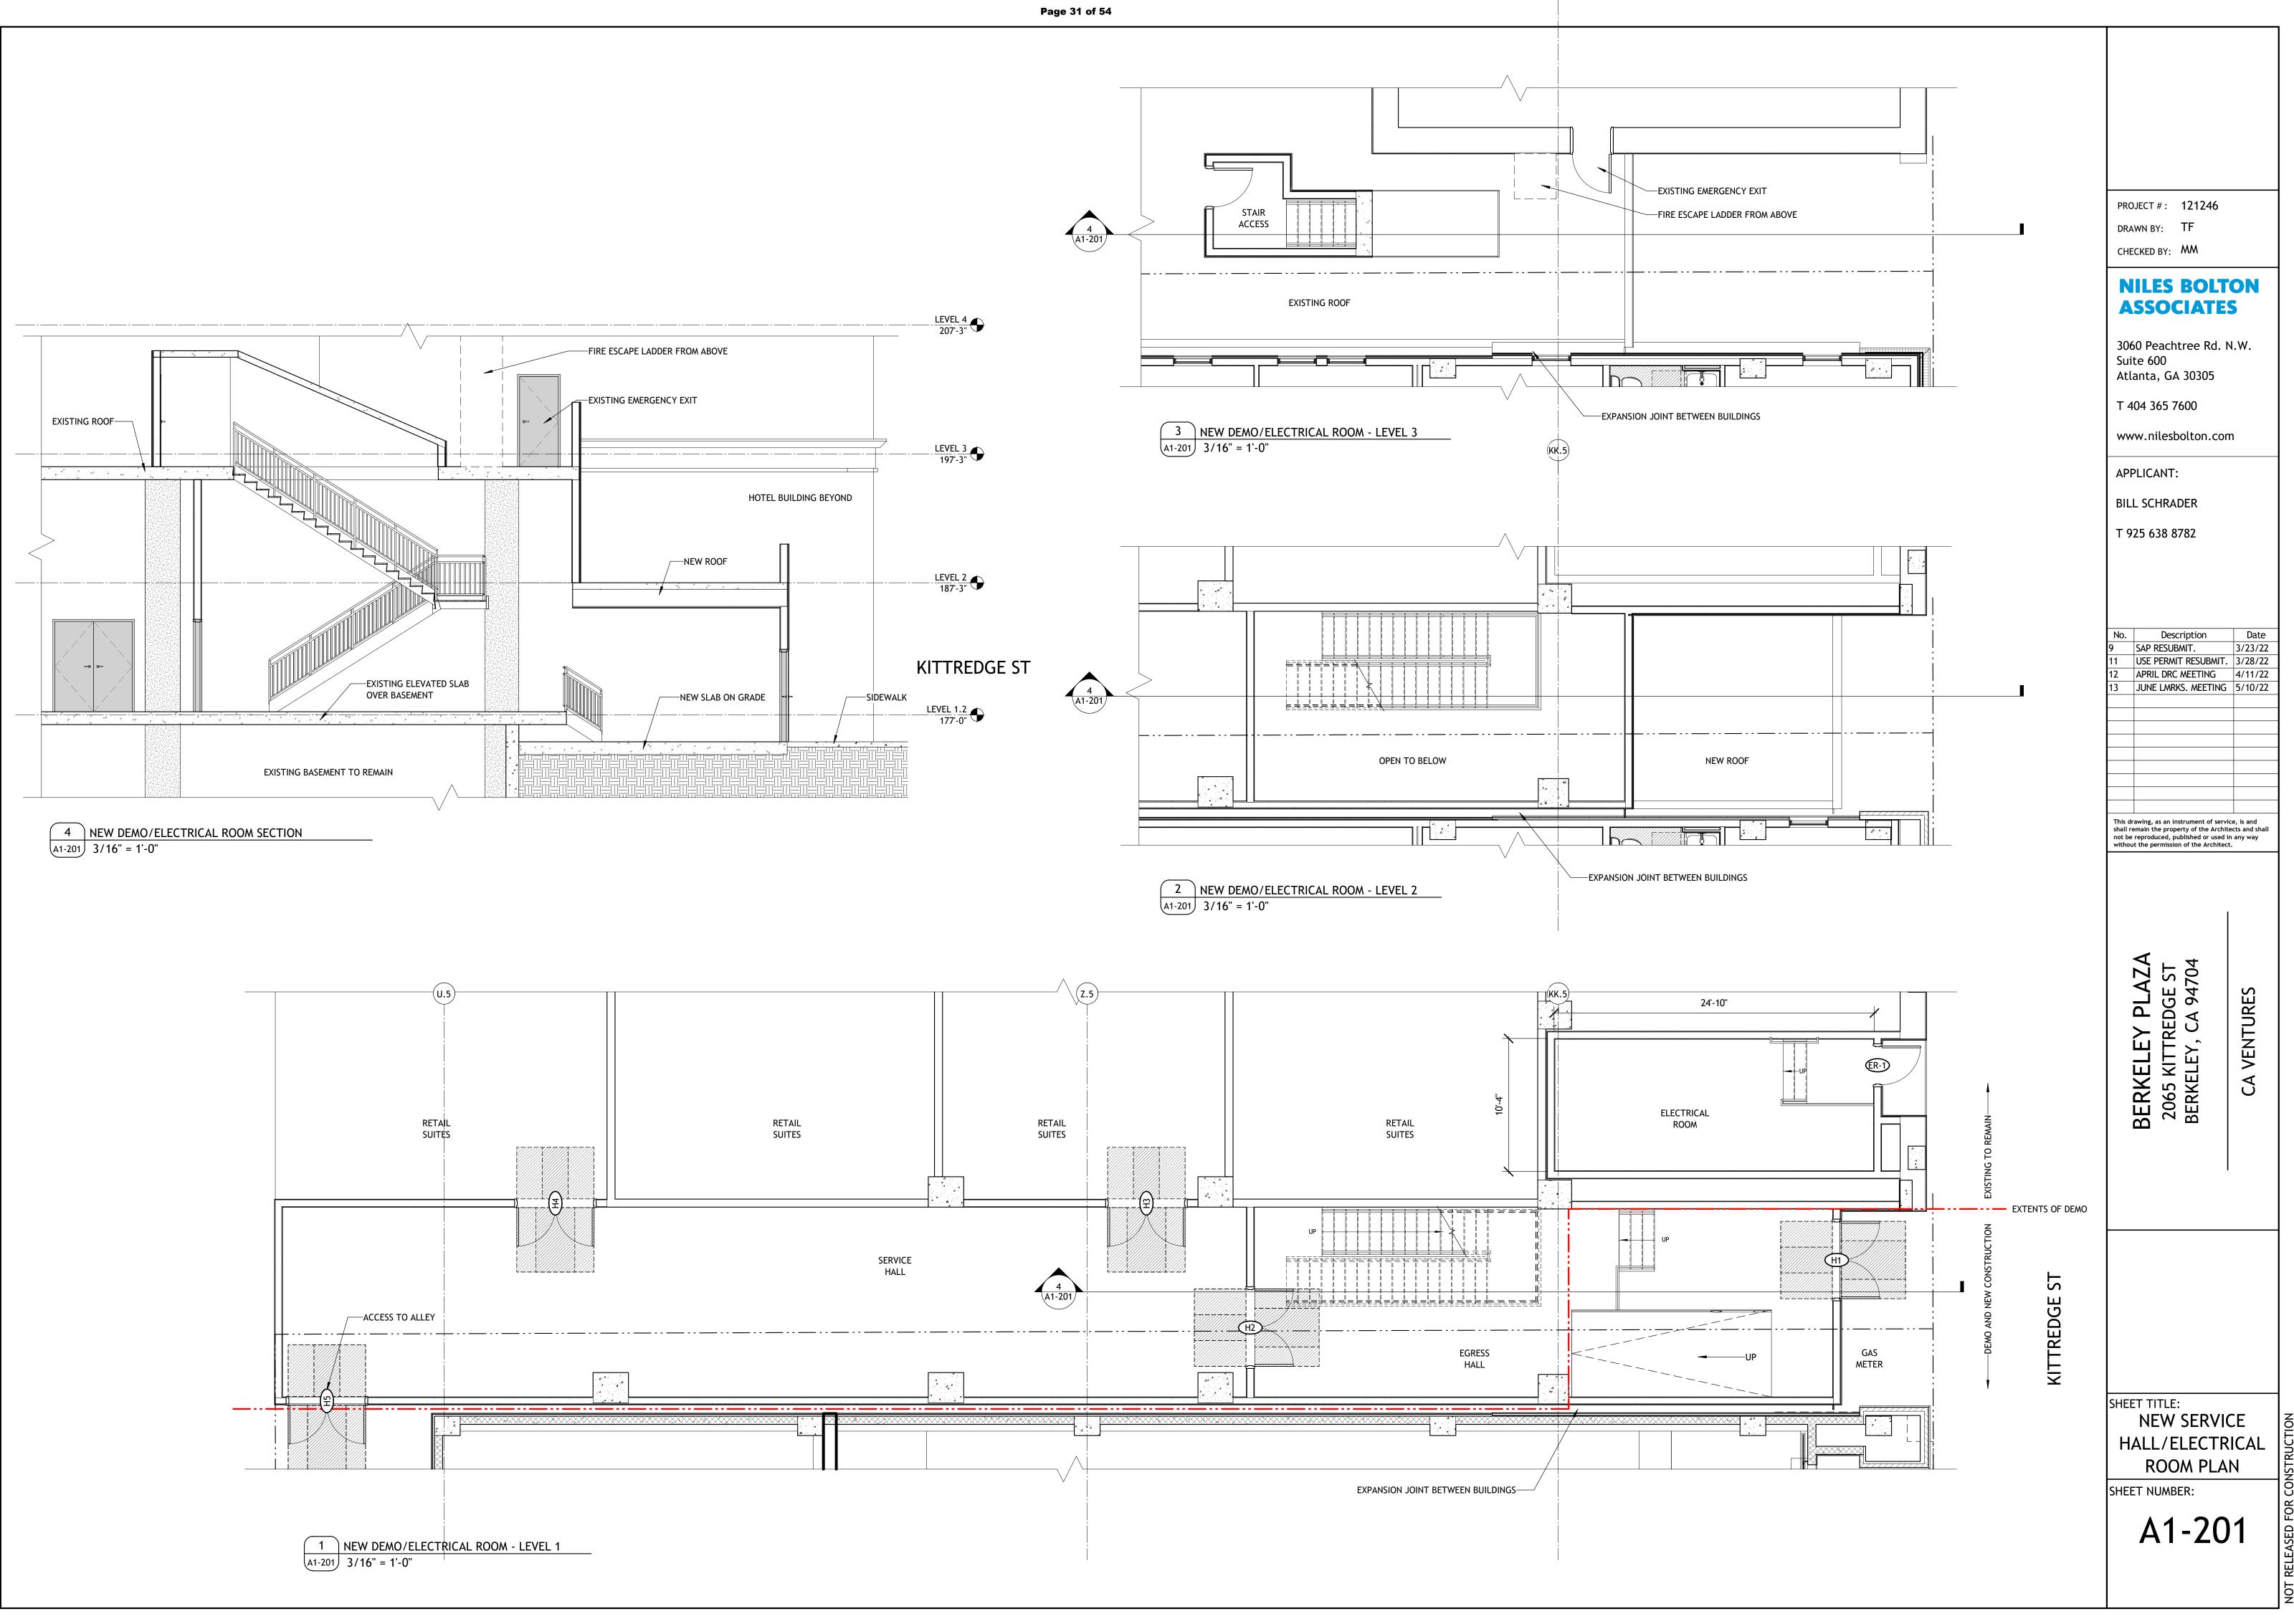


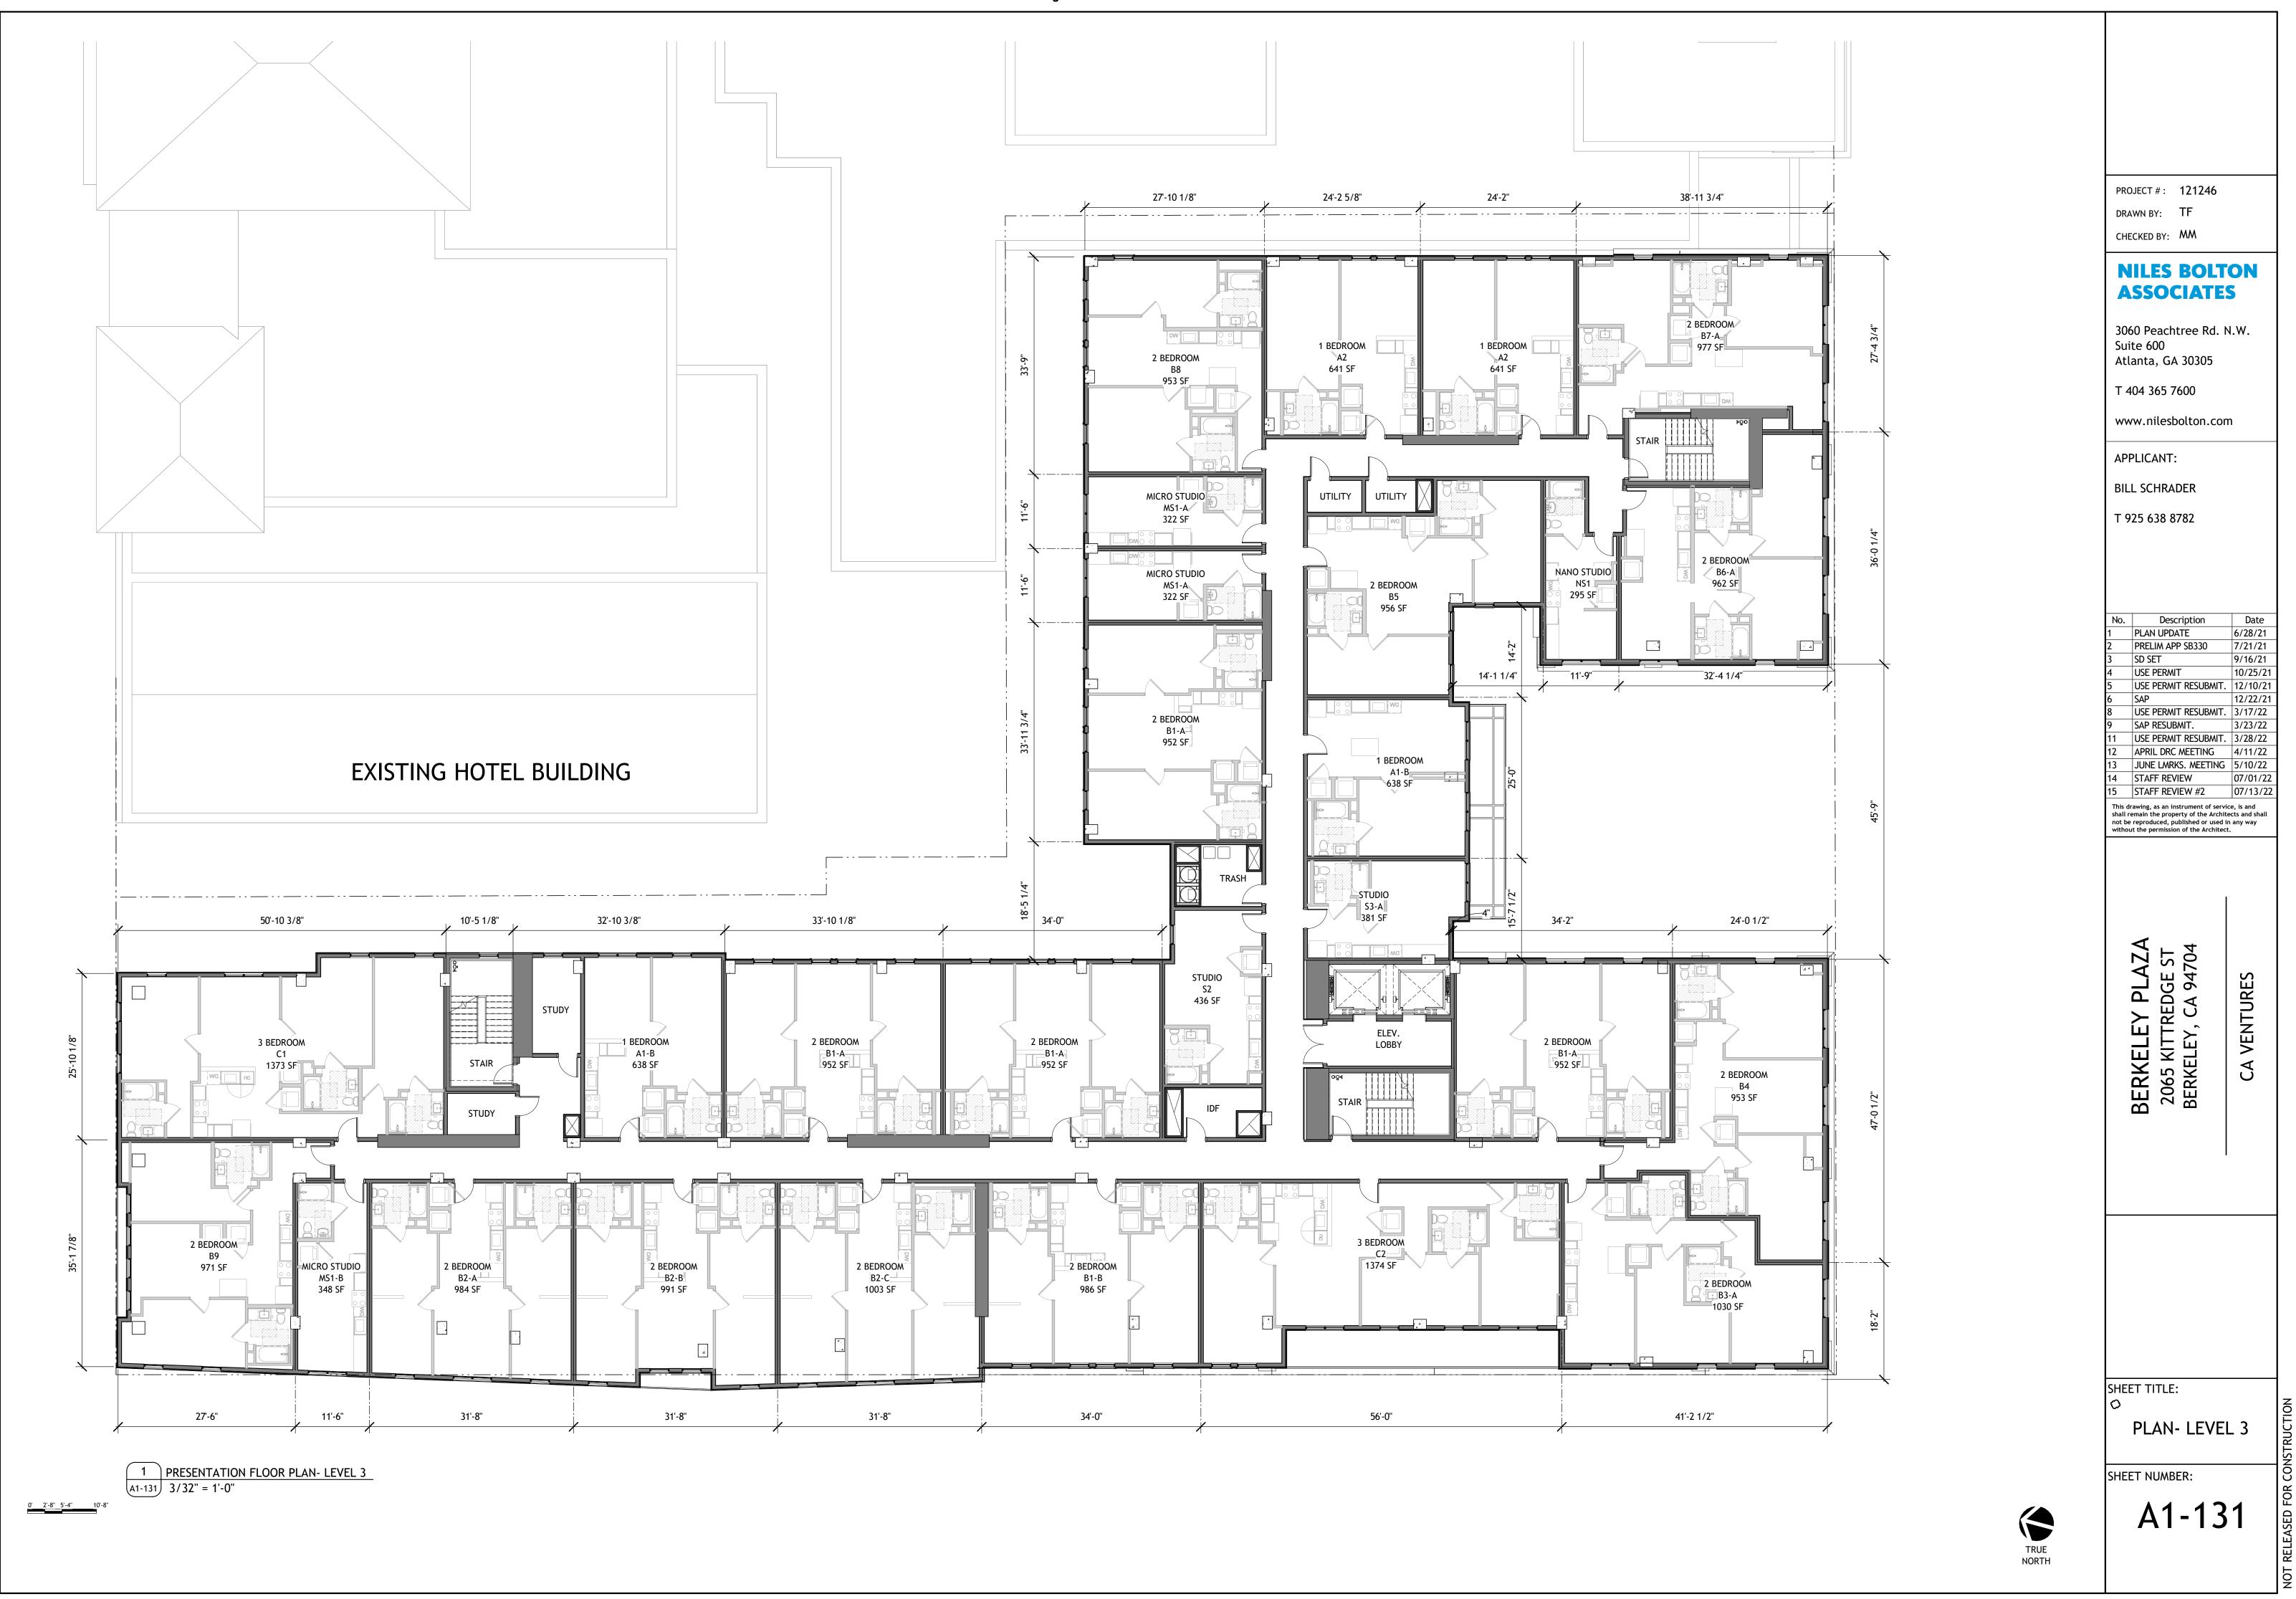

	50 Pe ite 60 anta;	r: BY: S C C C C C C C C C C C C C C C C C C	TF MM BO TA Tree 3030 600 oltor	DLT TES Rd. N	.w.
T 9 No. 5 6 8 9 11 12 13 14 15 16 This d shall r not be	USE P SAP USE P SAP R USE P SAP R USE P SAP R USE P SAP R USE P SAP R USE P SAP R USE P	Desc ERMIT ERMIT ESUB/ ERMIT DRC LMRK REVIS	782 riptior RESU VIT. RESU WIT. RESU WEETI S. MEE EW EW #2 IONS	BMIT. BMIT. IBMIT. NG TING	cts and shall any way
	BERKELEY PLAZA	2065 KITTREDGE ST	BERKELEY, CA 94704		CA STUDENT LIVING BERKELEY, LLC
0	ET NU	_AN	ER:	800 9	-

REL ОТ

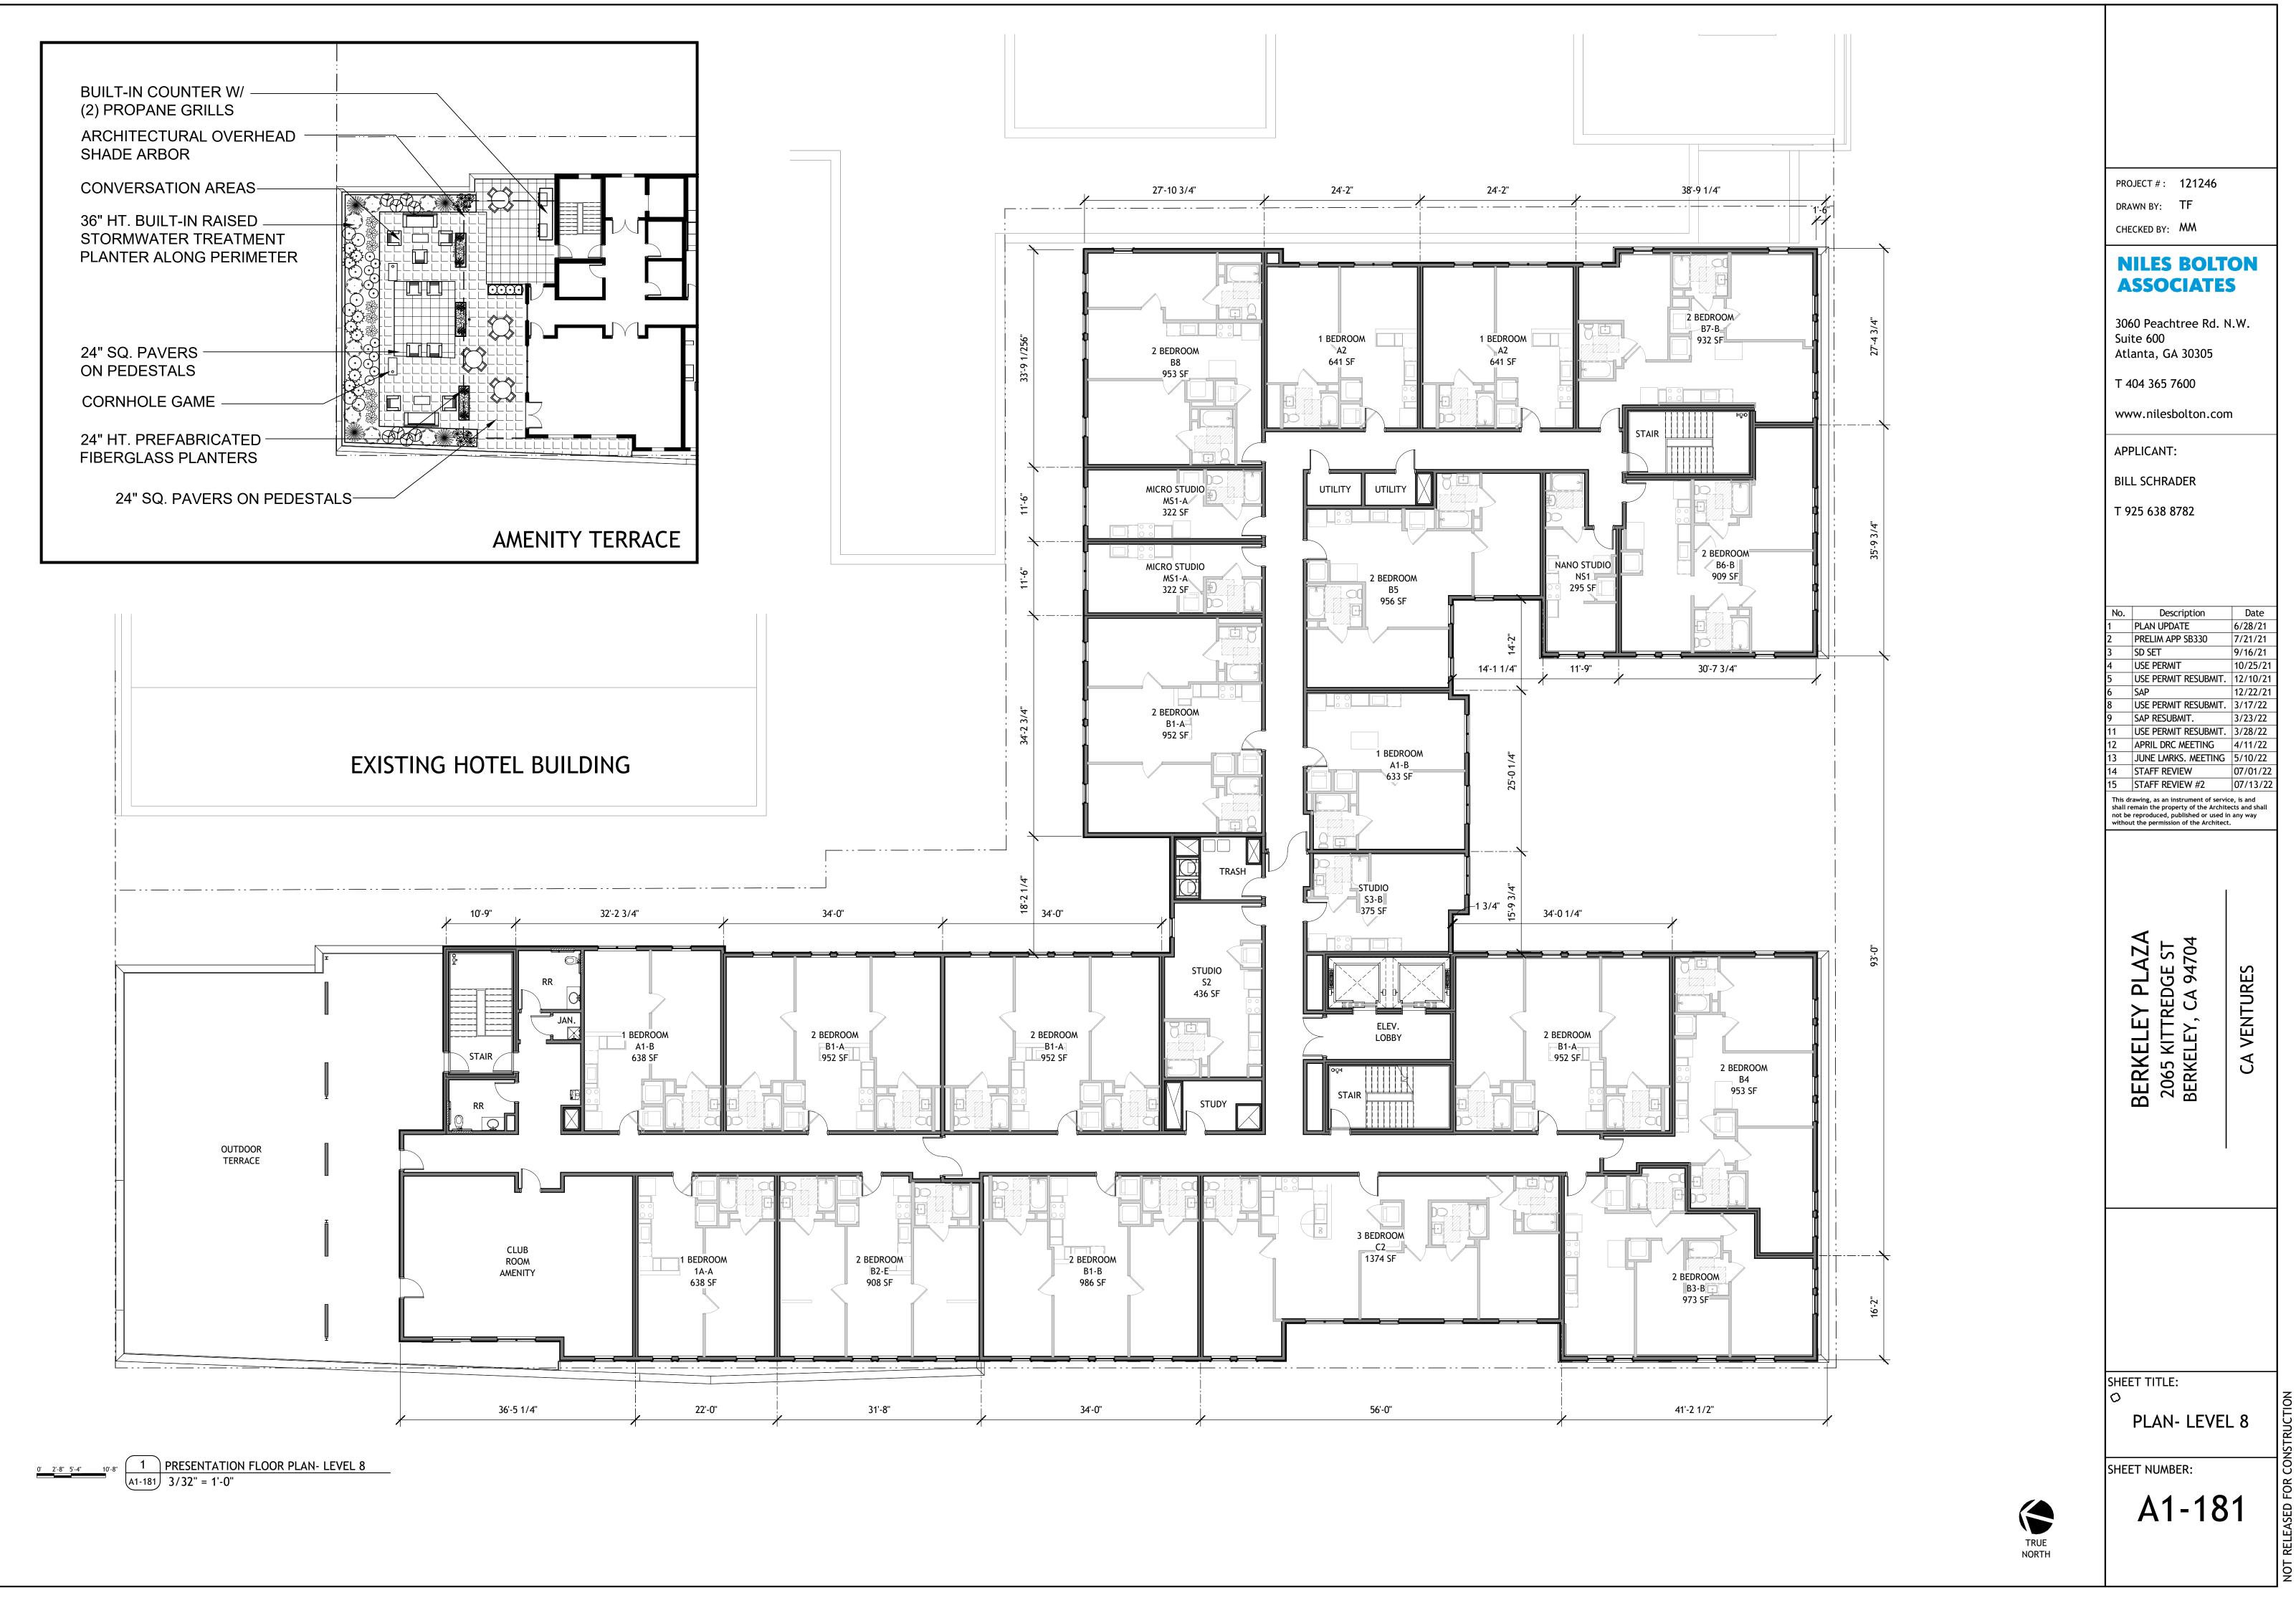TRUE NORTH

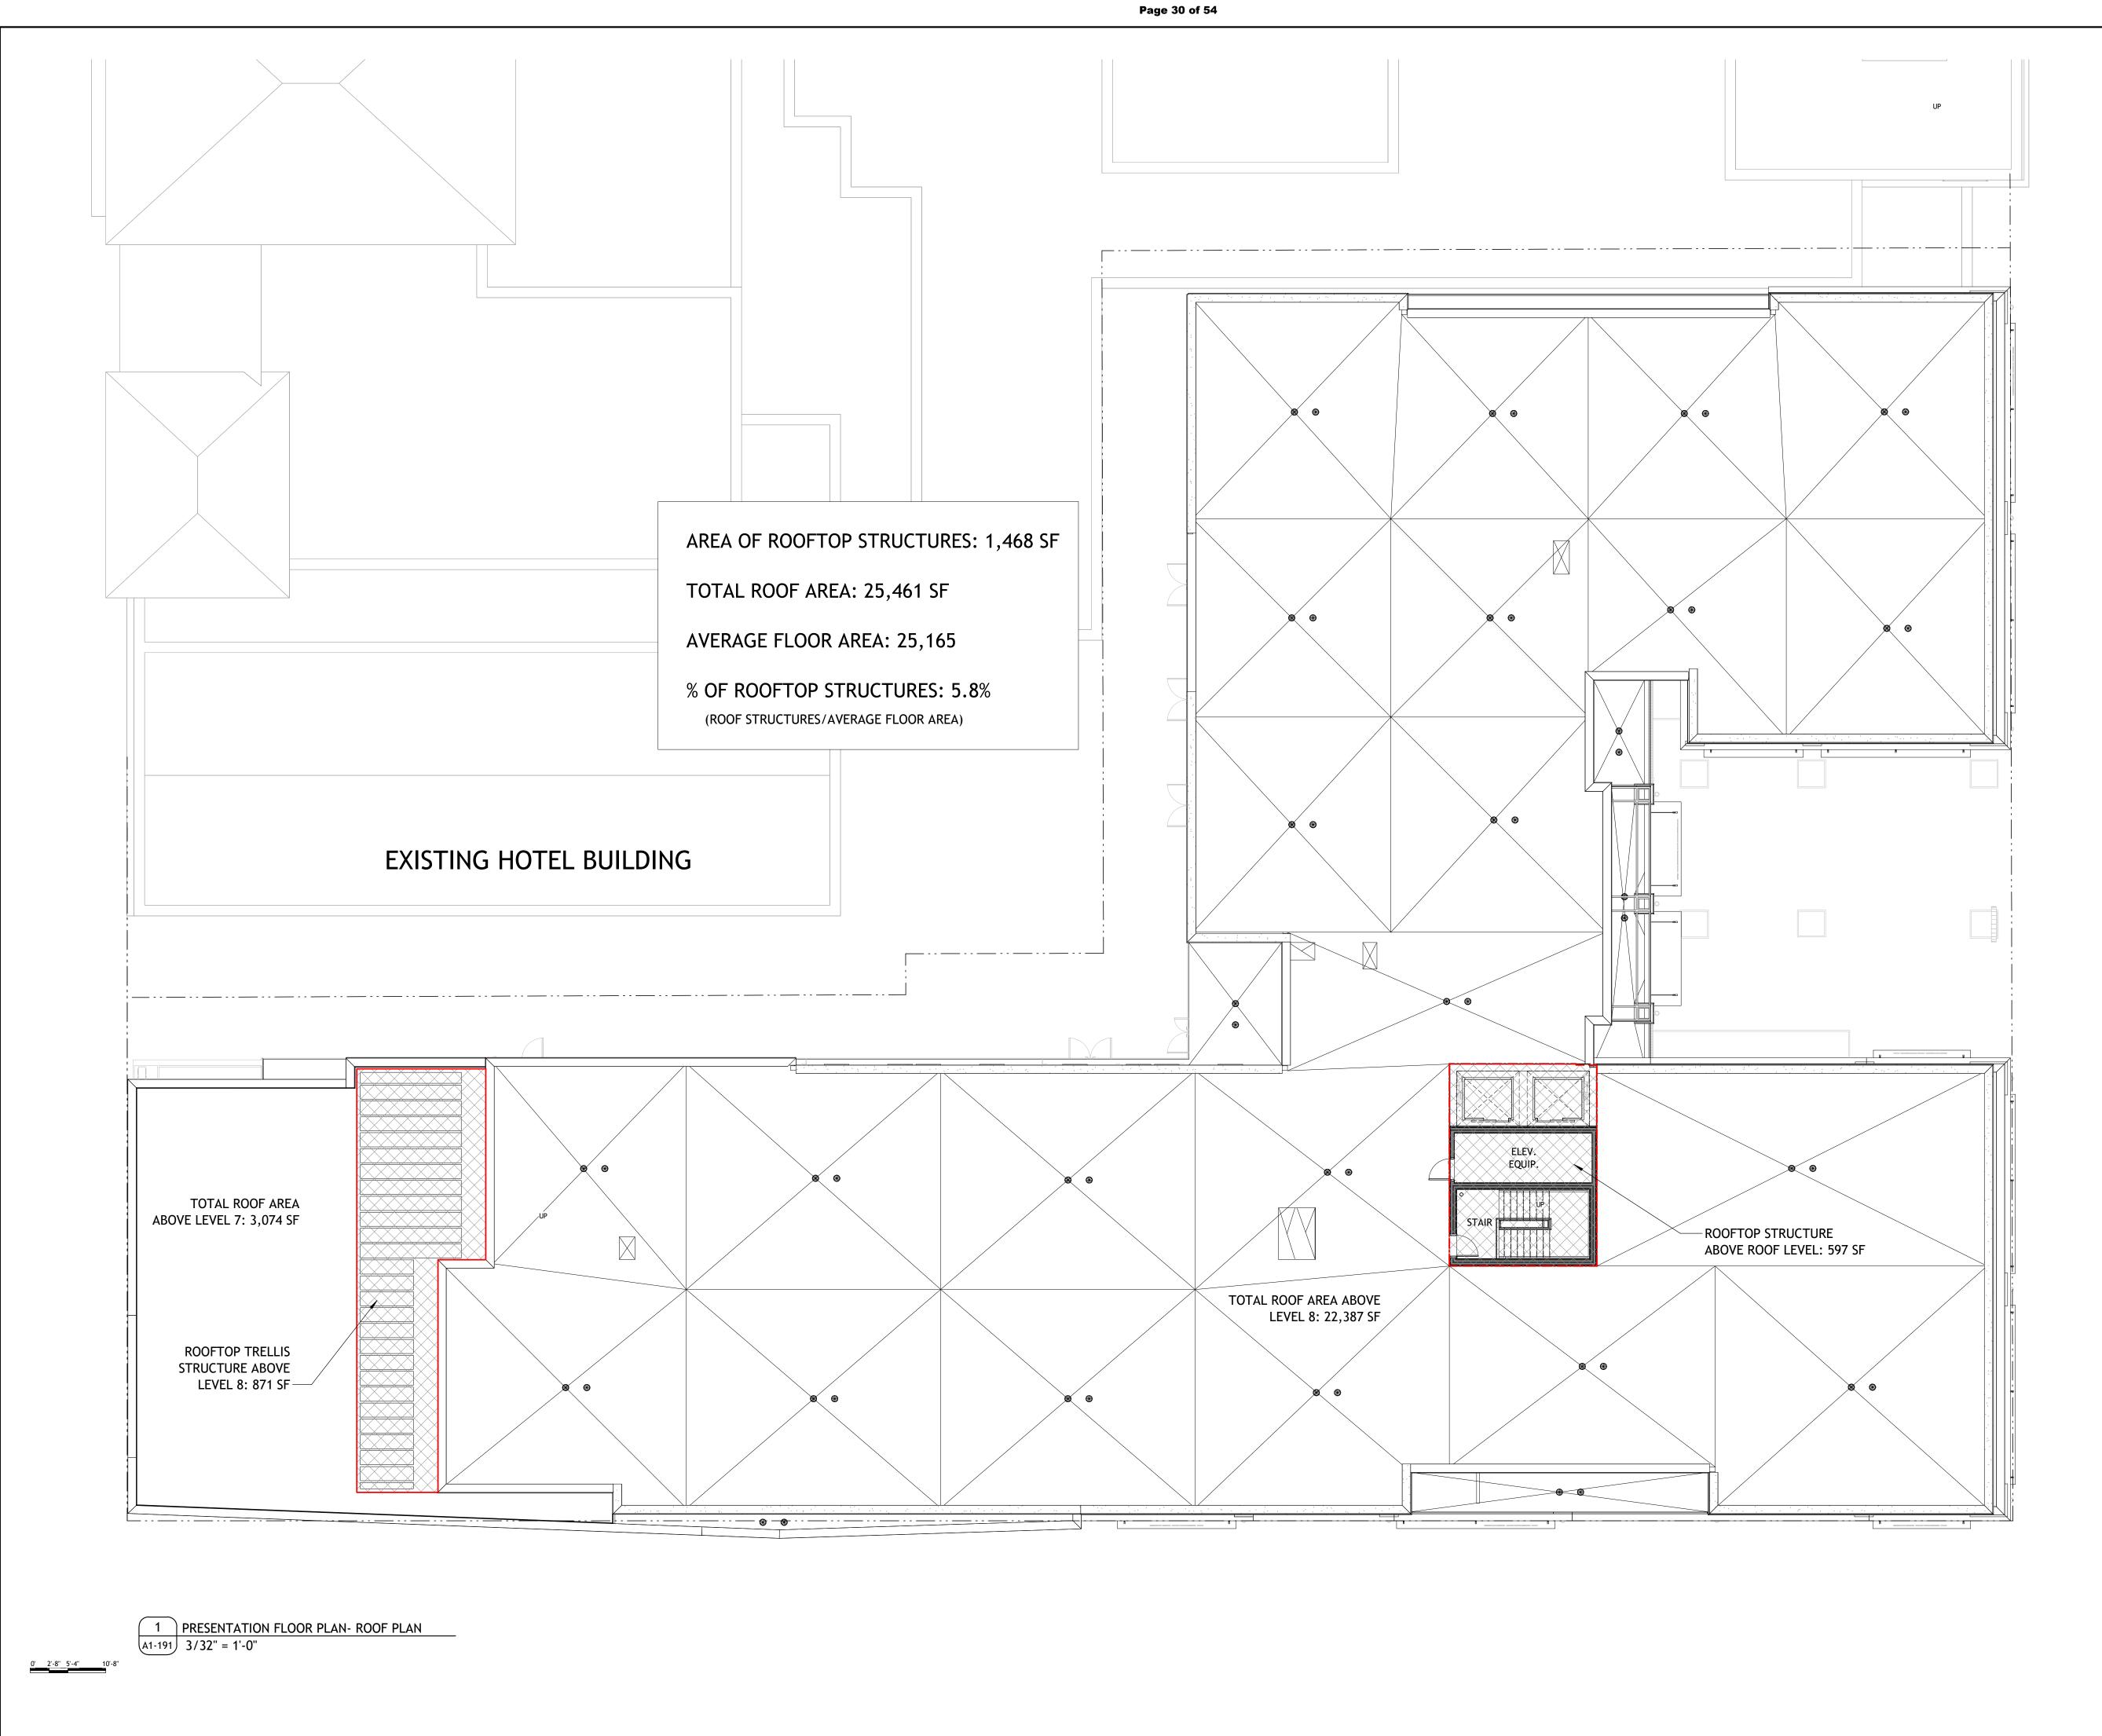



E1 - LIGHT TAN STUCCO	E6 - VINYL WINDOW WITH THERMOFOIL ALUMINUM FINISH	E2 - C
E E E E E E E E E E E E E E E E E E E	E E E E E E E E E E E E E E E E E E E	DECAL SIGNAGE
CO E7 - ALUMINUM CANOPY E8 - EXTERIOR W/		E10- STOREFRONT E3
	OJECTING PROPERTY LINE	

PROJECTING AREA: 5,697 SF TOTAL FACE AREA: 22,996 SF

PROJECTING AREA: 24.8%

2 PRESENTATION-ELEVATION- WEST PROJECTION DIAGRAM A3-001 1" = 30'-0"

			ı
		Keynote Legend	
	Key Value	Keynote Te	xt
	E1 E2 E3	LIGHT TAN STUCCO CHARCOAL GREY STUCC DARK TAN STUCCO	0
	E4 E5	BRICK WHITE FIBER CEMENT	
	E6	VINYL WINDOW WITH TH ALUMINUM FINISH	IERMOFOIL
	E7 E8 E10	ALUMINUM CANOPY EXTERIOR WALL SCONCE STOREFRONT	
	E13 E15	GLASS RAILING MESH SCREENING	
			-
CHARCOAL GREY STUCCO	VARIES, MAX 5'	5. ₩ X	$\frac{\text{LEVEL 8}}{258' \cdot 0'} \bigcirc \\ \\ \frac{\text{LEVEL 8}}{247' \cdot 3''} \bigcirc \\ \\ \frac{\text{LEVEL 7}}{237' \cdot 3''} \bigcirc \\ \\ \frac{11}{227' \cdot 3''} \bigcirc \\ \\ \frac{12}{227' \cdot 3''} \bigcirc \\ \\ \frac{12}{227' \cdot 3''} \bigcirc \\ \\ \\ \frac{12}{227' \cdot 3''} \bigcirc \\ \\ \\ \frac{12}{217' \cdot 3''} \bigcirc \\ \\ \\ \frac{12}{207' \cdot 3''} \bigcirc \\ \\ \\ \\ \frac{15}{217' \cdot 3''} \bigcirc \\ \\ \\ \\ \\ \frac{15}{217' \cdot 3''} \bigcirc \\ \\ \\ \\ \\ \\ \\ \\ \\ \\ \\ \\ \\ \\ \\ \\ \\$
	10-0"		LEVEL 3 197'-3"
	,		LEVEL 2 187'-3"
	10:-3"		187'-3" 🖤
	<u> </u>		LEVEL 1.2
	39"		LEVEL 1.2 177'-0"
3 - DARK TAN STUCCO E4 - BRICK			ST GRADE 171'-0"
			<u>c</u> SI SI

DRAWN BY: TF CHECKED BY: MM NILES BOL ASSOCIAT 3060 Peachtree Rd Suite 600 Atlanta, GA 30305 T 404 365 7600	ES
www.nilesbolton.c APPLICANT: BILL SCHRADER T 925 638 8782	om
No.Description2PRELIM APP SB3308USE PERMIT RESUBM9SAP RESUBMIT.11USE PERMIT RESUBM12APRIL DRC MEETING13JUNE LMRKS. MEETIN14STAFF REVIEW15STAFF REVIEW #2	3/23/22 IT. 3/28/22 4/11/22
This drawing, as an instrument of s shall remain the property of the Ar not be reproduced, published or us without the permission of the Arch	chitects and shall ed in any way
BERKELEY PLAZA 2065 KITTREDGE ST BERKELEY, CA 94704	CA VENTURES
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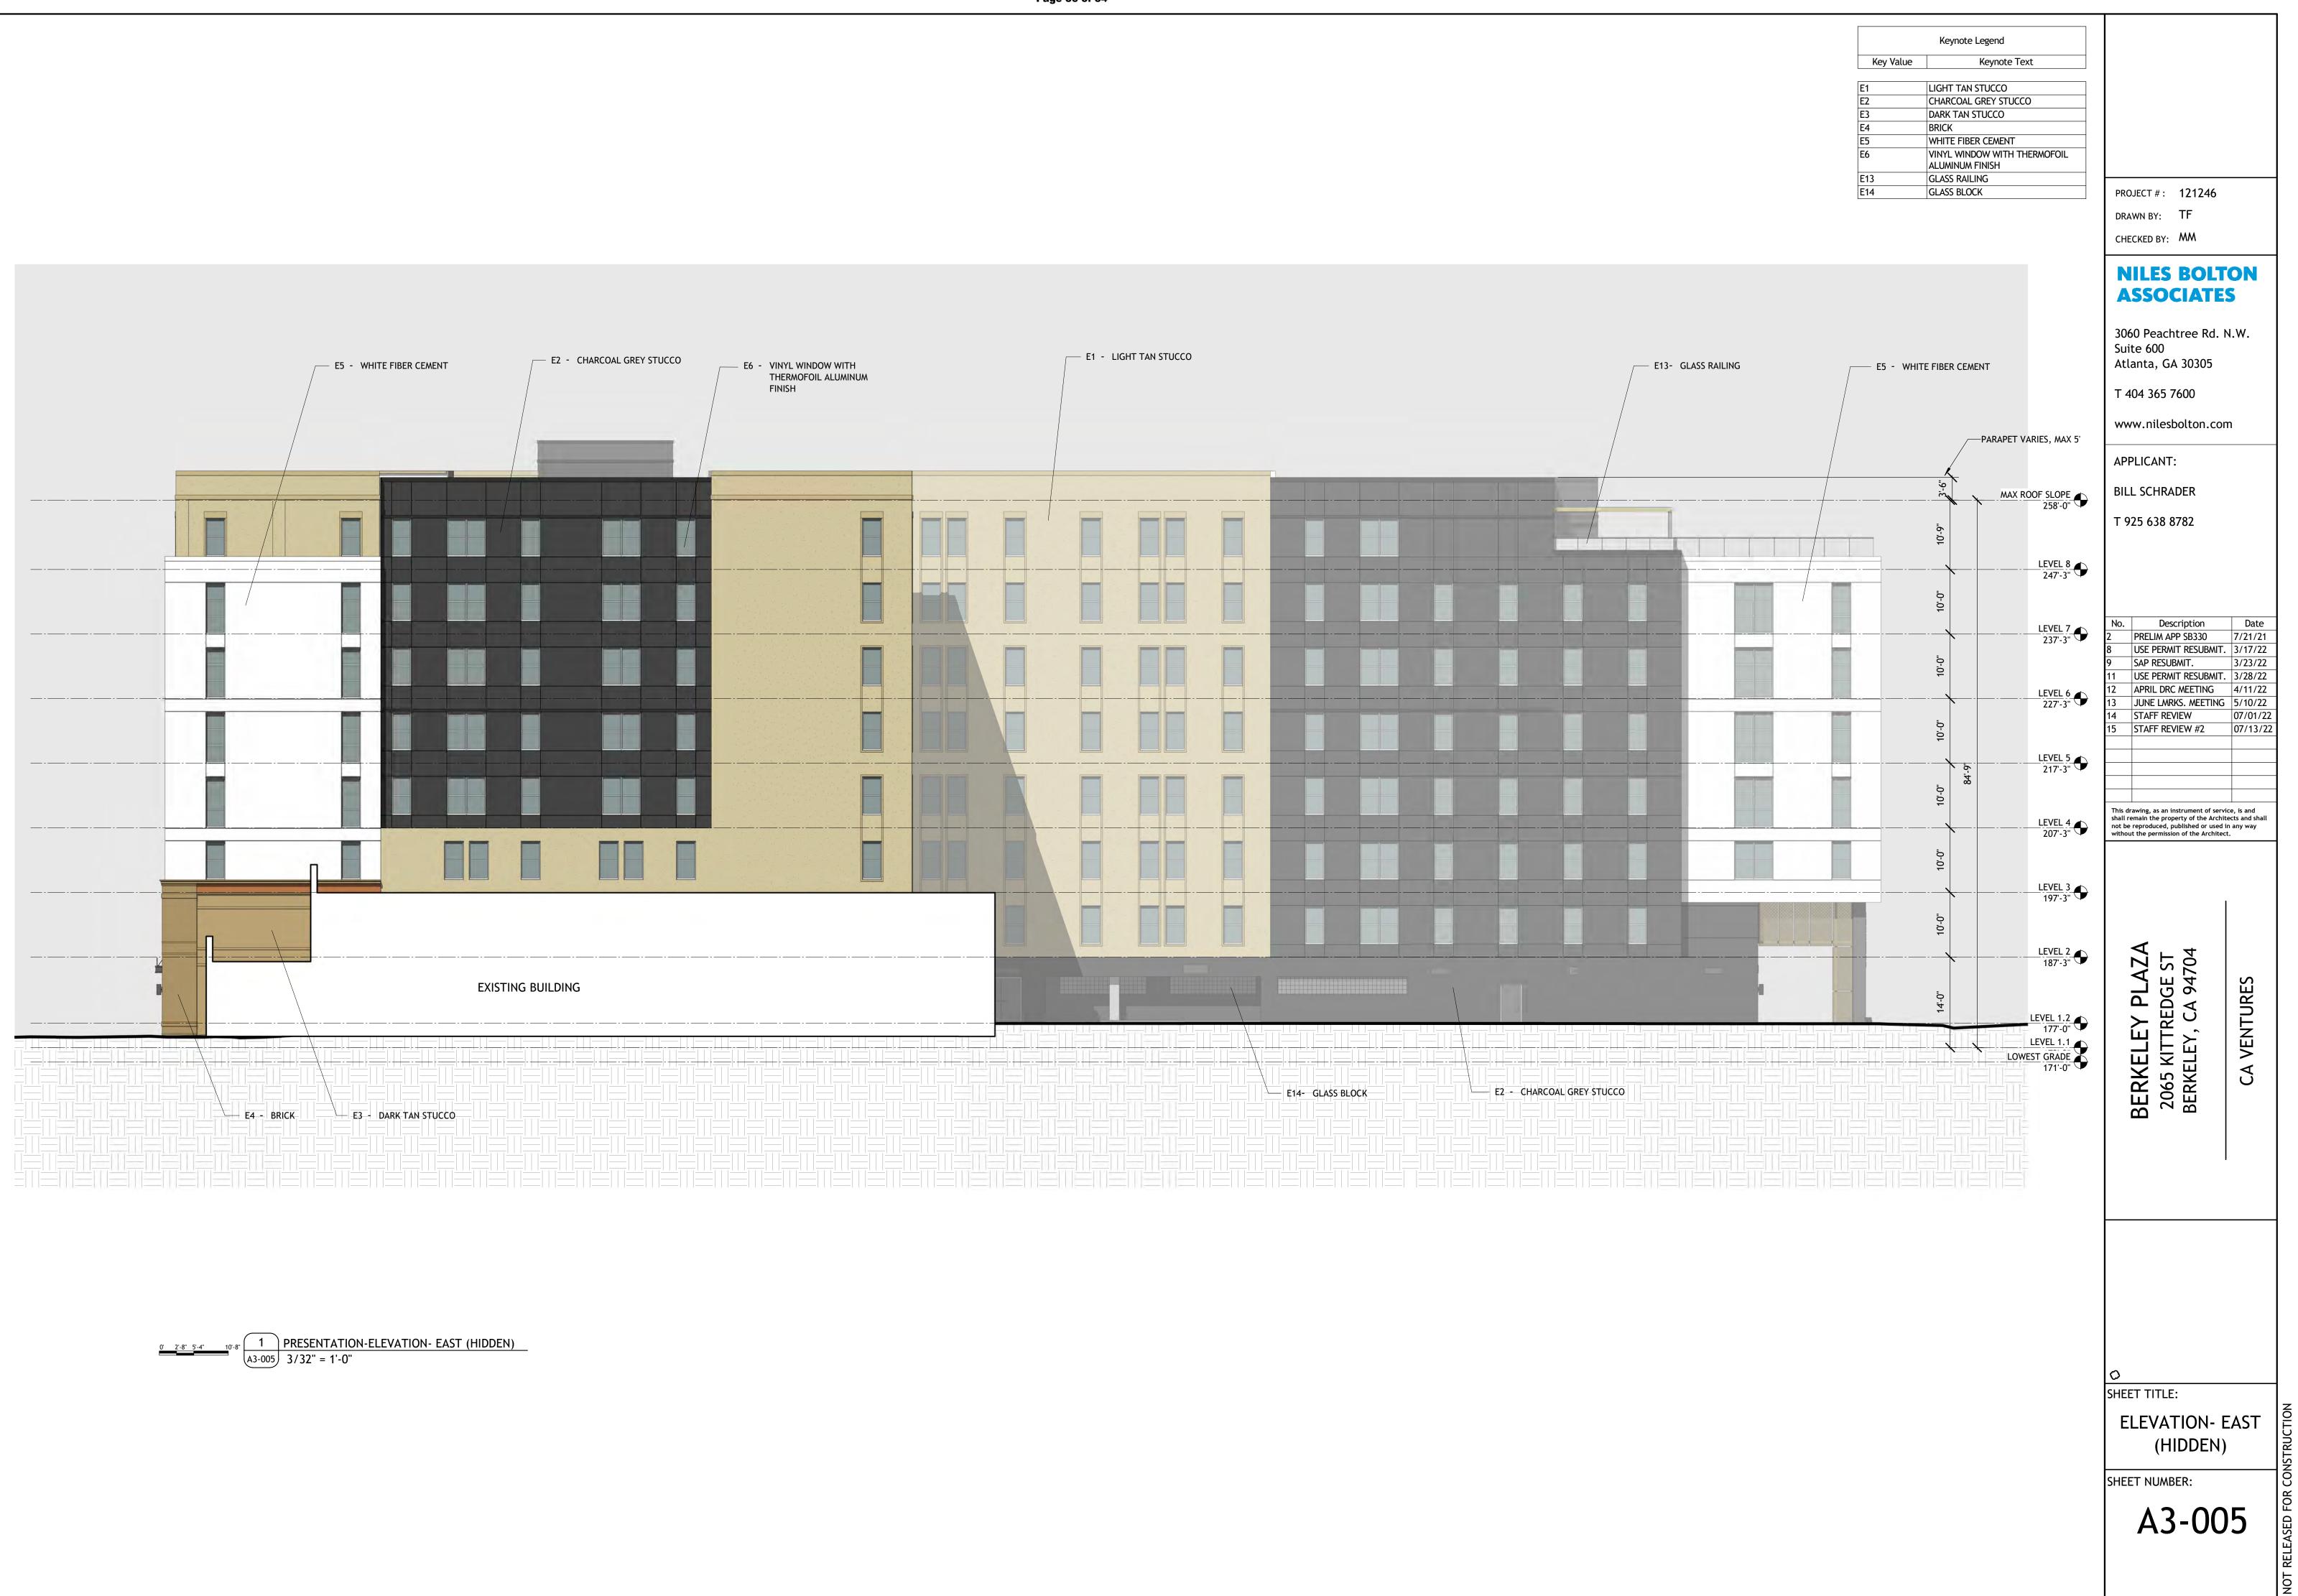
EXISTING BUI	∟ [

0' 2'-8" 5'-4" 10'-8"



1PRESENTATION-ELEVATION- NORTH (HIDDEN)A3-0043/32" = 1'-0"

		Keynote Lege	end		
	Key Value E1 E2 E6 E12				
				PROJECT # : 121246 DRAWN BY: Author CHECKED BY: Checker	
				NILES BOL ASSOCIATE 3060 Peachtree Rd. Suite 600 Atlanta, GA 30305 T 404 365 7600 www.nilesbolton.co APPLICANT:	ES . n.w.
PAF	RAPET VARIES, MAX	5'\		BILL SCHRADER T 925 638 8782	
		10-0" 10'-0" 10'-0" 10'-0" 10'-0" 10'-0" × 10'	AX ROOF SLOPE 258'-0"	No. Description 8 USE PERMIT RESUBMIT 9 SAP RESUBMIT. 11 USE PERMIT RESUBMIT 12 APRIL DRC MEETING 13 JUNE LMRKS. MEETING 14 STAFF REVIEW 15 STAFF REVIEW #2	3/23/22 T. 3/28/22 4/11/22 G 5/10/22 07/01/22 07/13/22
		10-3"	LEVEL 2 187'-3"	BERKELEY PLAZA 2065 KITTREDGE ST BERKELEY, CA 94704	CA VENTURES
				SHEET TITLE: ELEVATION- N (HIDDEN) SHEET NUMBER: A3-00)








- CHARCOAL STUCCO

		[PROJECT # : 121246 PRAWN BY: Author CHECKED BY: Checker	r
			NILES BOL' ASSOCIATE	
			060 Peachtree Rd. uite 600 Itlanta, GA 30305	N.W.
	ROOF 257'-3"		404 365 7600 vww.nilesbolton.co	om
			PPLICANT:	
	LEVEL 8 247'-3"		ILL SCHRADER 925 638 8782	
	<u>LEVEL 7</u> 237'-3"	N	· ·	Date
	<u>LEVEL 6</u> 227'-3"	9 8 12 13 15	SAP RESUBMIT. USE PERMIT RESUBMIT APRIL DRC MEETING JUNE LMRKS. MEETING STAFF REVIEW #2	4/11/22
	<u>LEVEL 5</u> 217'-3"		is drawing, as an instrument of se	rvice, is and
<u>S</u>	<u>LEVEL 4</u> 207'-3"	sh no	all remain the property of the Arcl t be reproduced, published or use hout the permission of the Archit	hitects and shall d in any way ect.
	LEVEL 3 197'-3"		Y PLAZA REDGE ST CA 94704	RKELEY, LLC
	<u>LEVEL 2</u> 187'-3"		BERKELEY PLAZA 2065 KITTREDGE ST BERKELEY, CA 94704	CA STUDENT LIVING BERKELEY,
	LEVEL 1.2 177'-0"		BER 206 BER	CA STUDEN
	ASSOCIATED WITH THE EXISTING BUILDING	то		
	RS SHOWIN IN PHOTO 4/A0-001 - A NEW EGR EXITING FROM THE ELEVATED LEVELS AS ILL			
IE OVERALL SITE PLAN AN	D THE ENLARGED PLAN DIAGRAMS ON SHEET	A1-201.		
XISTING ELECTRICAL ROO	CCESS THE NEW ELECTRICAL ROOM AS SHOW M IS CURRENTLY LOCATED WITHIN THE AREA RELOCATED	TO BE	ELEVATIO SOUTH ENLA	
LISHED AND NEEDS TO BE			(KITTREDGE	ST.)

RELEASED

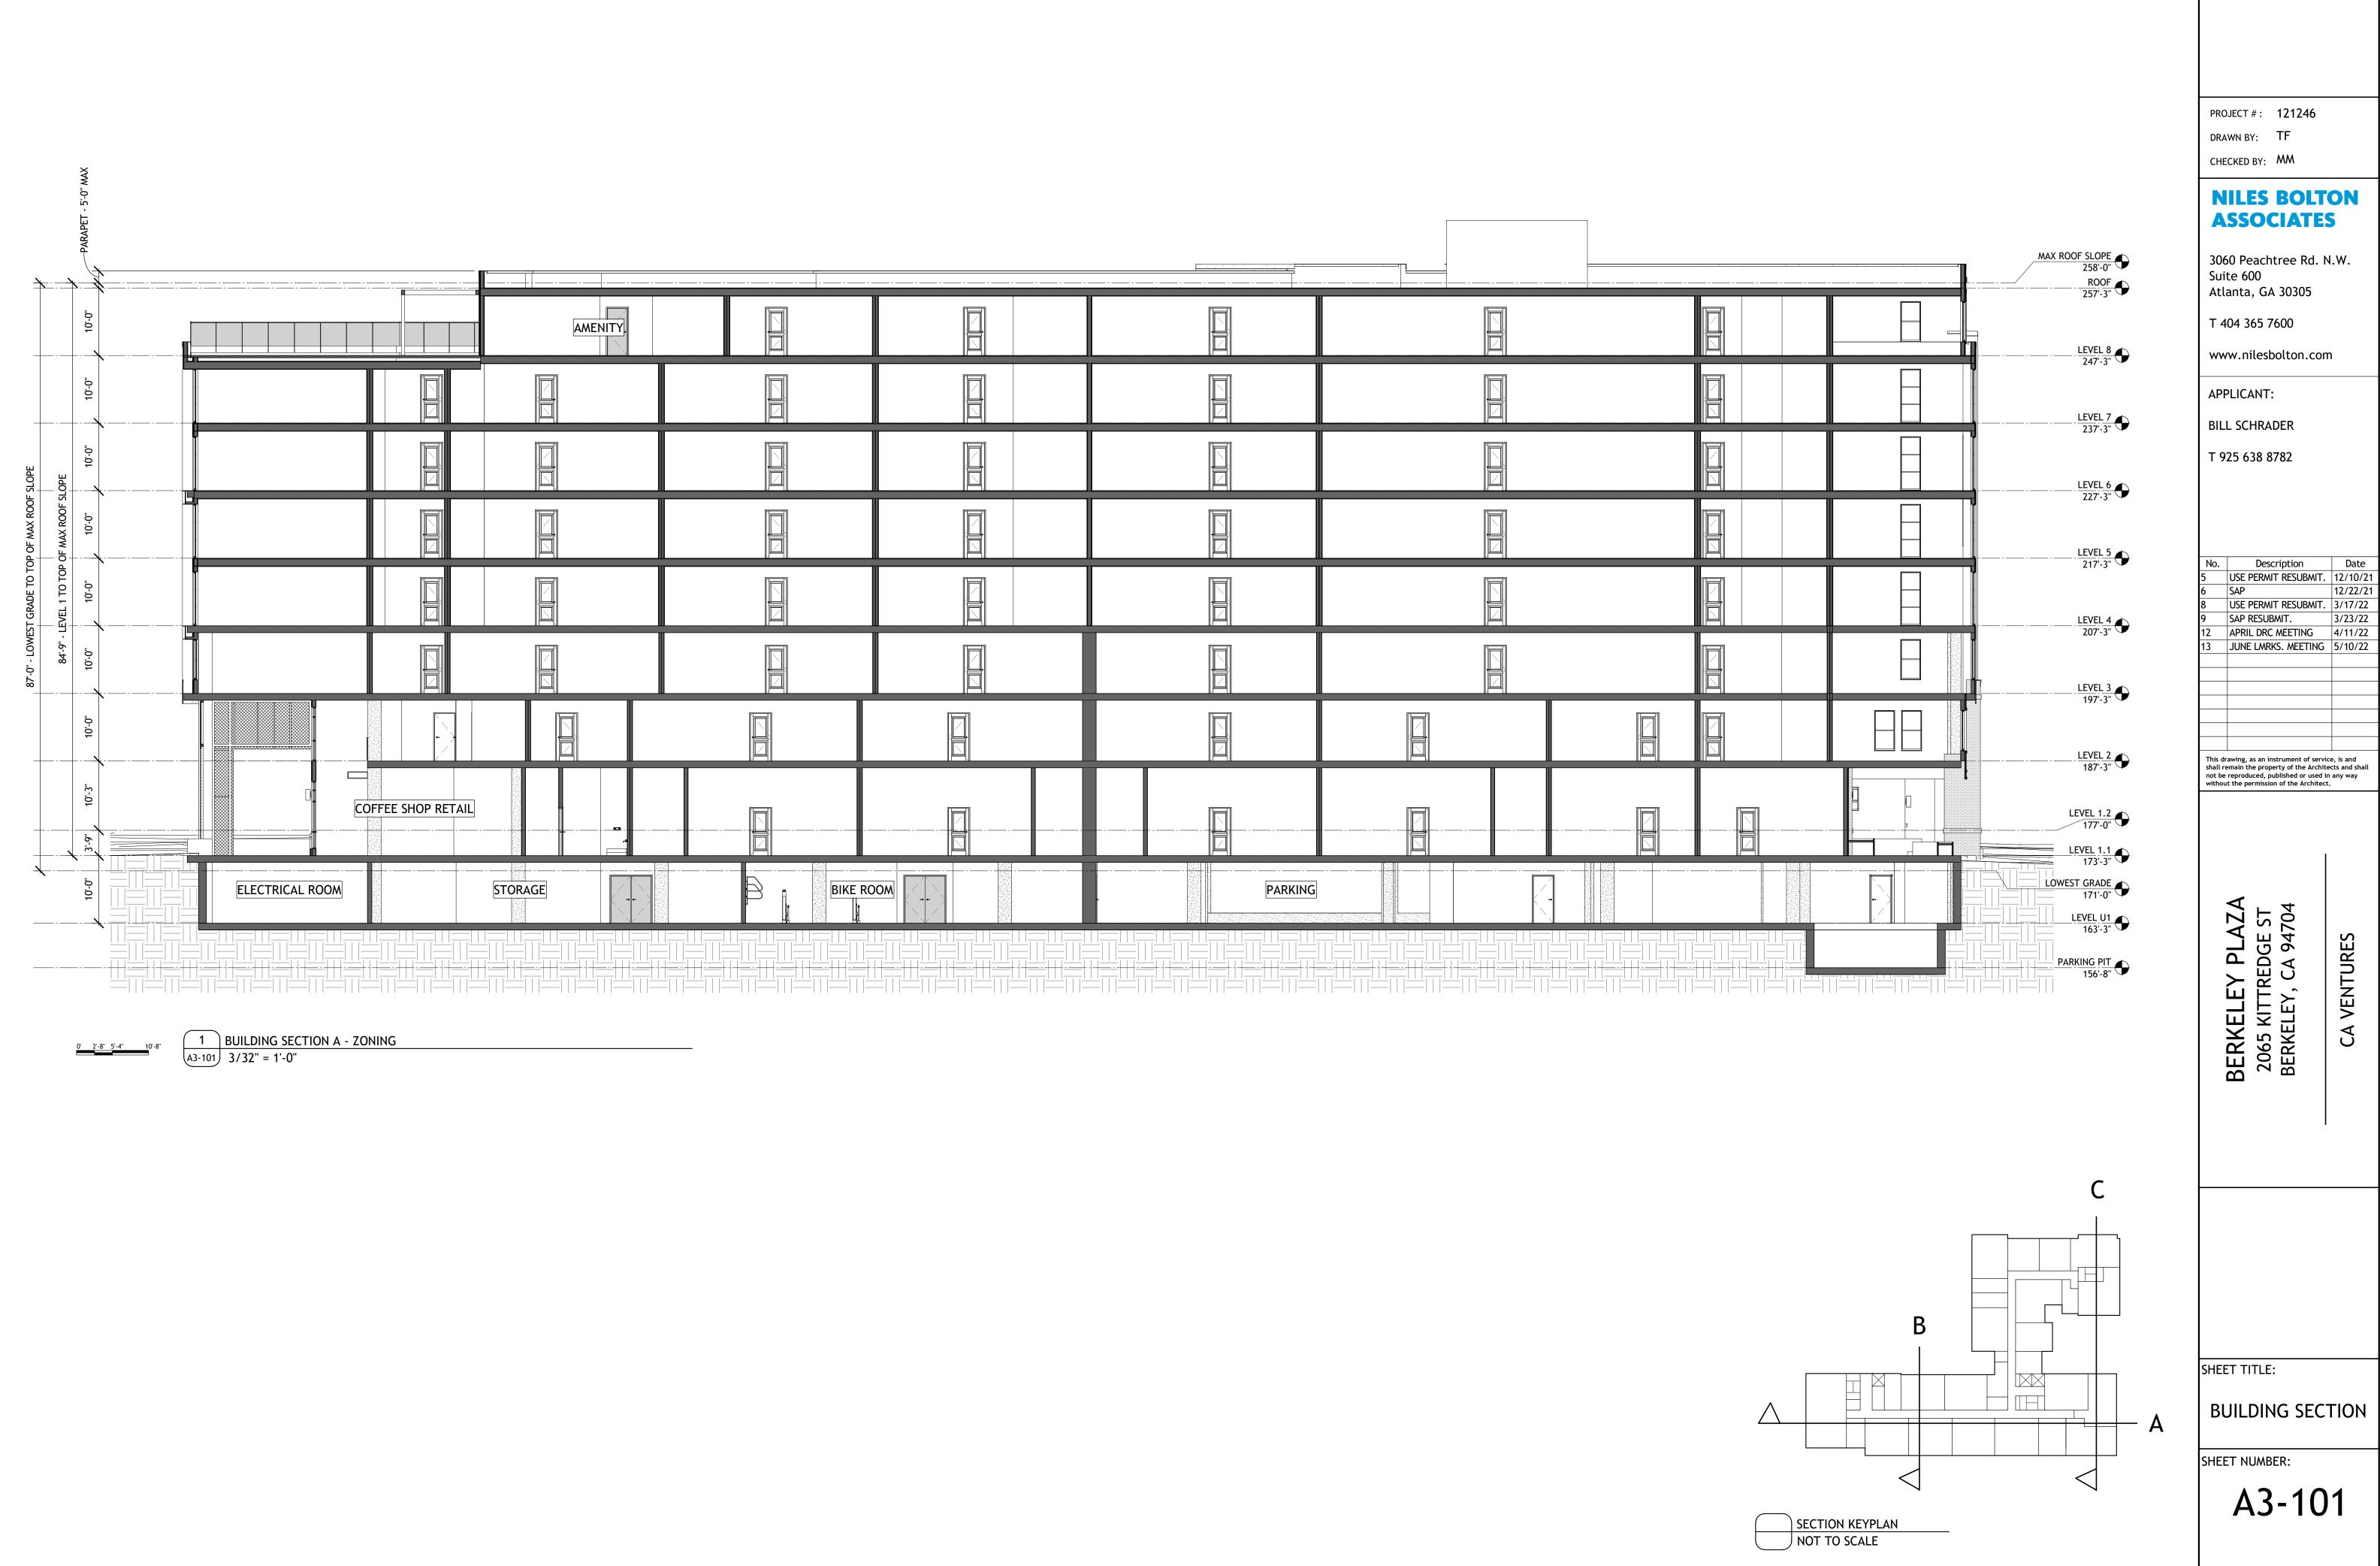

RUCT CO RELEASED FOR

NILES BOLTON ASSOCIATES

3060 Peachtree Rd. N.W.


www.nilesbolton.com

Date

12/22/21

3/23/22

CA VENTURES

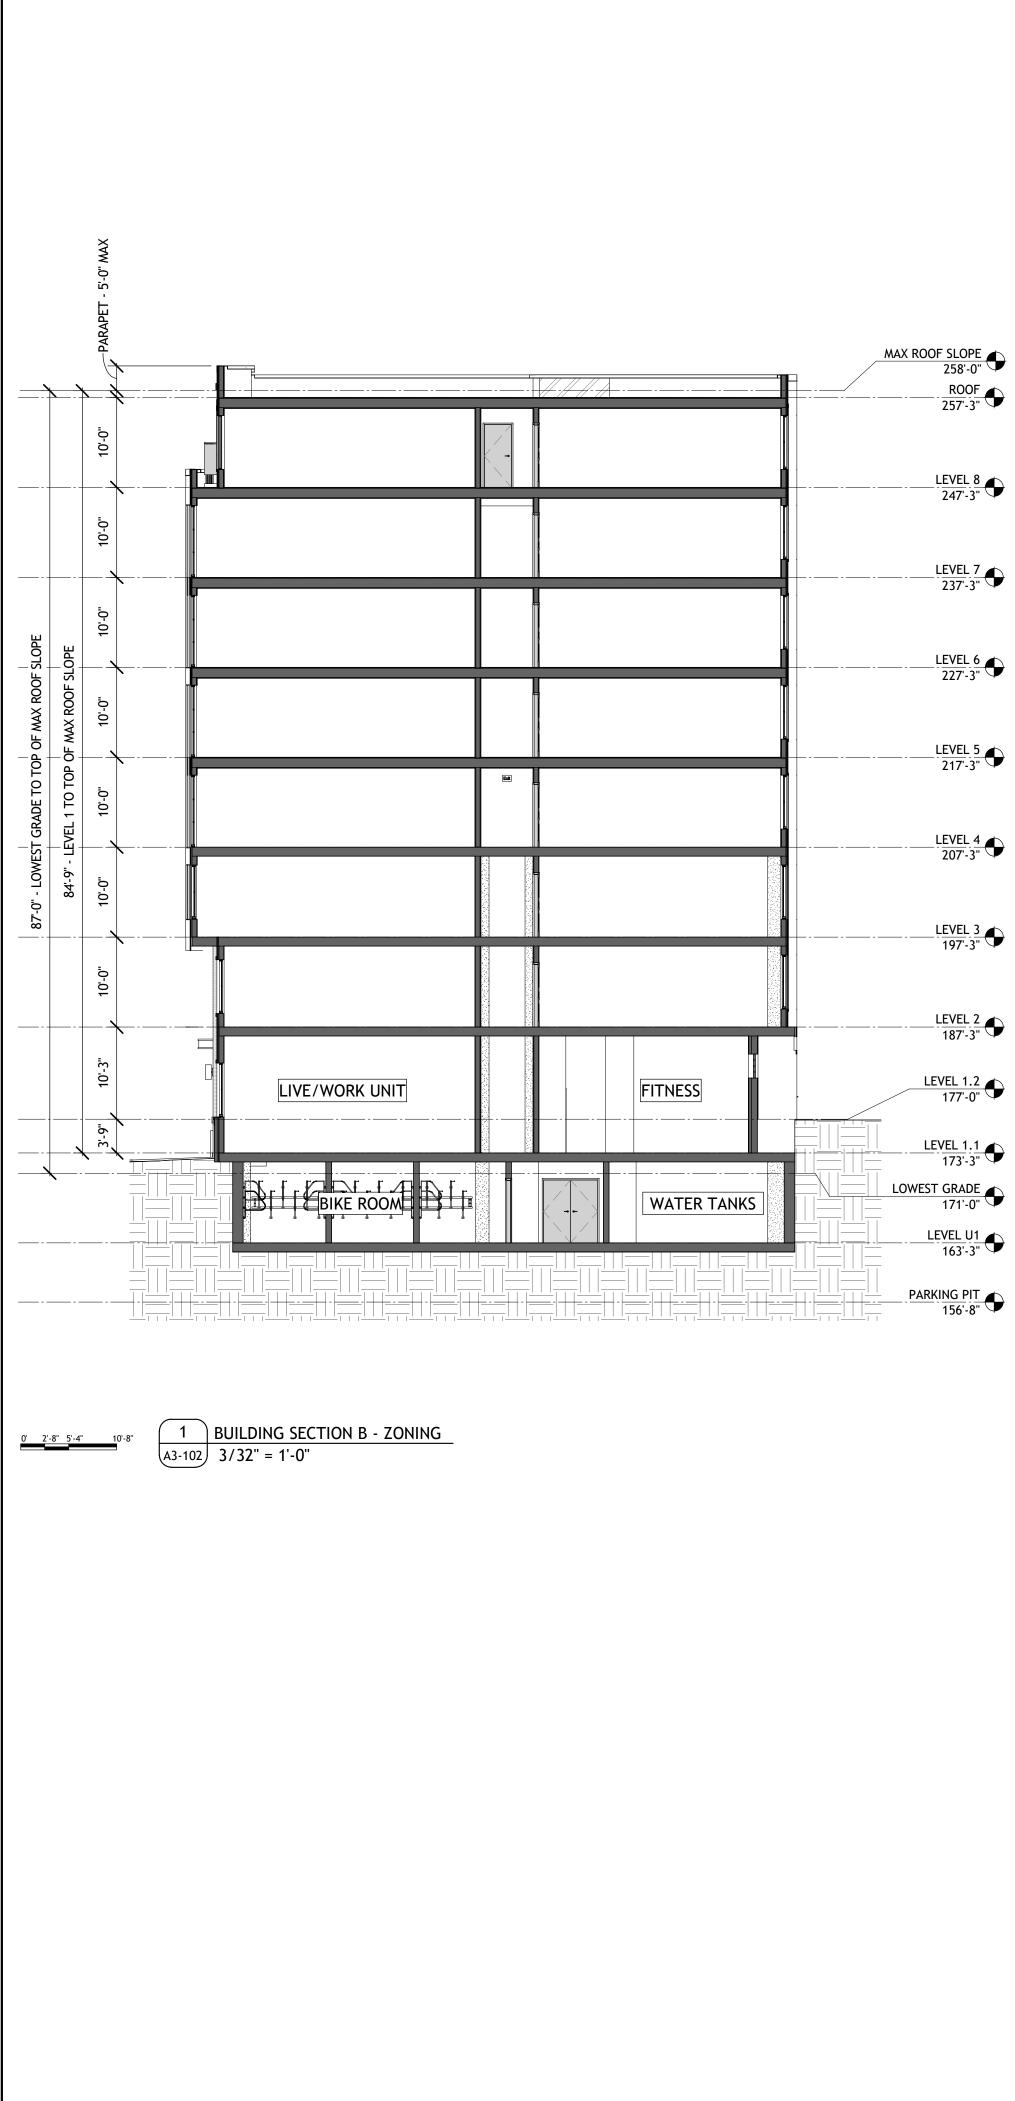

AX ROOF SLOPE 258'-0" ROOF 257'-3"		×、			
257'-3" U		10'-0"			
LEVEL 7 237'-3"		10:-0"			
LEVEL 6 227'-3"	LOPE	10-0.			
LEVEL 5 217'-3"	C GRADE TO TOP OF MAX ROOF SLOPE VEL 1 TO TOP OF MAX ROOF SLOPE	10.0"			
LEVEL 4	- GRADE TO T(VEL 1 TO TOP	10-0"			

2 BUILDING SECTION C - ZONING A3-102 3/32" = 1'-0"

PARKING

ENTRY

- Y+

87


10'-0"

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0' 2'-8" 5'-4" 10'-8"


84



RUCT RELEASED FOR

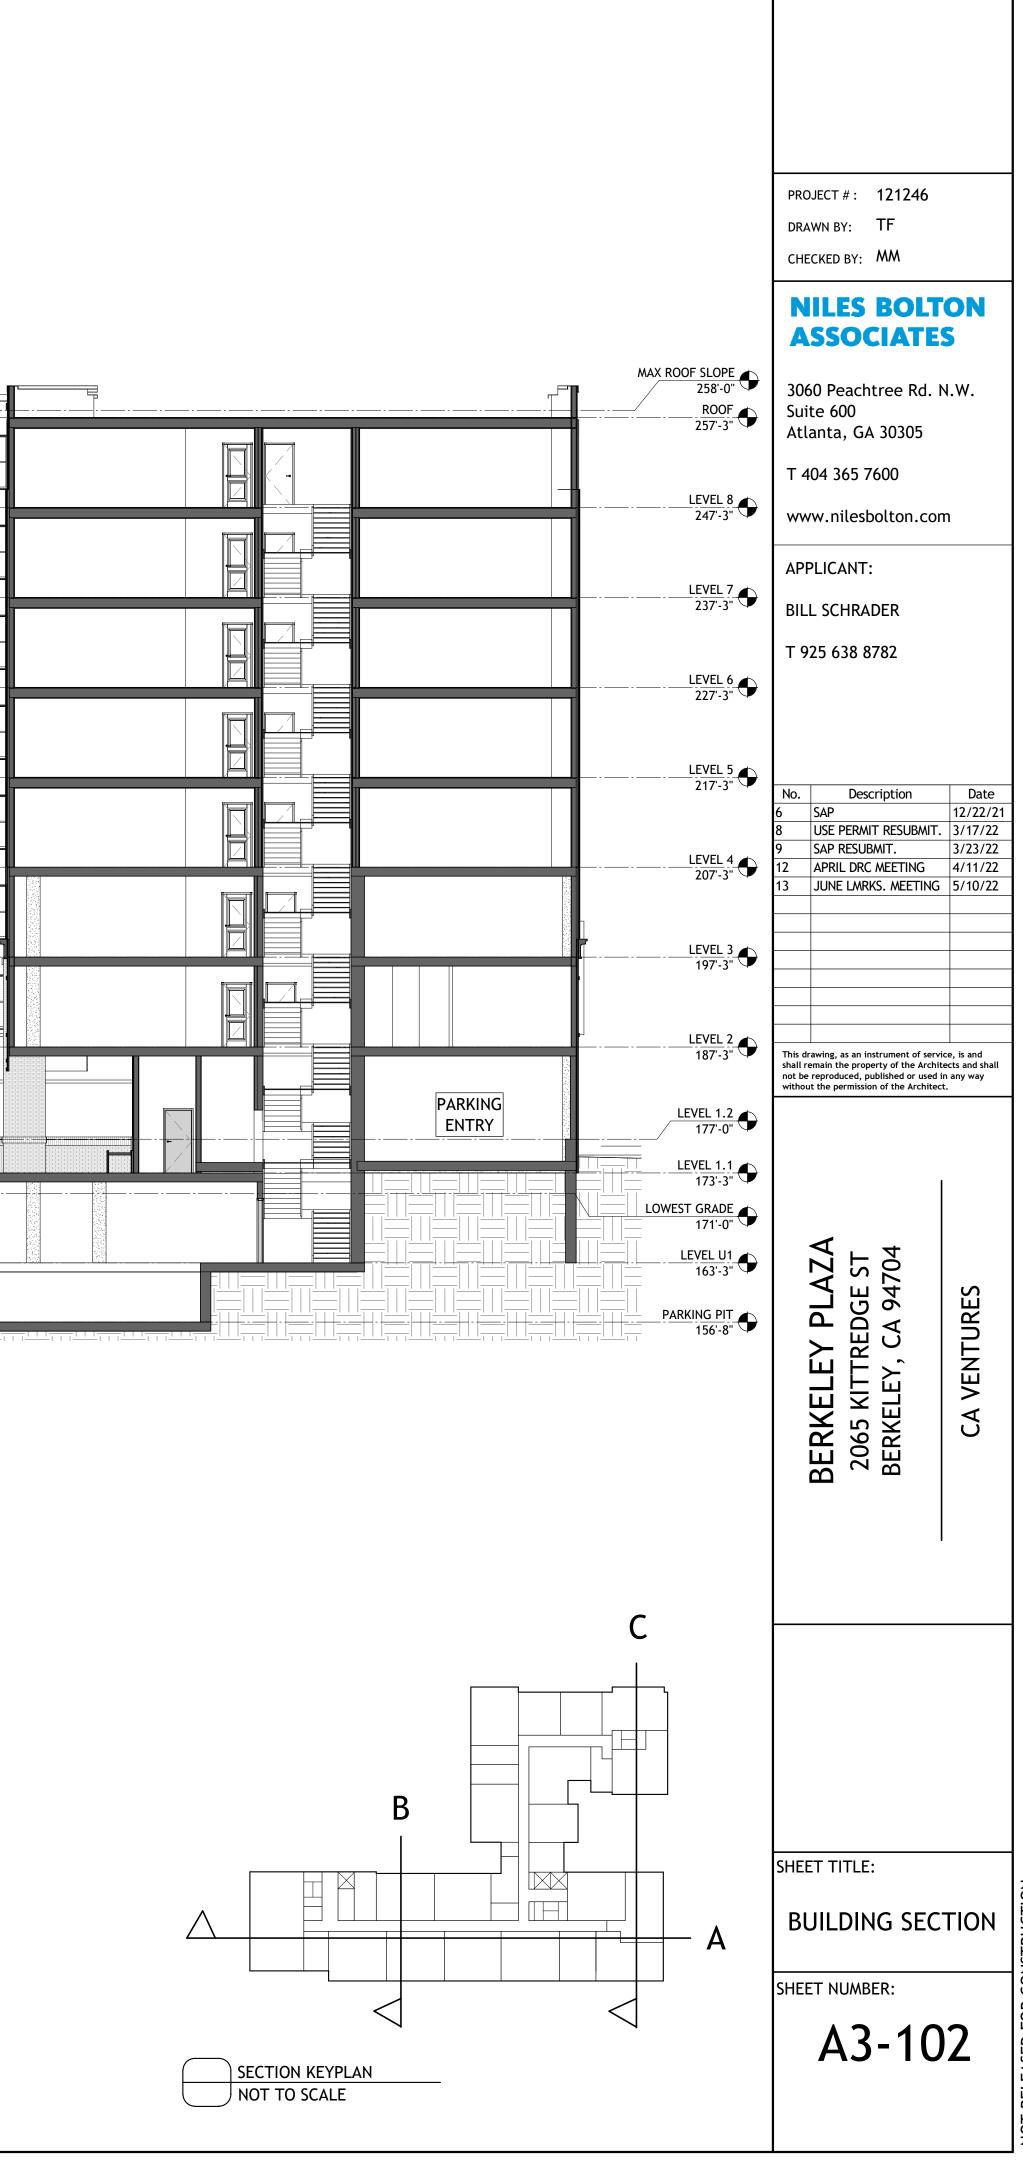


1 PERSPECTIVE - KITTREDGE ST AND HAROLD WAY CORNER A3-201 NOT TO SCALE

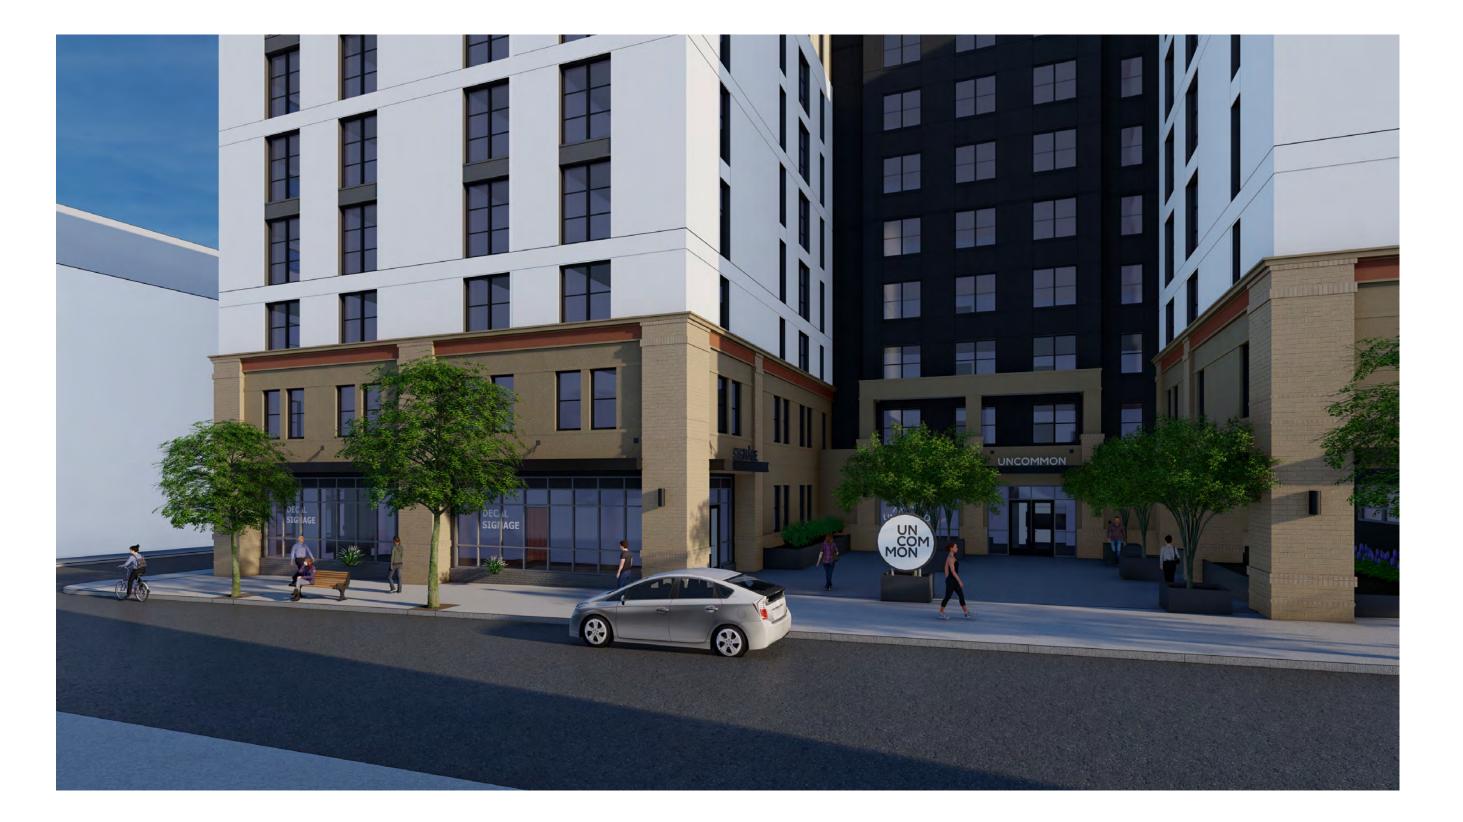

3 PERSPECTIVE - PERSPECTIVE - KITTREDGE ST PLAZA AND RETAIL A3-201 NOT TO SCALE



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2 PERSPECTIVE - KITTREDGE ST RETAIL SPACE
A3-201 NOT TO SCALE
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4 PERSPECTIVE - PERSPECTIVE - KITTREDGE ST PLAZA AND RETAIL A3-201 NOT TO SCALE

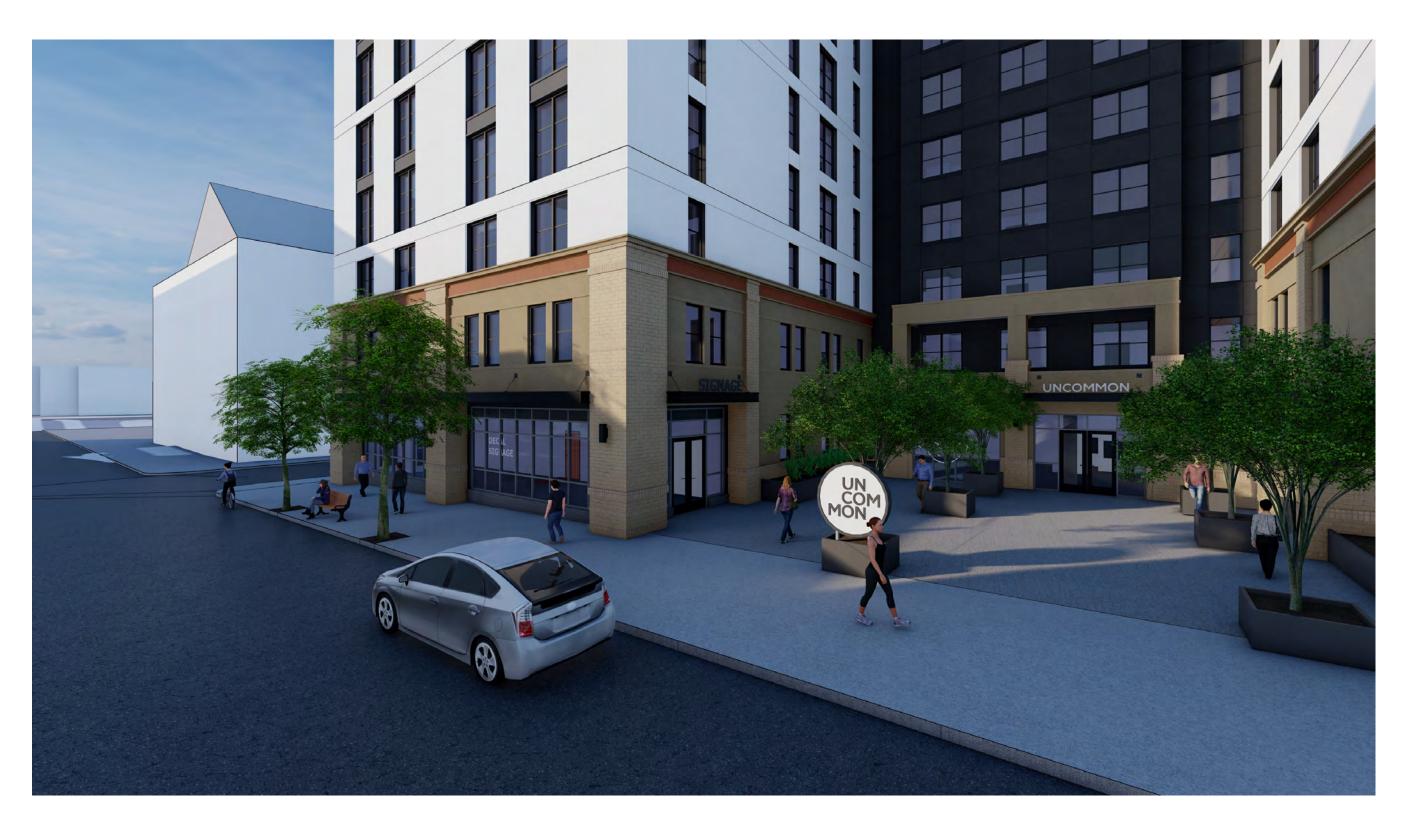PROJECT # : 121246 DRAWN BY: TF, RK CHECKED BY: MM

NILES BOLTON ASSOCIATES

3060 Peachtree Rd. N.W. Suite 600 Atlanta, GA 30305

T 404 365 7600

www.nilesbolton.com

APPLICANT:

BILL SCHRADER T 925 638 8782

No.	Description	Date
2 3	PRELIM APP SB330	7/21/21
3	SD SET	9/16/21
4	USE PERMIT	10/25/21
5	USE PERMIT RESUBMIT.	12/10/21
6	SAP	12/22/21
8	USE PERMIT RESUBMIT.	3/17/22
9	SAP RESUBMIT.	3/23/22
11	USE PERMIT RESUBMIT.	3/28/22
12	APRIL DRC MEETING	4/11/22
13	JUNE LMRKS. MEETING	5/10/22
14	STAFF REVIEW	07/01/22
15	STAFF REVIEW #2	07/13/22
This d	rawing, as an instrument of service	e. is and


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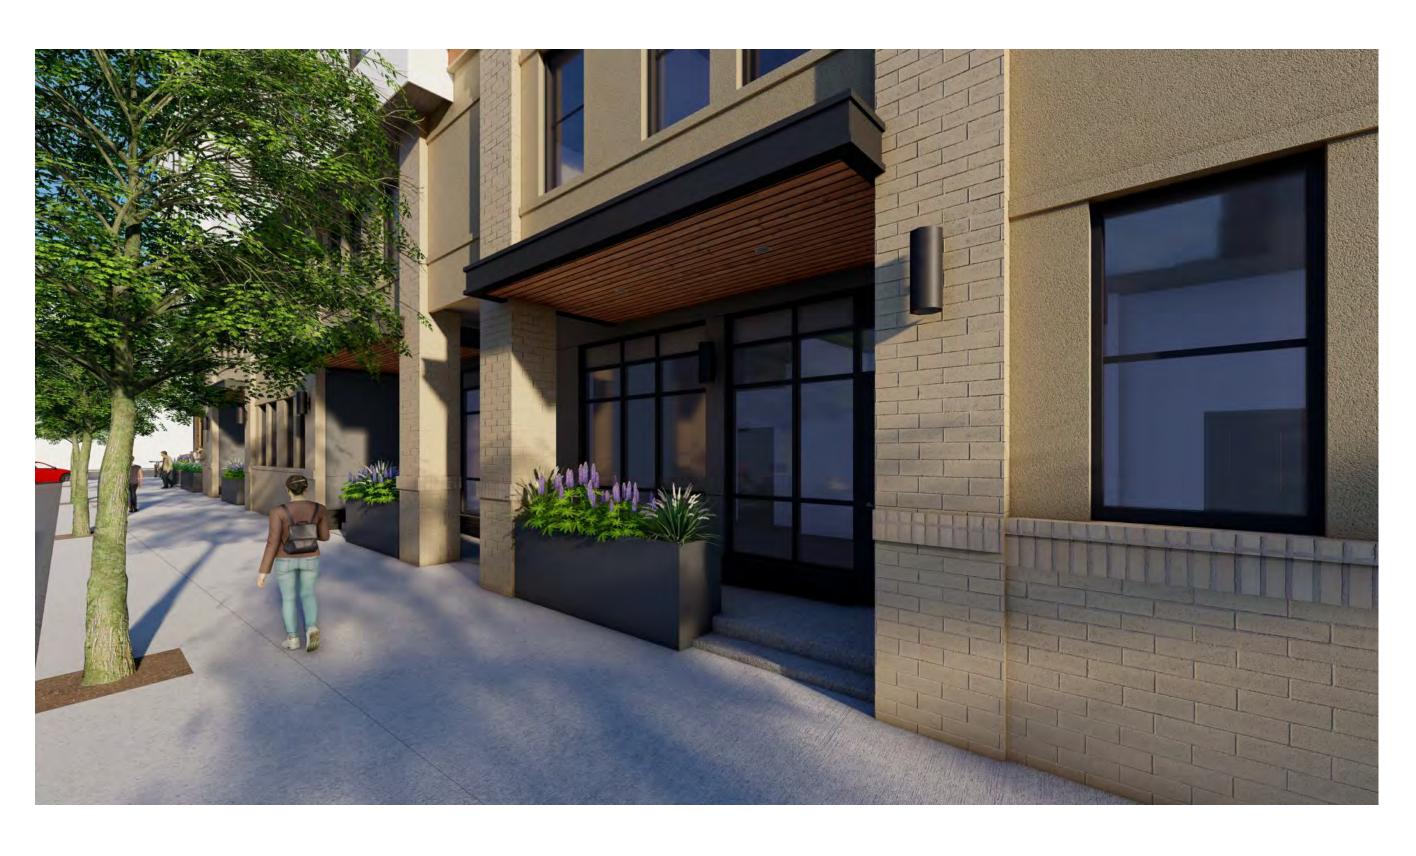
BERKELEY PLAZA 2065 KITTREDGE ST BERKELEY, CA 94704 CA VENTURES

SHEET TITLE:


PERSPECTIVES

SHEET NUMBER:



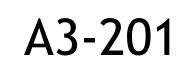

1 PERSPECTIVE - HAROLD WAY LIVE/WORK UNIT ENTRIES A3-202 NOT TO SCALE

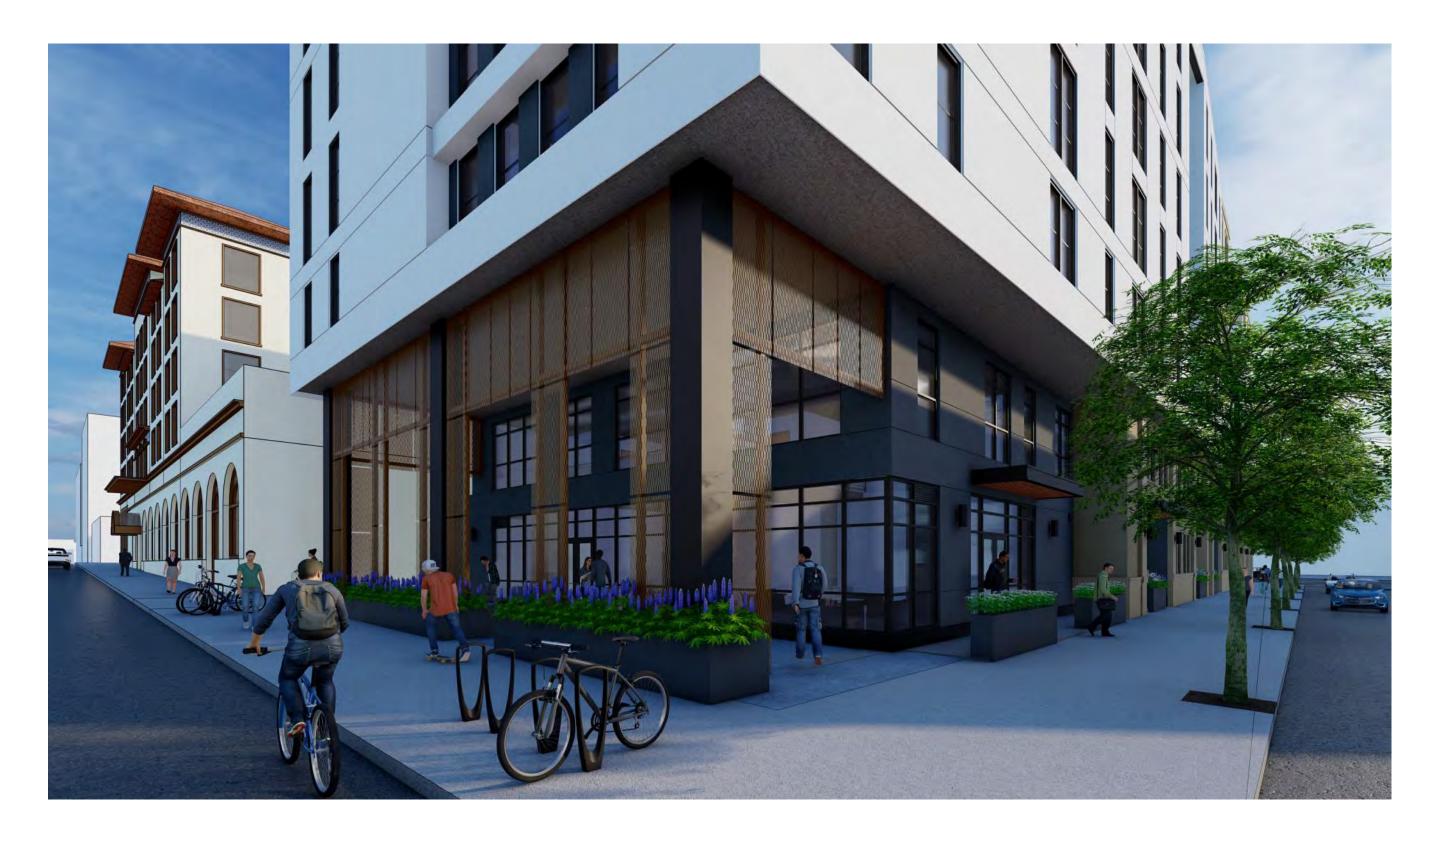

3 PERSPECTIVE - ALLSTON WAY AND HAROLD WAY RETAIL ENTRY A3-202 NOT TO SCALE






4 PERSPECTIVE - ALLSTON WAY AND HAROLD WAY CORNER A3-202 NOT TO SCALE

PROJECT # : 121246 DRAWN BY: TF, RK CHECKED BY: MM **NILES BOLTON** ASSOCIATES 3060 Peachtree Rd. N.W. Suite 600 Atlanta, GA 30305 T 404 365 7600 www.nilesbolton.com APPLICANT: BILL SCHRADER Т 925 638 8782 Description Date USE PERMIT RESUBMIT. 3/17/22 SAP RESUBMIT. 3/23/22 USE PERMIT RESUBMIT. 3/28/22 APRIL DRC MEETING 4/11/22 JUNE LMRKS. MEETING 5/10/22 This drawing, as an instrument of service, is and shall remain the property of the Architects and shall not be reproduced, published or used in any way without the permission of the Architect. BERKELEY PLAZA 2065 KITTREDGE ST BERKELEY, CA 94704 CA VENTURES SHEET TITLE: PERSPECTIVES SHEET NUMBER:

A3-202



JUNE 21 NOON

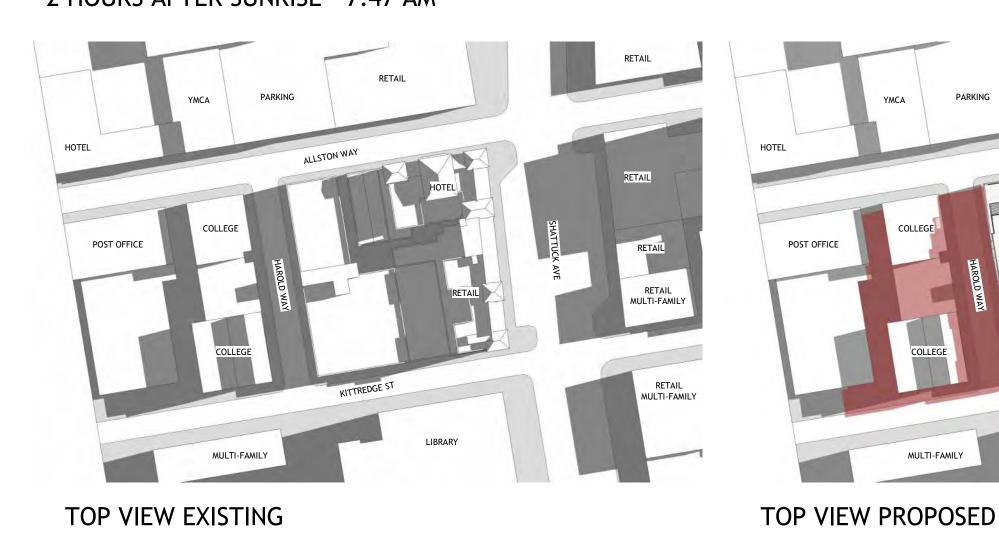


JUNE 21 MORNING

2 HOURS AFTER SUNRISE - 7:47 AM








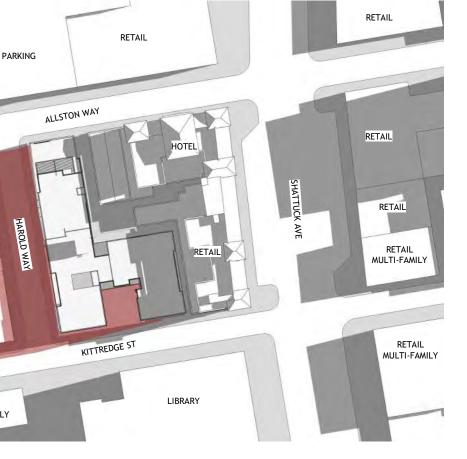




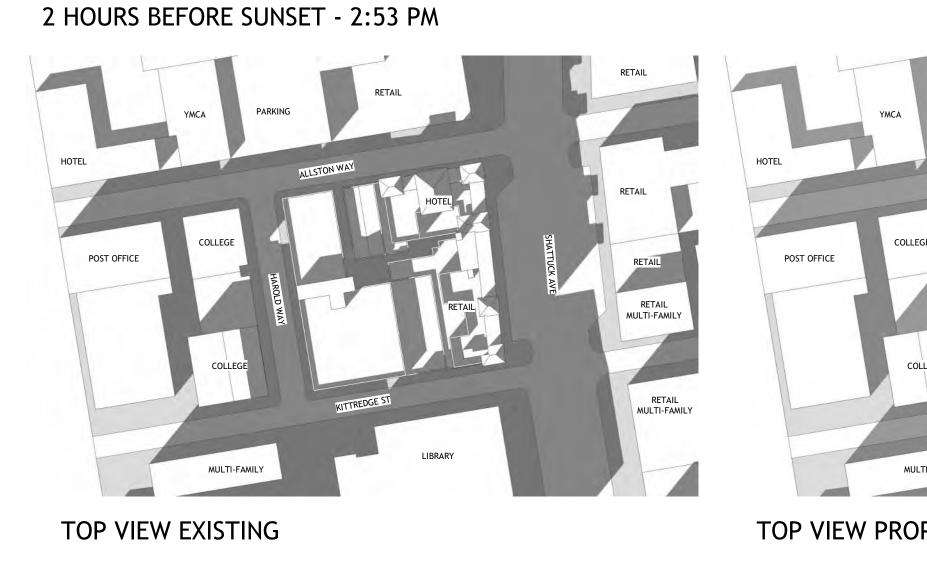

DECEMBER 21 EVENING

TOP VIEW EXISTING




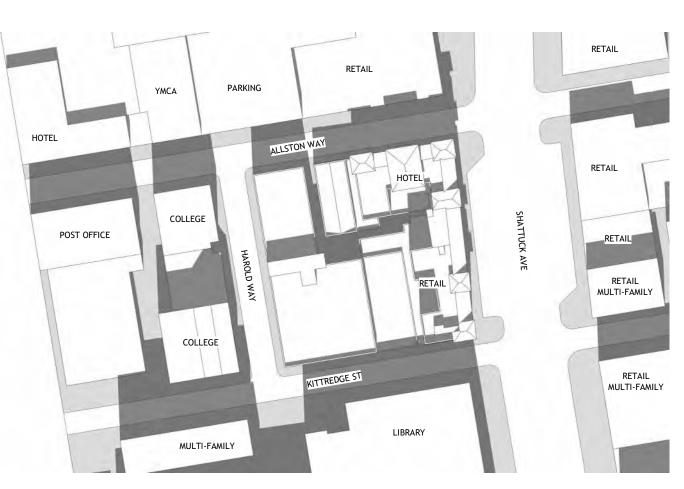



DECEMBER 21 NOON


HOTE POST OFFICE RETAIL ULTI-FAMILY RETAIL MULTI-FAMILY TOP VIEW EXISTING

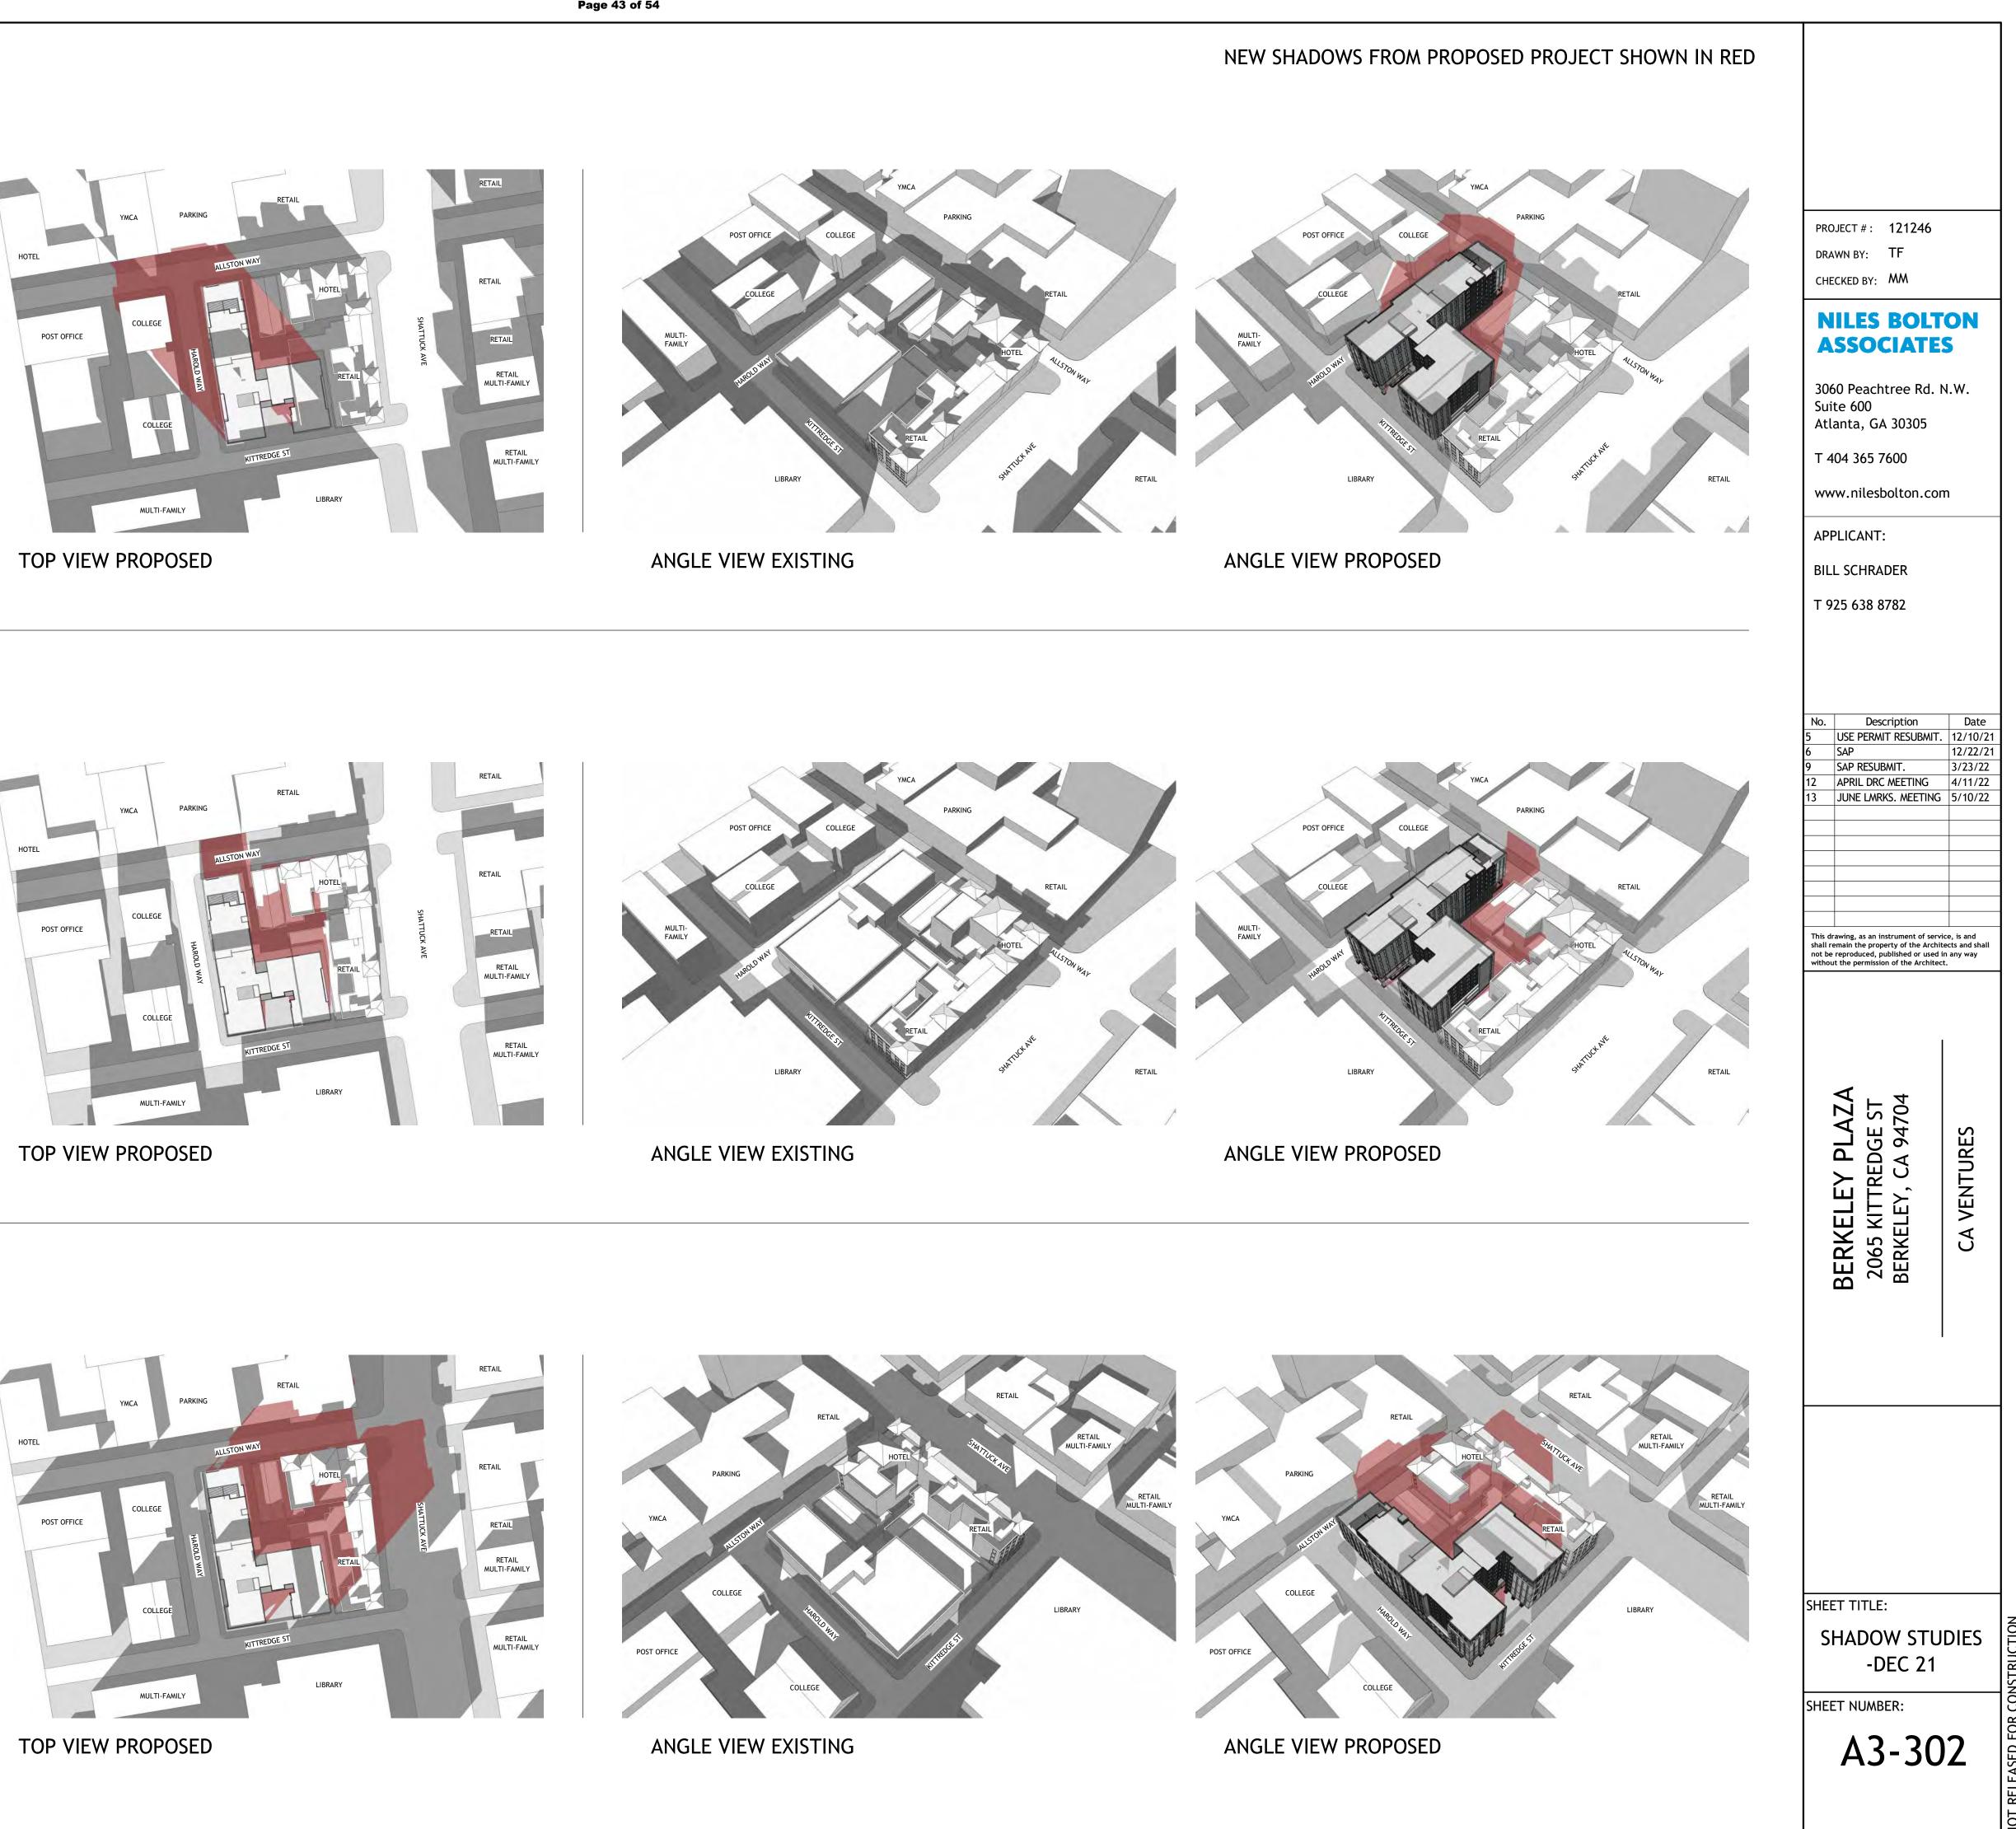

DECEMBER 21 MORNING


2 HOURS AFTER SUNRISE - 9:21 AM



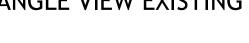






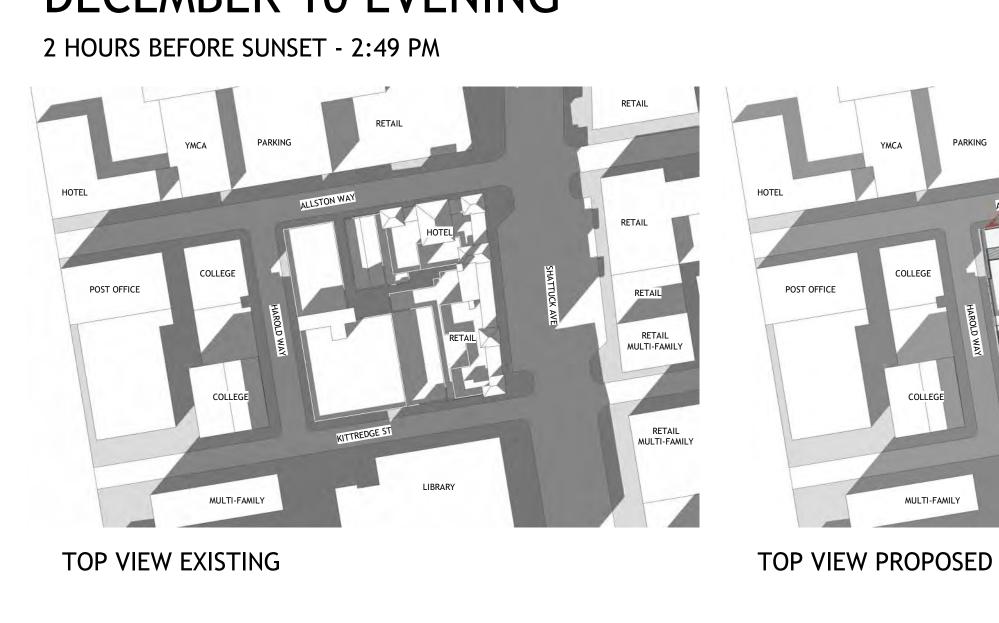

DECEMBER 10 EVENING

TOP VIEW EXISTING


POST OFFICE

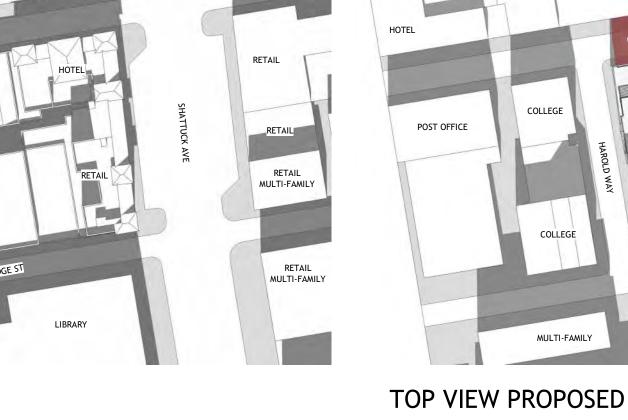

DECEMBER 10 NOON


TOP VIEW PROPOSED

POST OFFICE

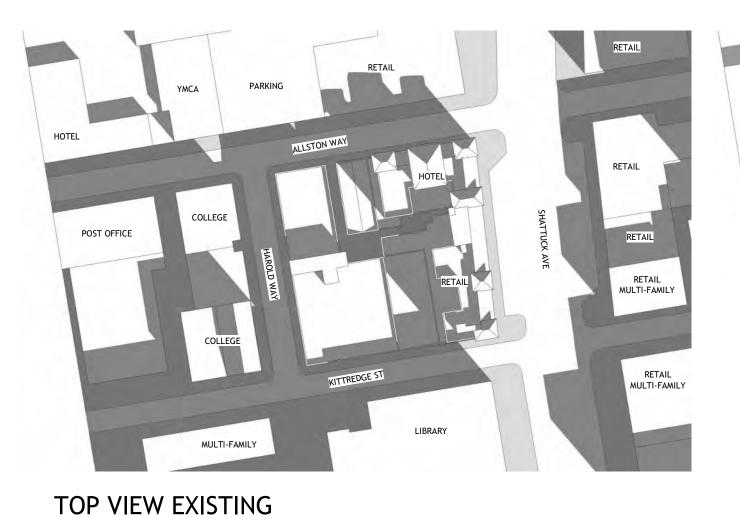

DECEMBER 10 MORNING

2 HOURS AFTER SUNRISE - 9:14 AM

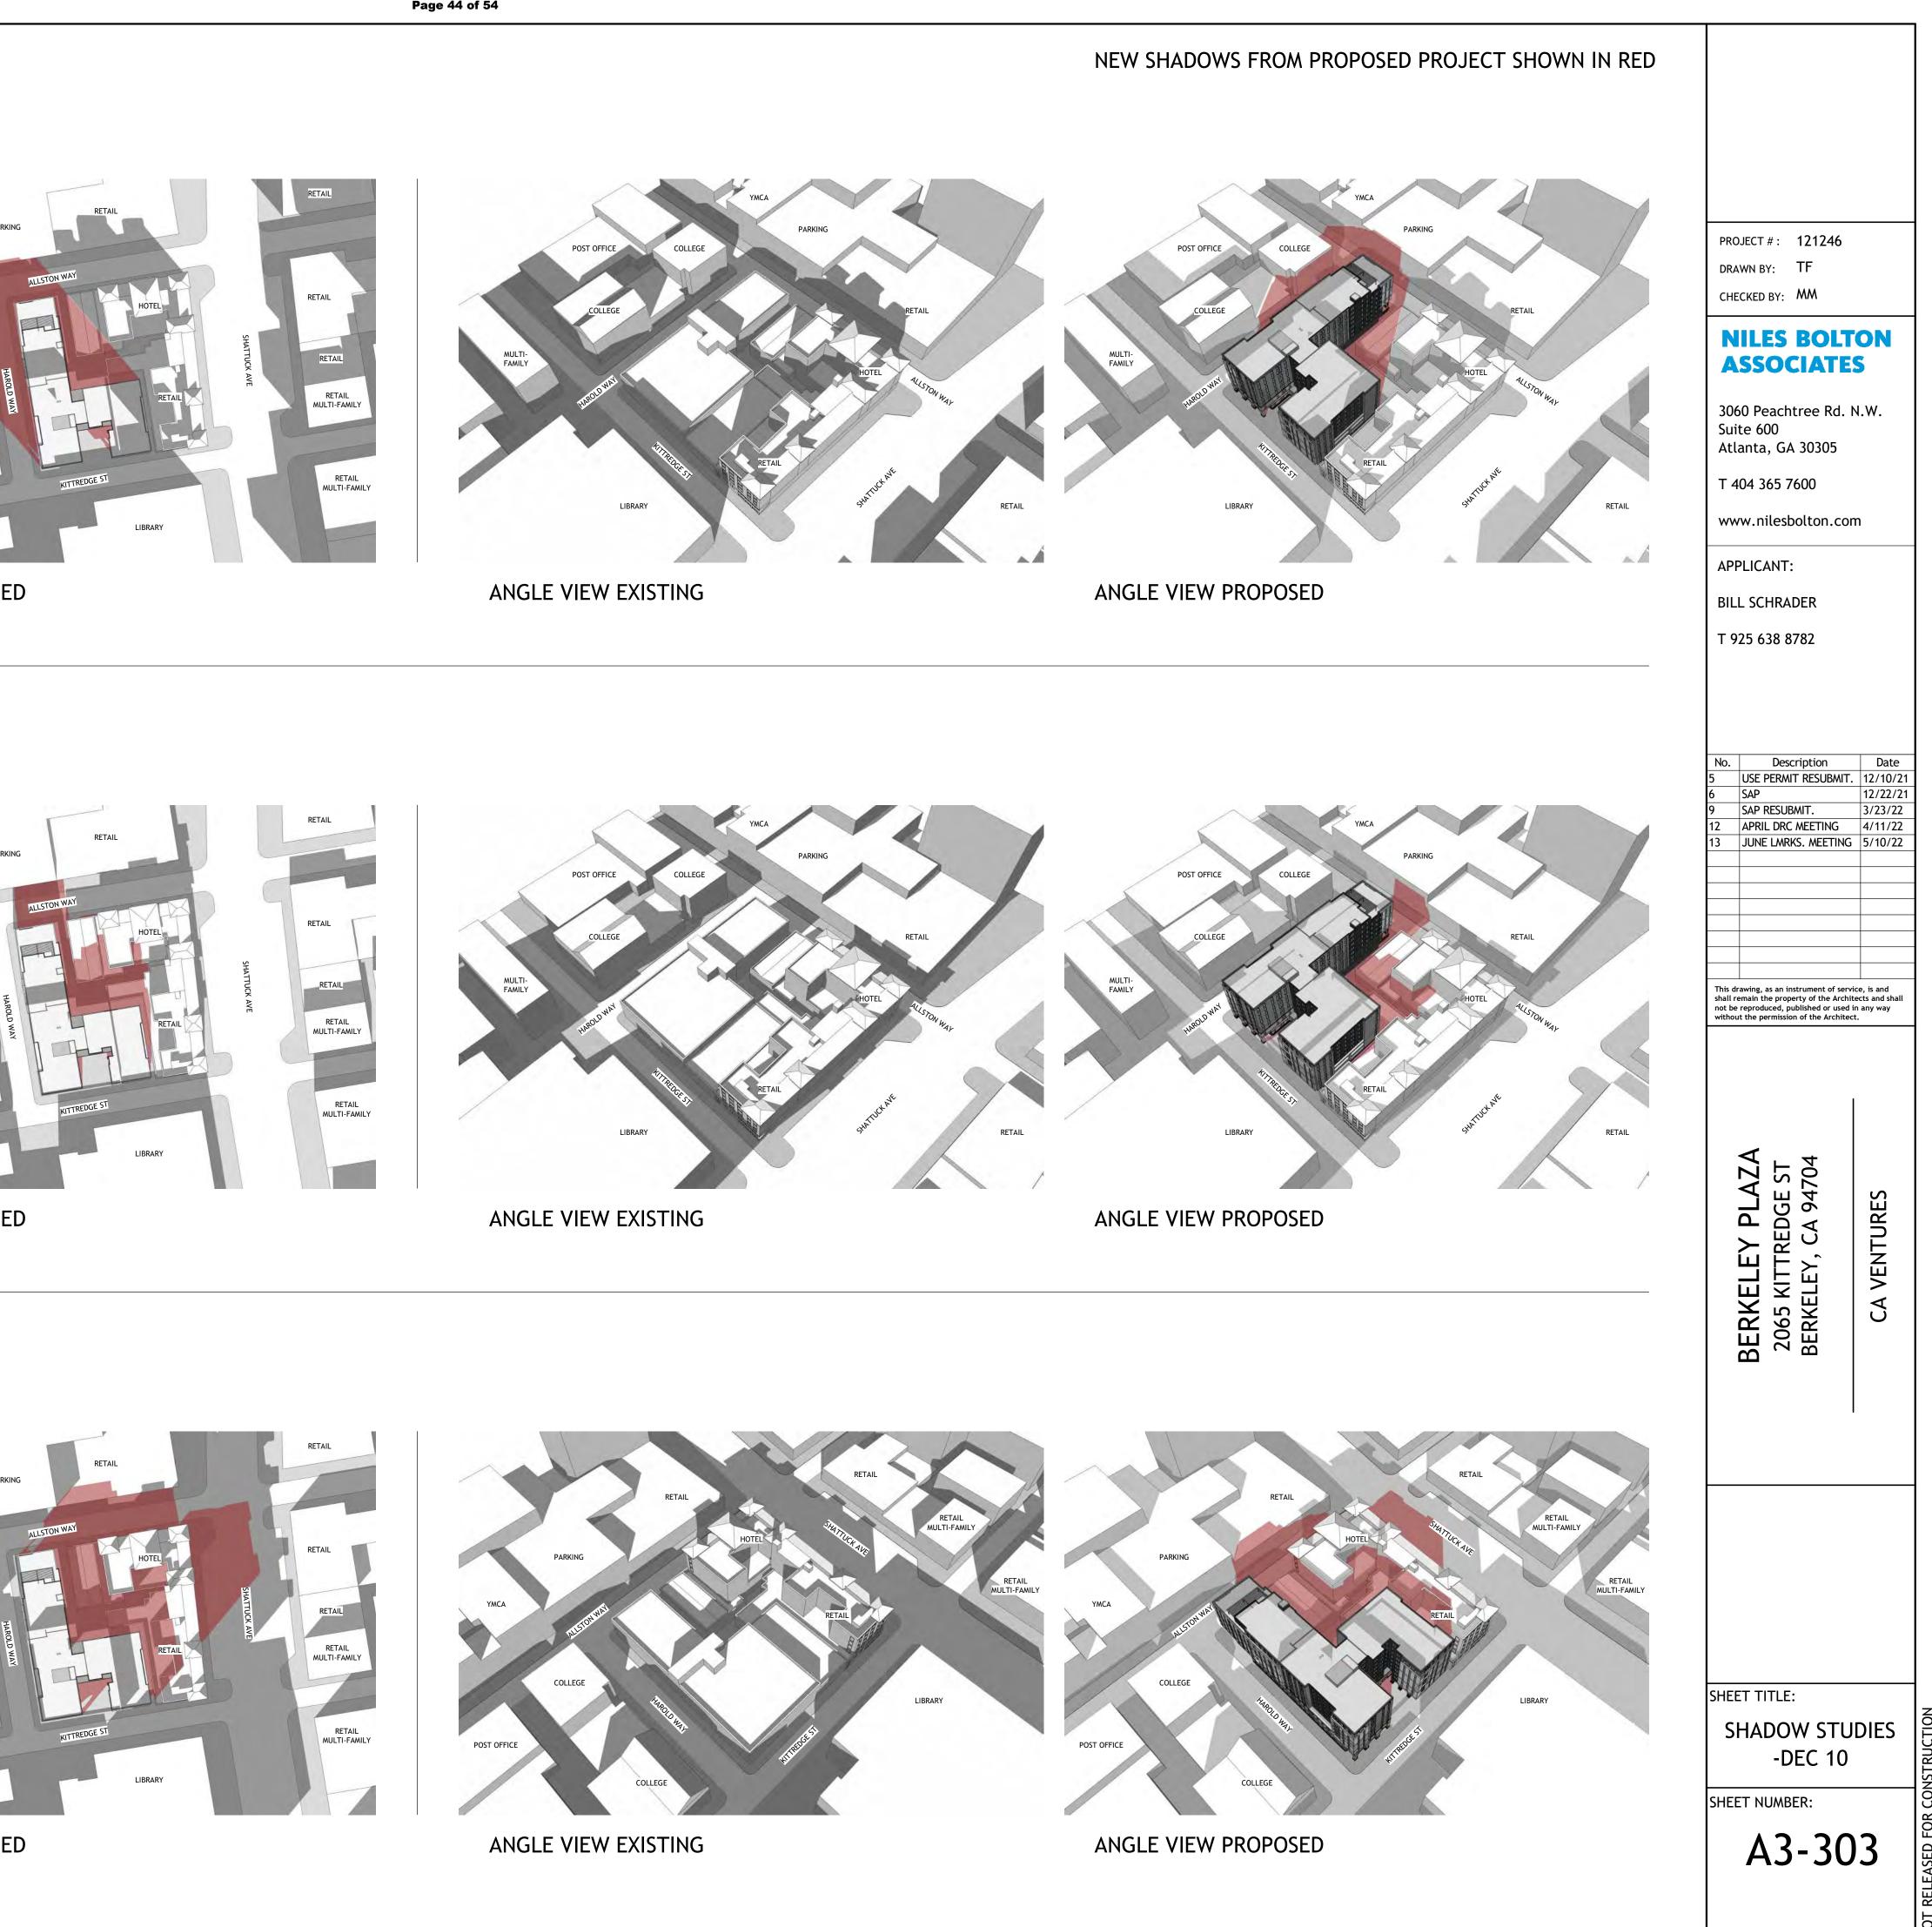












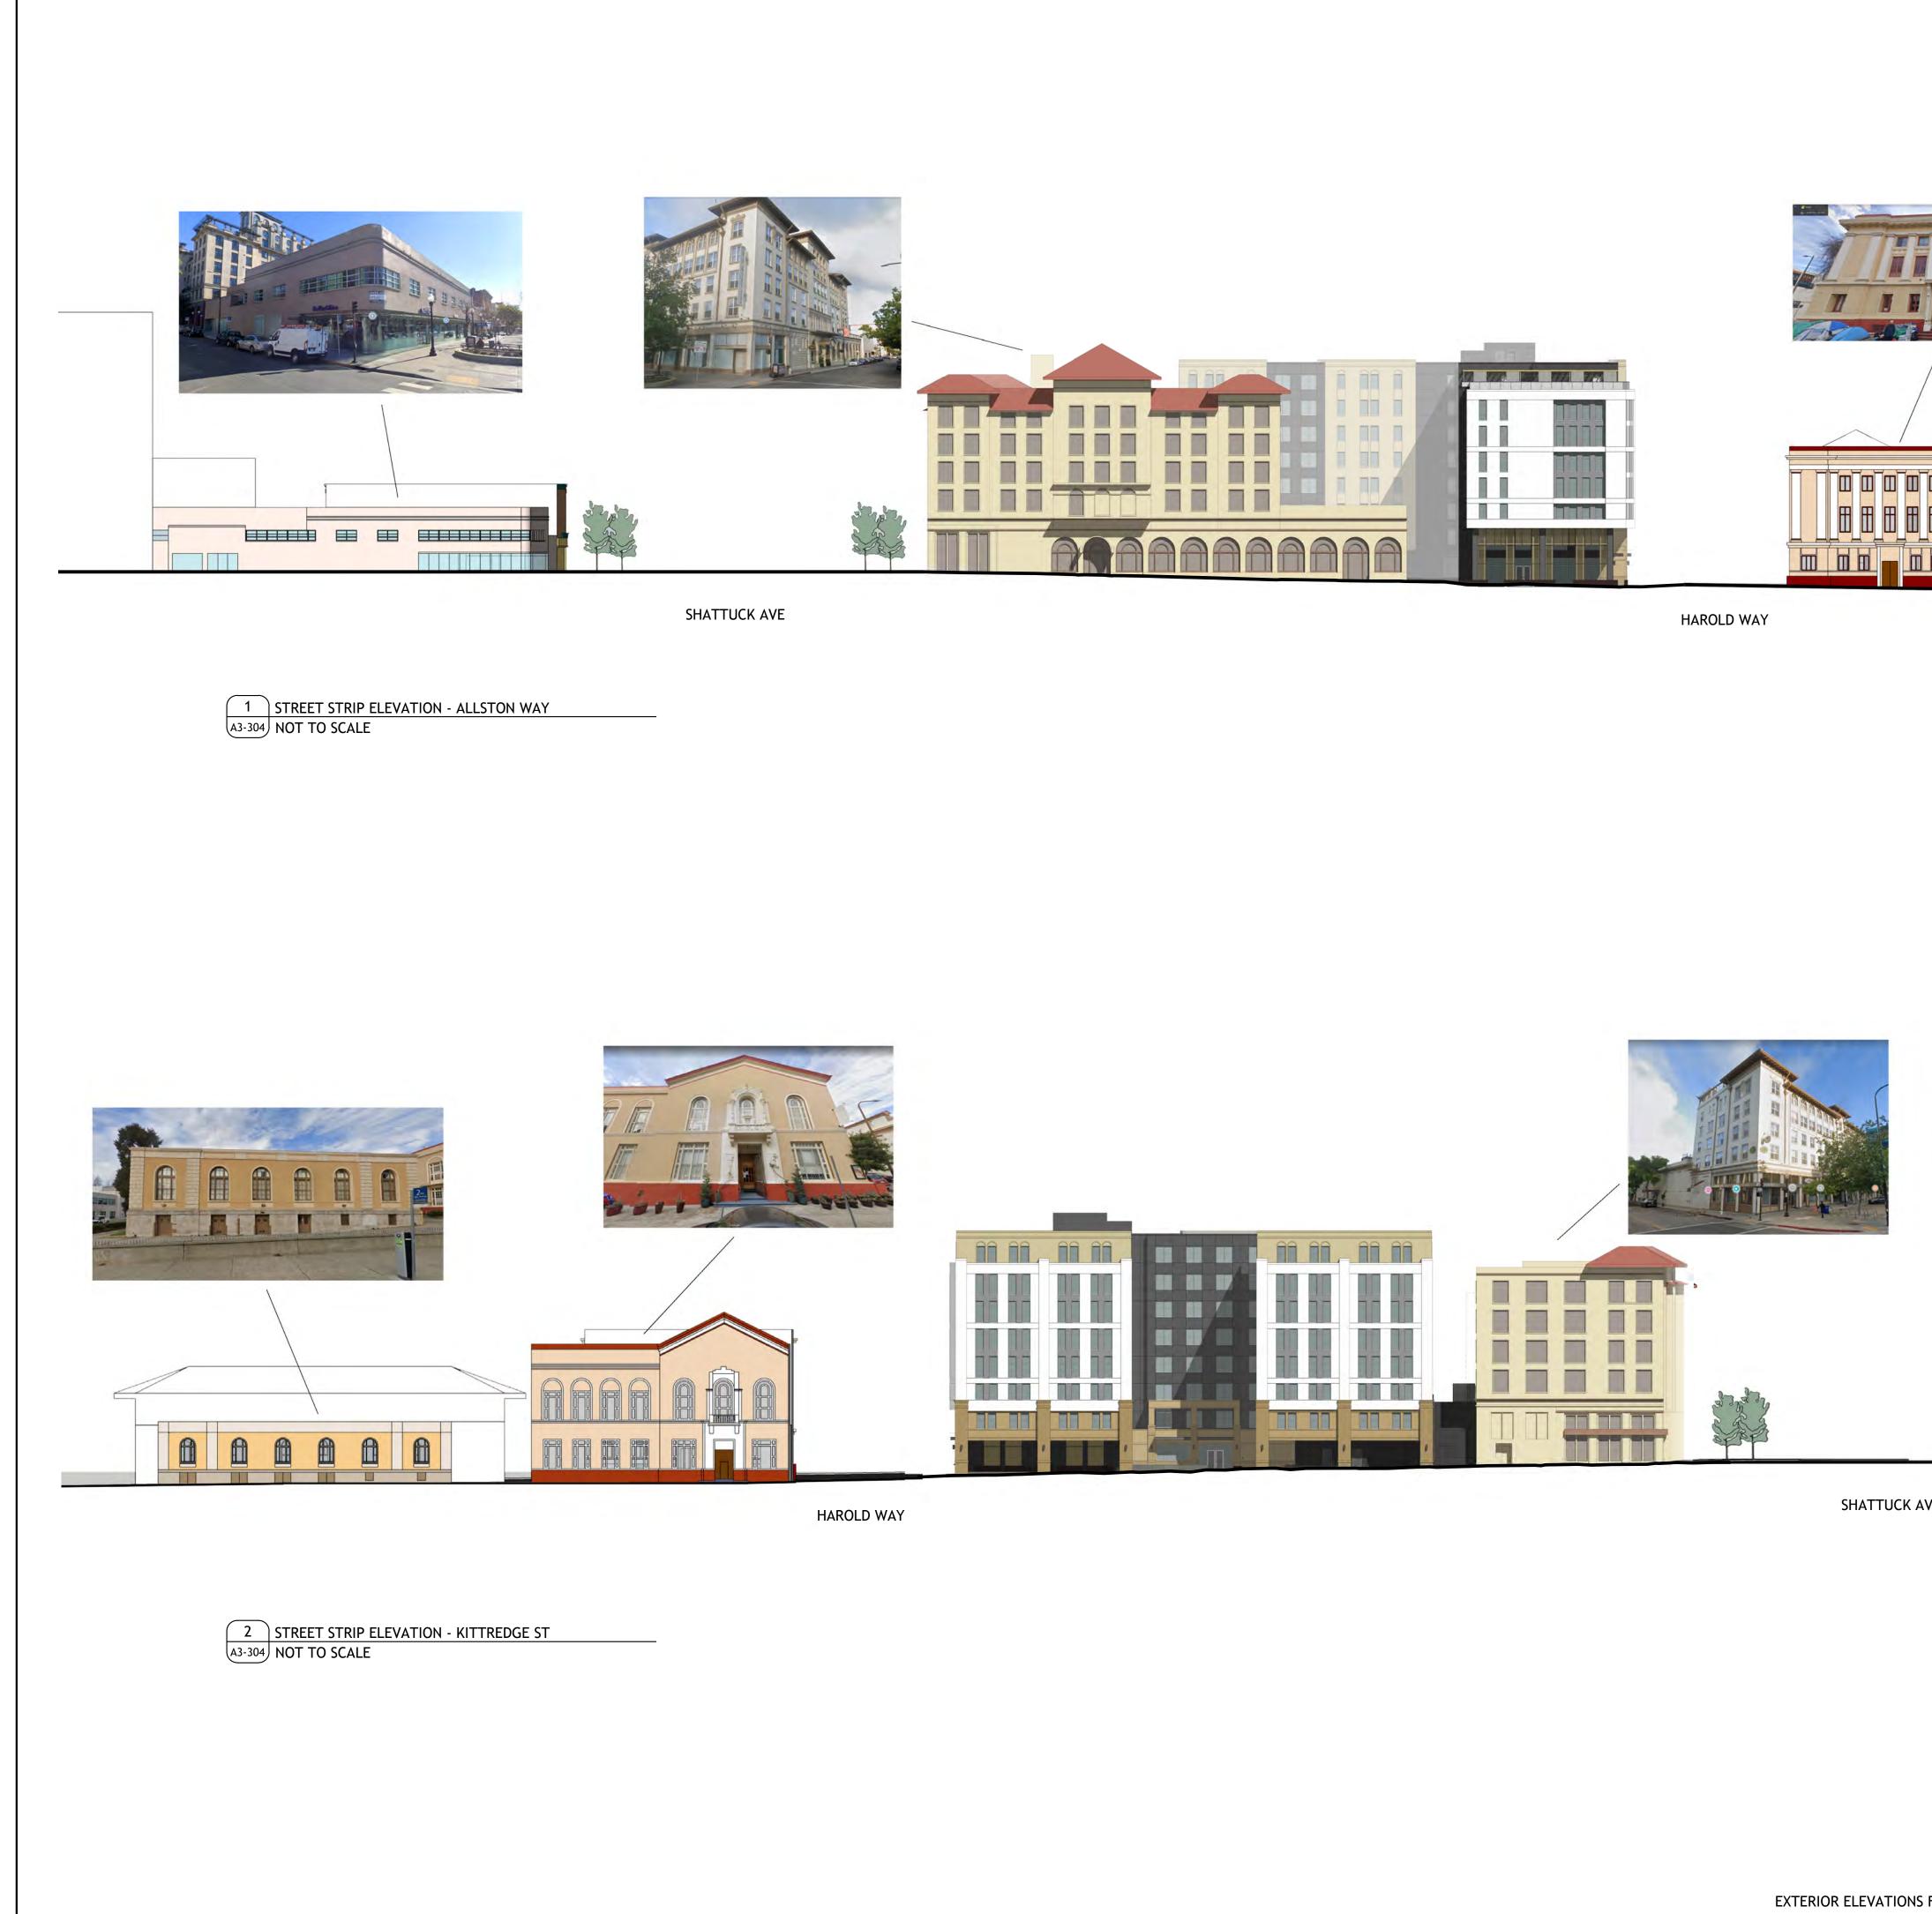

	PROJECT #: 121246 DRAWN BY: TF, RK CHECKED BY: MM NILES BOLTON ASSOCCIATES 3060 Peachtree Rd. N.W. Suite 600 Atlanta, GA 30305 T 404 365 7600 WWW.nilesbolton.com APPLICANT: BILL SCHRADER T 925 638 8782
	No. Description Date 4 USE PERMIT 10/25/21 5 USE PERMIT RESUBMIT. 12/10/21 6 SAP 12/22/21 9 SAP RESUBMIT. 3/23/22 13 JUNE LMRKS. MEETING 5/10/22 14 LMRKS. MEETING 5/10/22 15 USE PERMIT 3/23/22 13 JUNE LMRKS. MEETING 5/10/22 14 LMRKS. MEETING 5/10/22 15 USE PERMIT of service, is and shall remain the property of the Architect. Song RILIERDGE SI 7000000 Perpoduced, published or used in any way without the permission of the Architect. Song RILIENCE VERNINES VERNINES VERNINES VERNINES Song RILIENCE VERNINES VERNINES VERNINES VERNINES VERNINES VERNINES VERNINES VERNINES VERNINES VERNINES
AVE IS FOR GENERAL REFERENCE ONLY. PLEASE REFER TO ENLARGED ELEVATIONS FOR PROPOSED DESIGN	SHEET TITLE: STREET STRIP ELEVATIONS SHEET NUMBER: A3-304



E1 - TAN STUCCO




E2 - CHARCOAL GREY STUCCO



E7 - ALUMINUM CANOPY





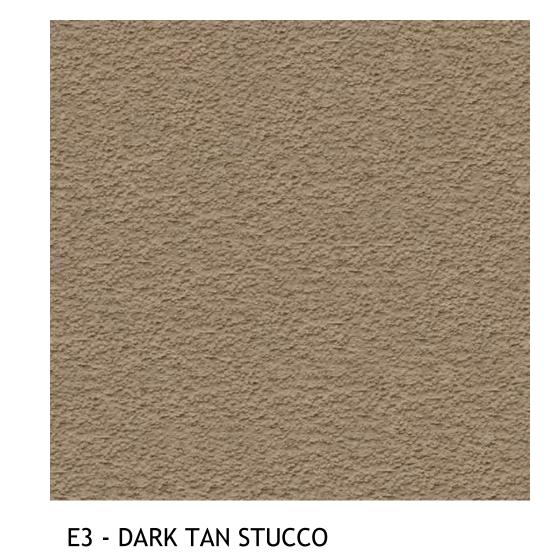









E8 - EXTERIOR WALL SCONCE

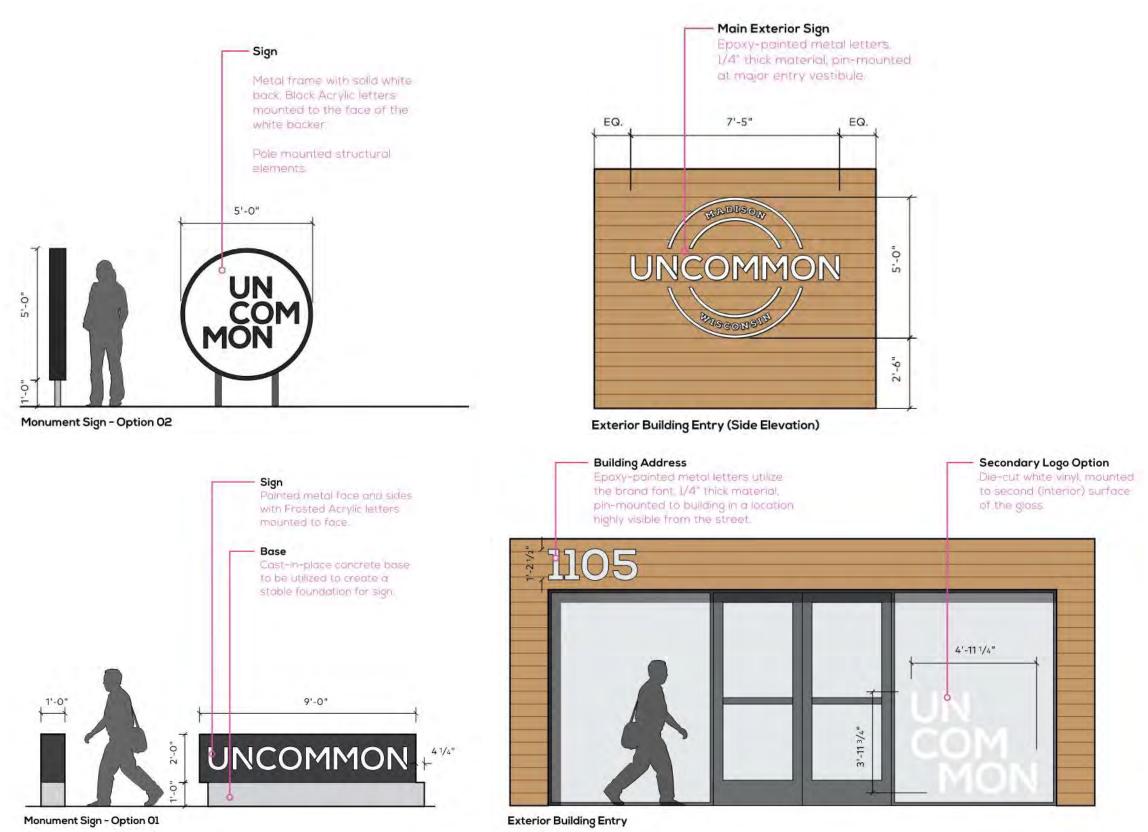

E9 - SIGNAGE




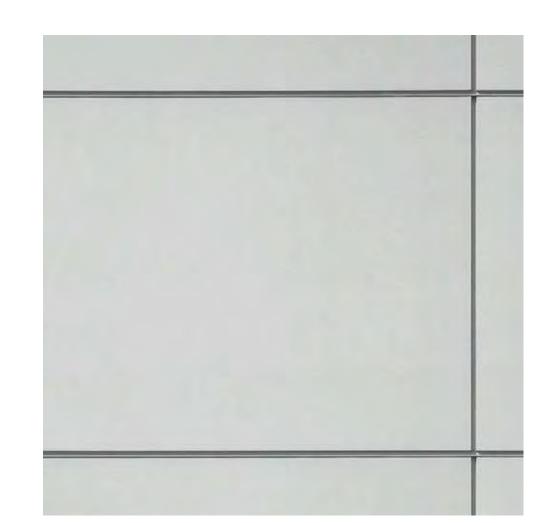



E5 - WHITE FIBER CEMENT

DRAWN BY: TF, RI CHECKED BY: MM NILES BOI ASSOCIAT 3060 Peachtree R Suite 600 Atlanta, GA 30305 T 404 365 7600 WWW.nilesbolton. APPLICANT: BILL SCHRADER T 925 638 8782	LTON ES d. n.w.
No. Description 6 SAP 9 SAP RESUBMIT. 11 USE PERMIT RESUB 12 APRIL DRC MEETING 13 JUNE LMRKS. MEET 1 Image: Second Se	G 4/11/22 ING 5/10/22
BERKELEY PLAZA 2065 KITTREDGE ST BERKELEY, CA 94704	CA VENTURES
SHEET TITLE: MATERIAL B SHEET NUMBER:	OARDS


RELEASED FOR CONSTRUCTION 01

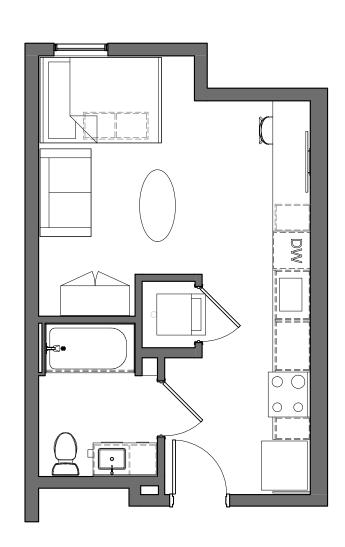


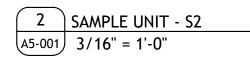


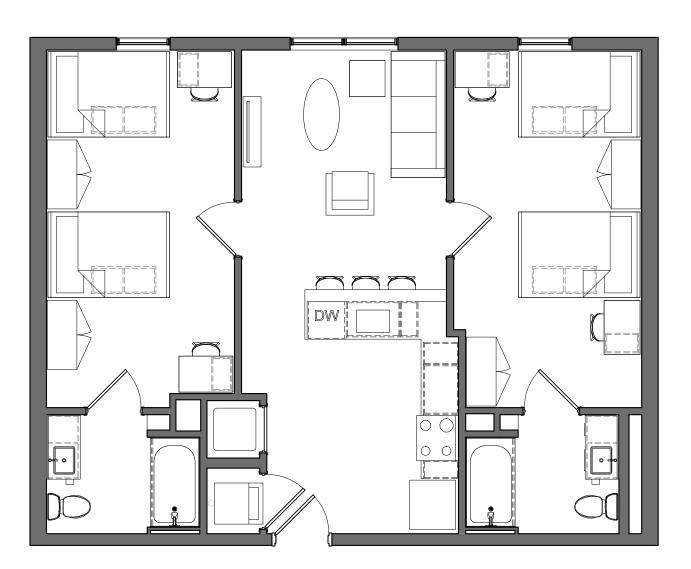



1 SAMPLE UNIT - B1 A5-001 3/16" = 1'-0"

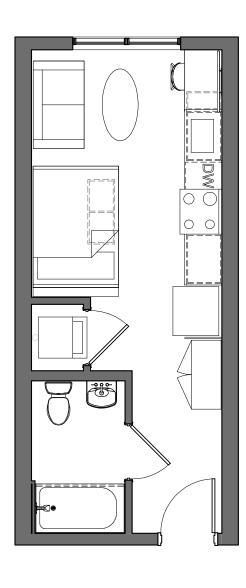


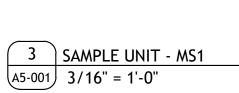


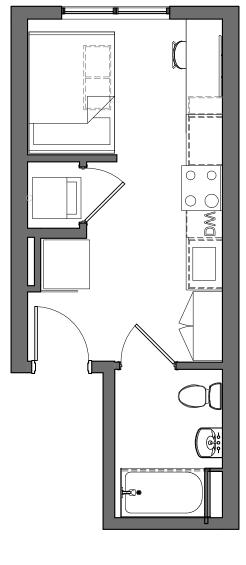

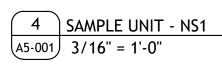


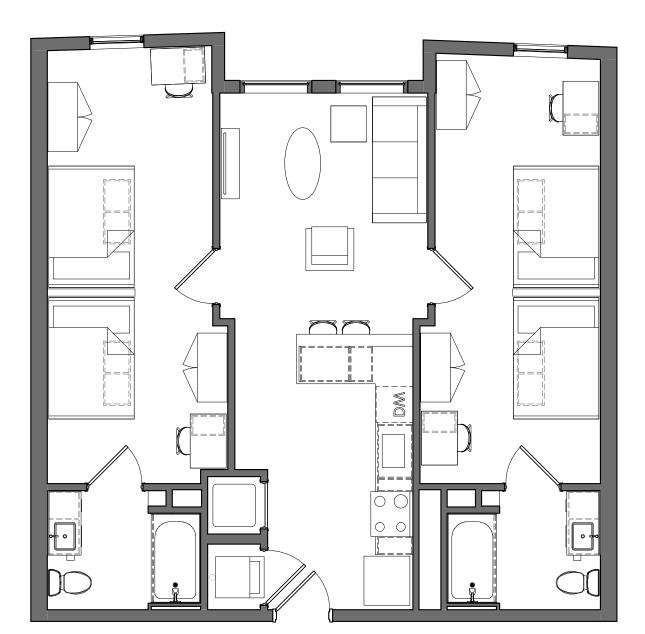


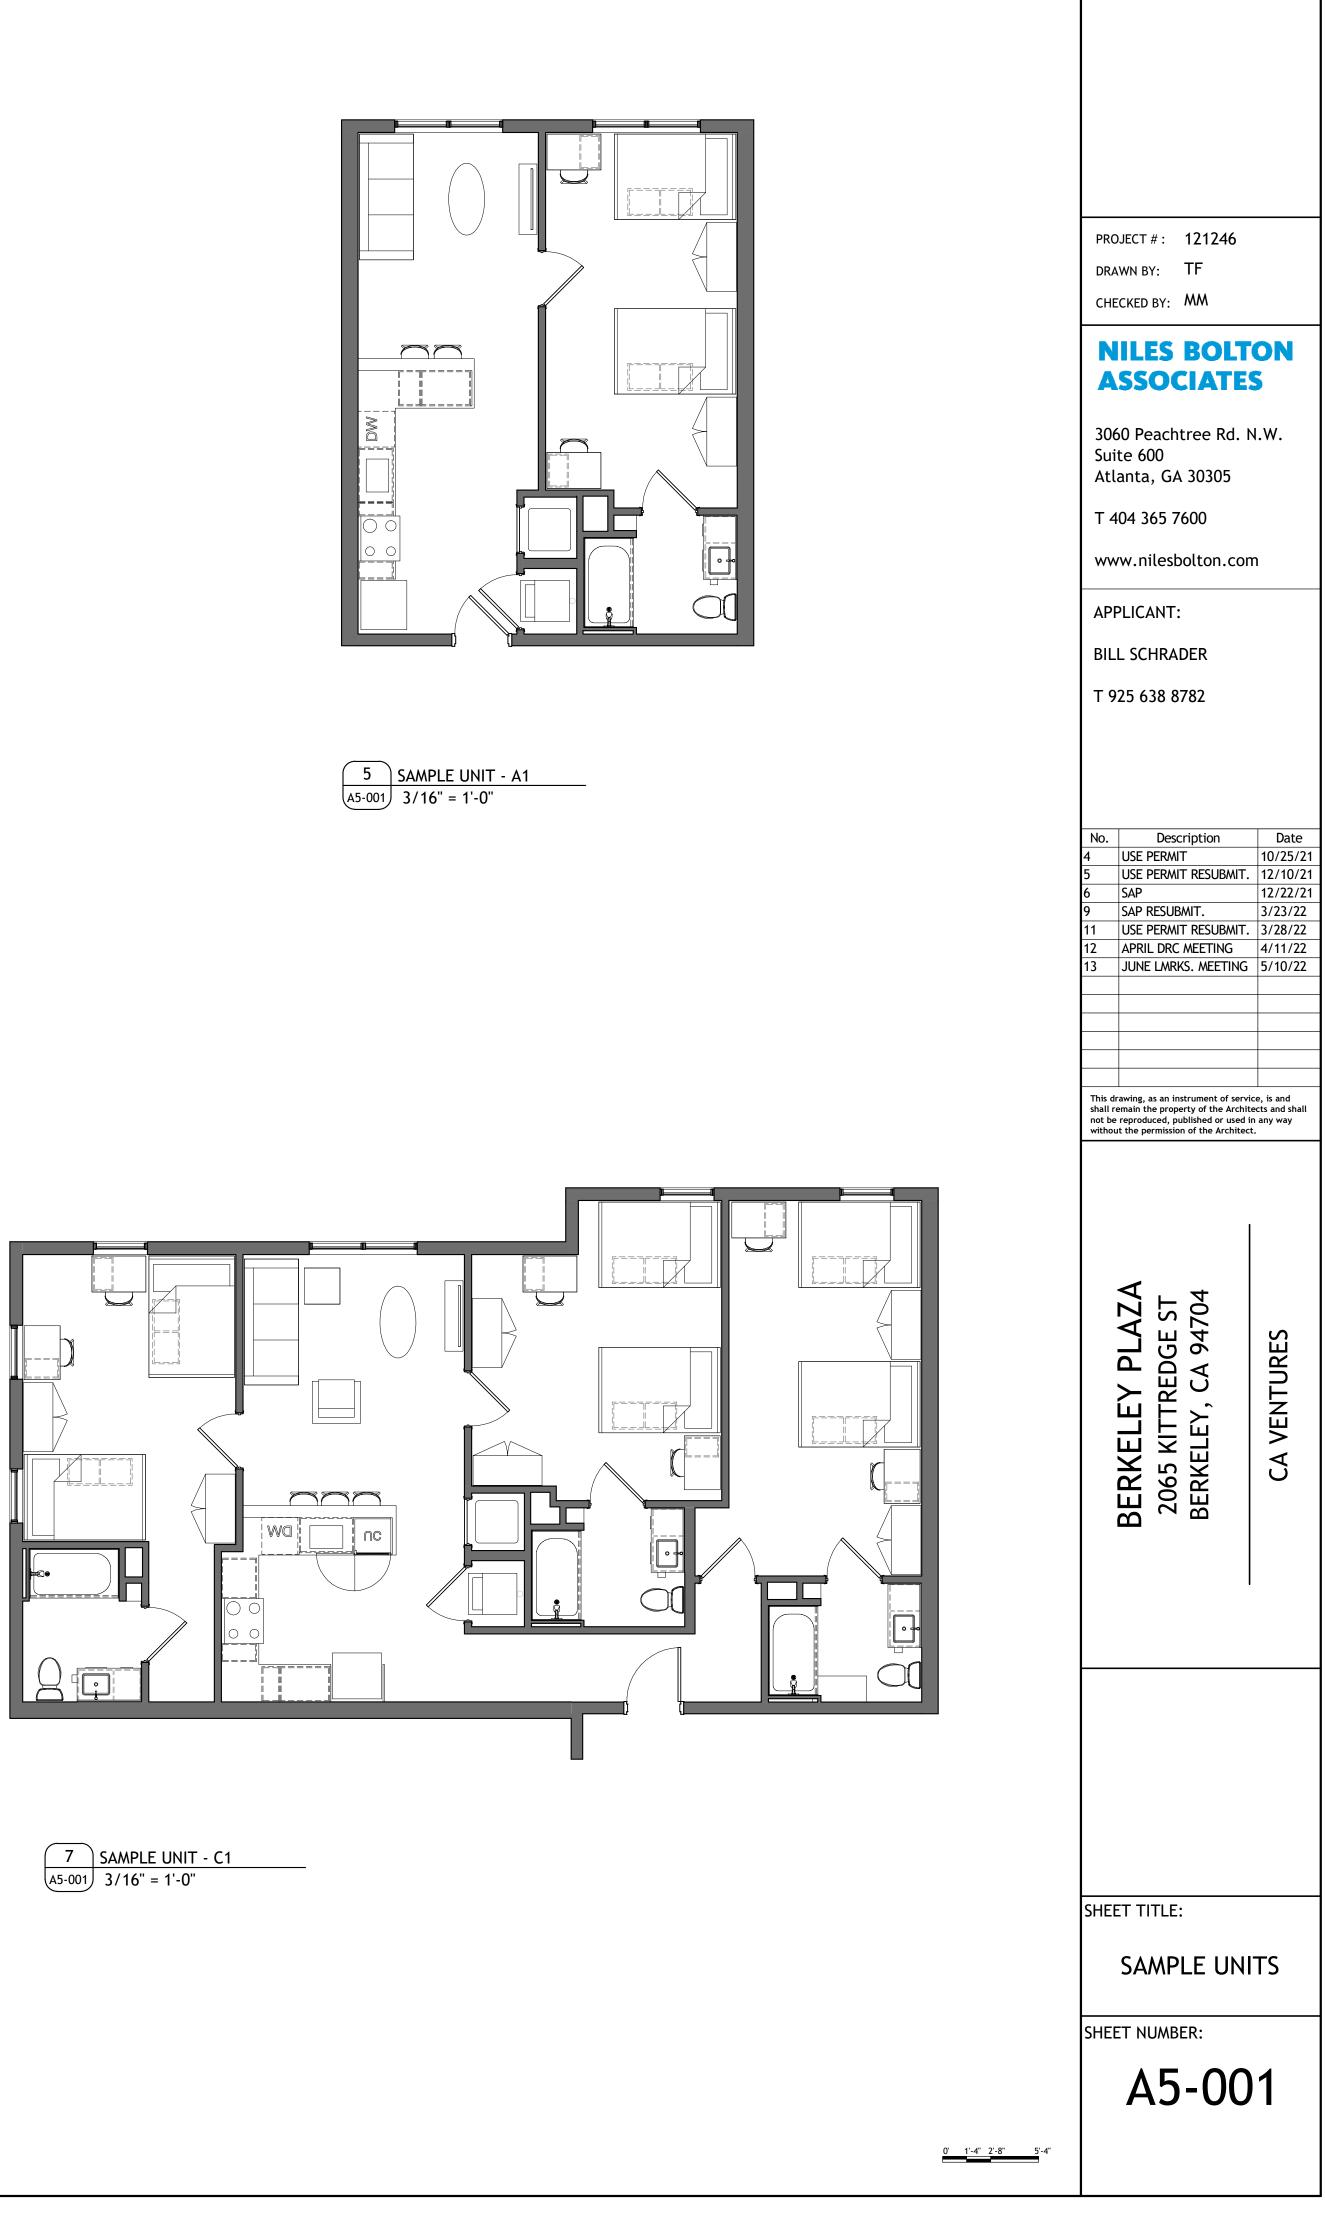

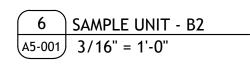


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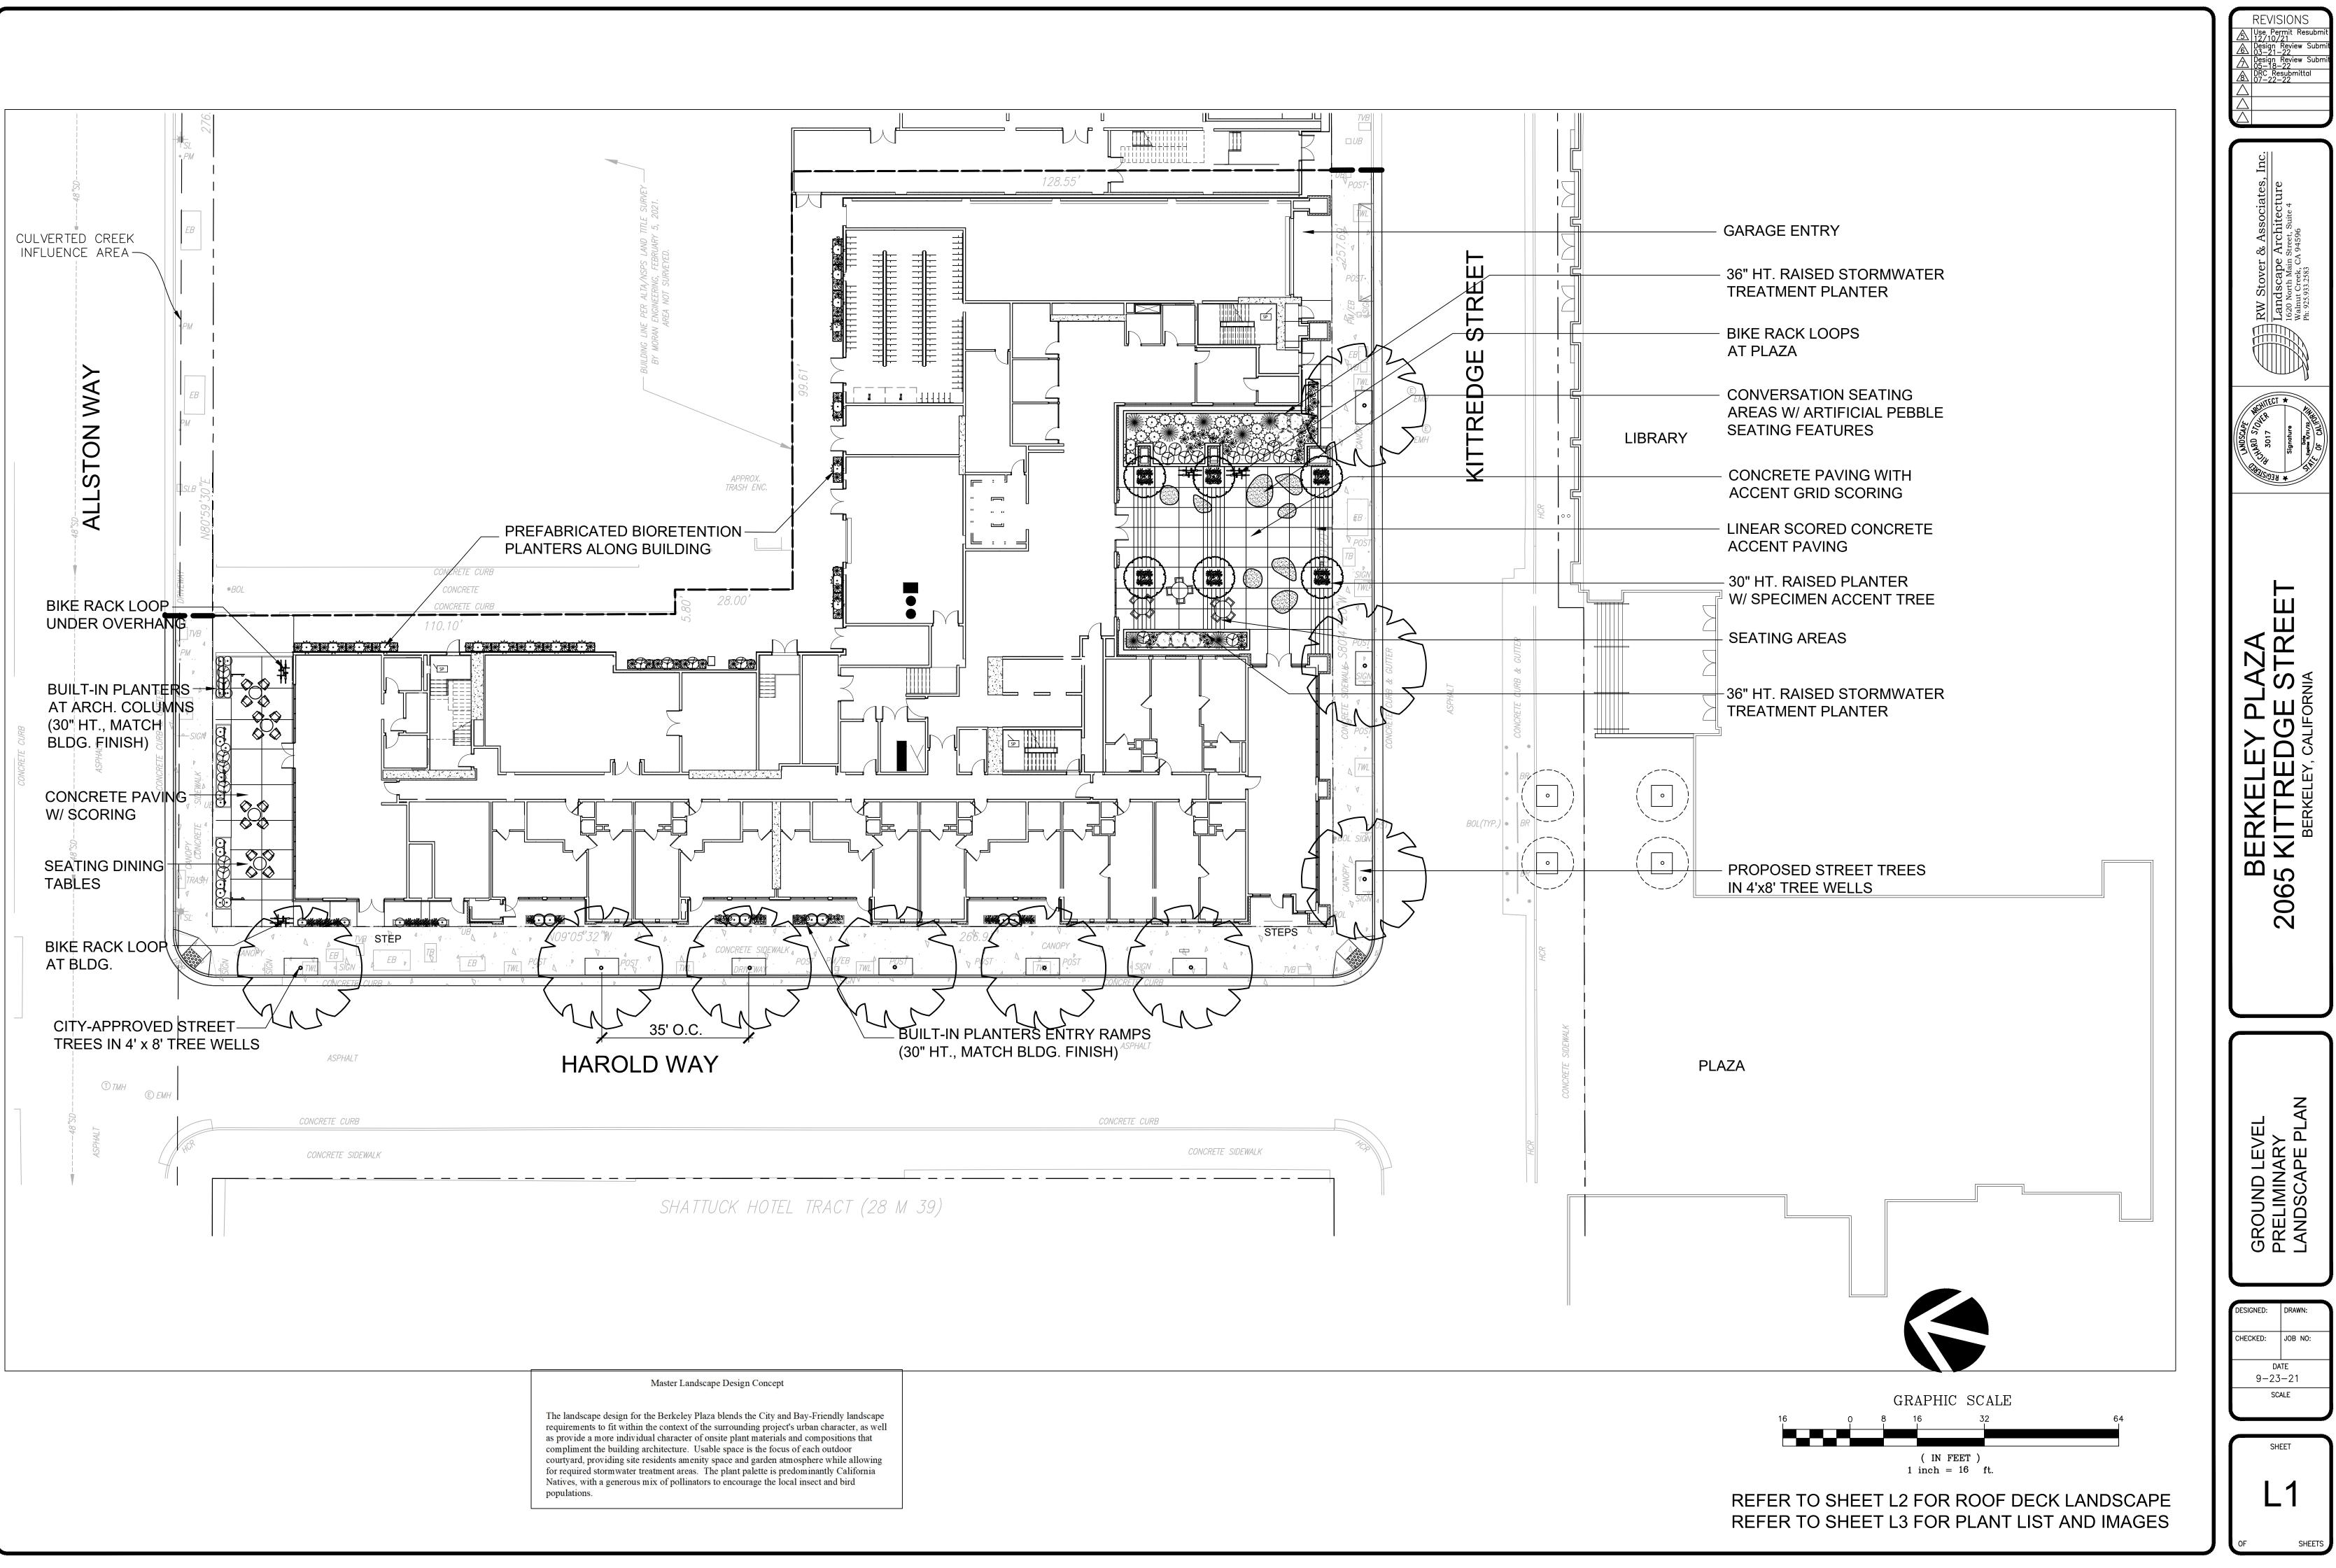


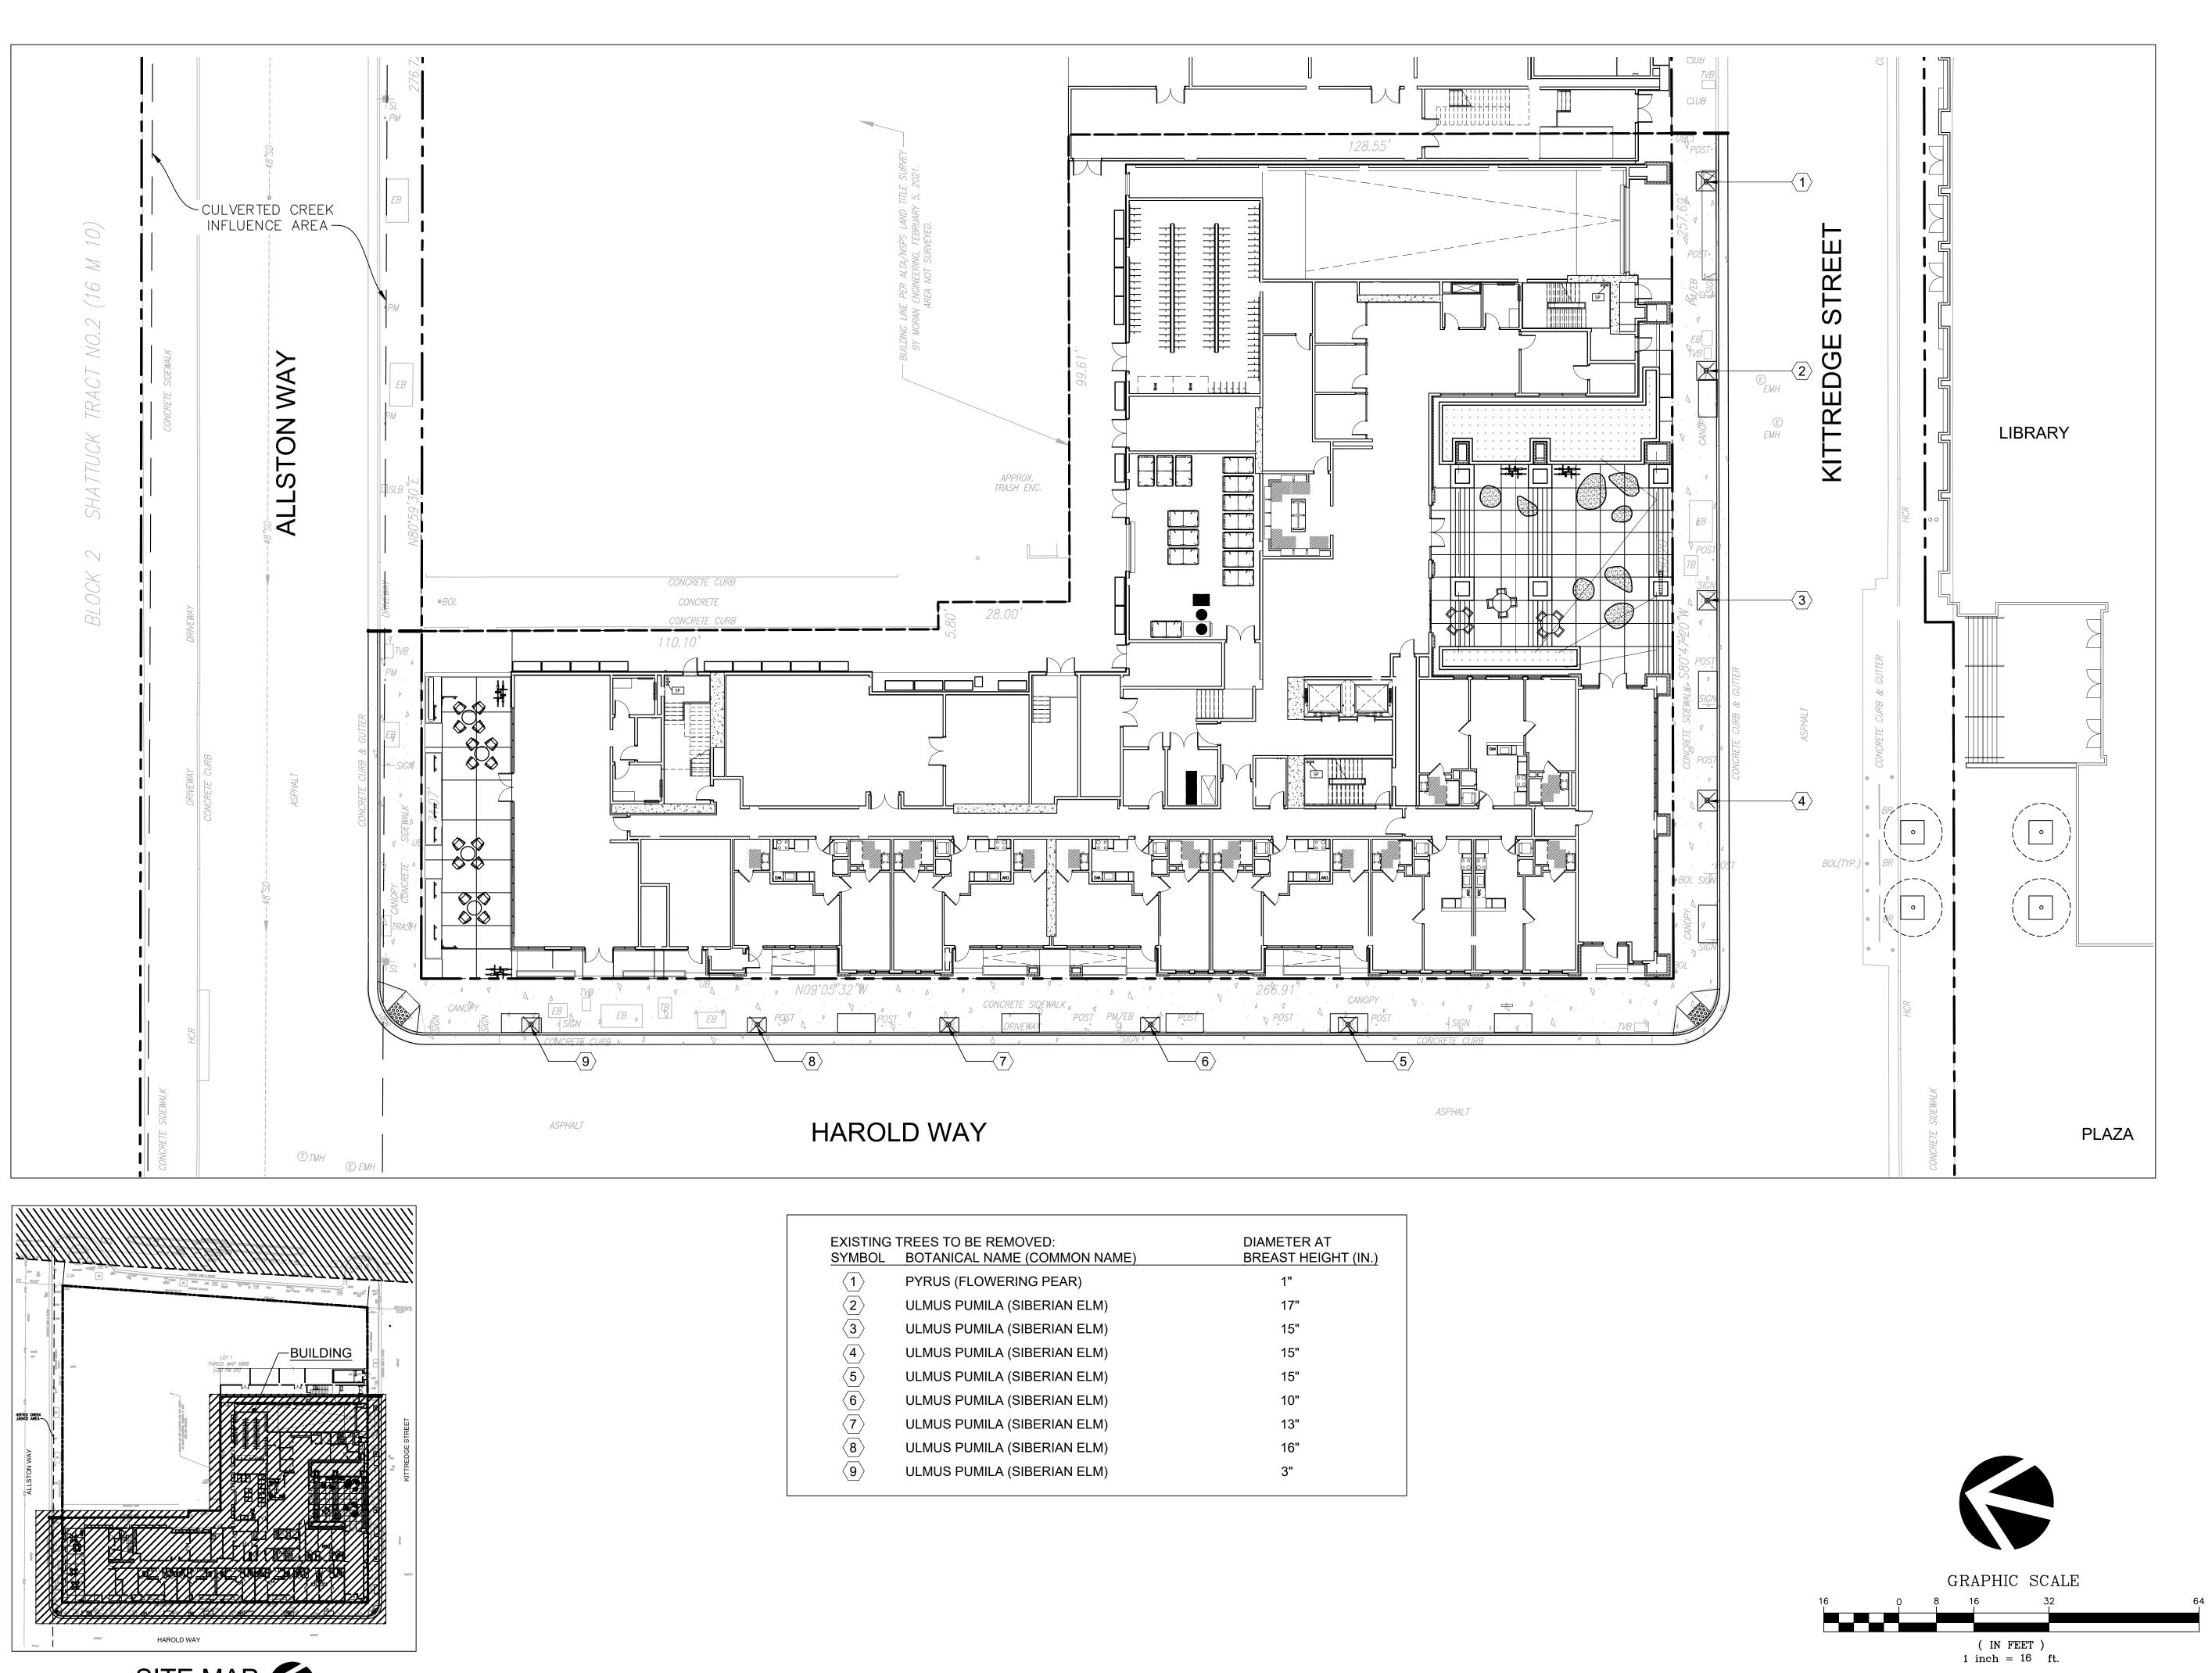

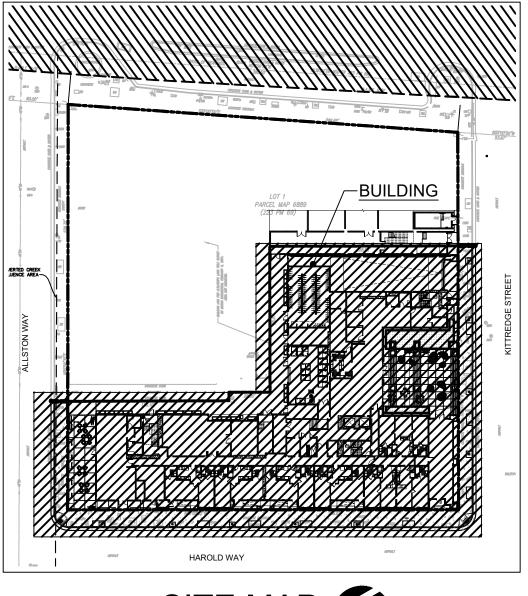


EXISTING SYMBOL	TREES TO BE REMOVED: BOTANICAL NAME (COMMON NAME)	DIAMETER AT BREAST HEIGHT (IN.)
$\langle 1 \rangle$	PYRUS (FLOWERING PEAR)	1"
2	ULMUS PUMILA (SIBERIAN ELM)	17"
$\langle 3 \rangle$	ULMUS PUMILA (SIBERIAN ELM)	15"
4	ULMUS PUMILA (SIBERIAN ELM)	15"
$\langle \overline{5} \rangle$	ULMUS PUMILA (SIBERIAN ELM)	15"
$\langle 6 \rangle$	ULMUS PUMILA (SIBERIAN ELM)	10"
$\langle 7 \rangle$	ULMUS PUMILA (SIBERIAN ELM)	13"
$\langle 8 \rangle$	ULMUS PUMILA (SIBERIAN ELM)	16"
(9)	ULMUS PUMILA (SIBERIAN ELM)	3"



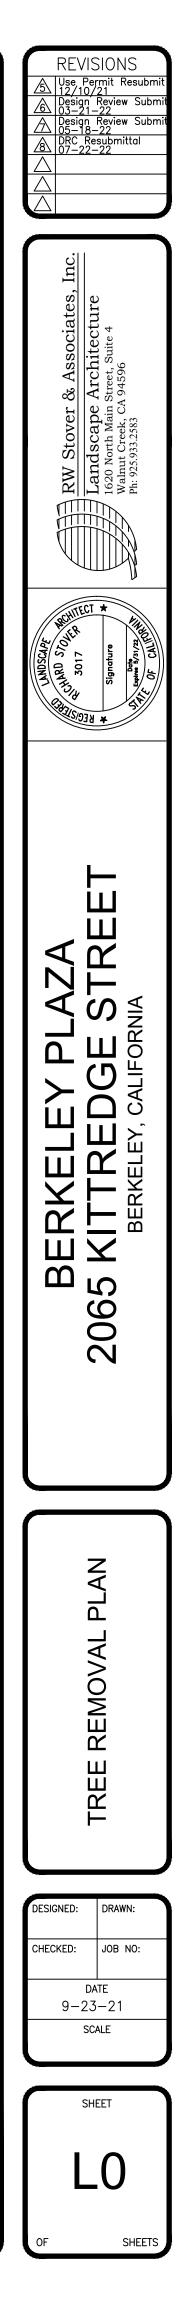




	:		
BUILT-IN COUNTER W/ - (2) PROPANE GRILLS			
ARCHITECTURAL OVER SHADE ARBOR	HEAD		
CONVERSATION AREAS			
36" HT. BUILT-IN RAISED STORMWATER TREATM			
PLANTER ALONG PERIM	H・ 5、切除		
		┨└ <u>┖┲╴╖═┨╢═┨</u> ┼┦╙└	
		и └────────────────────────────────────	
24" SQ. PAVERS ON PEDESTALS			

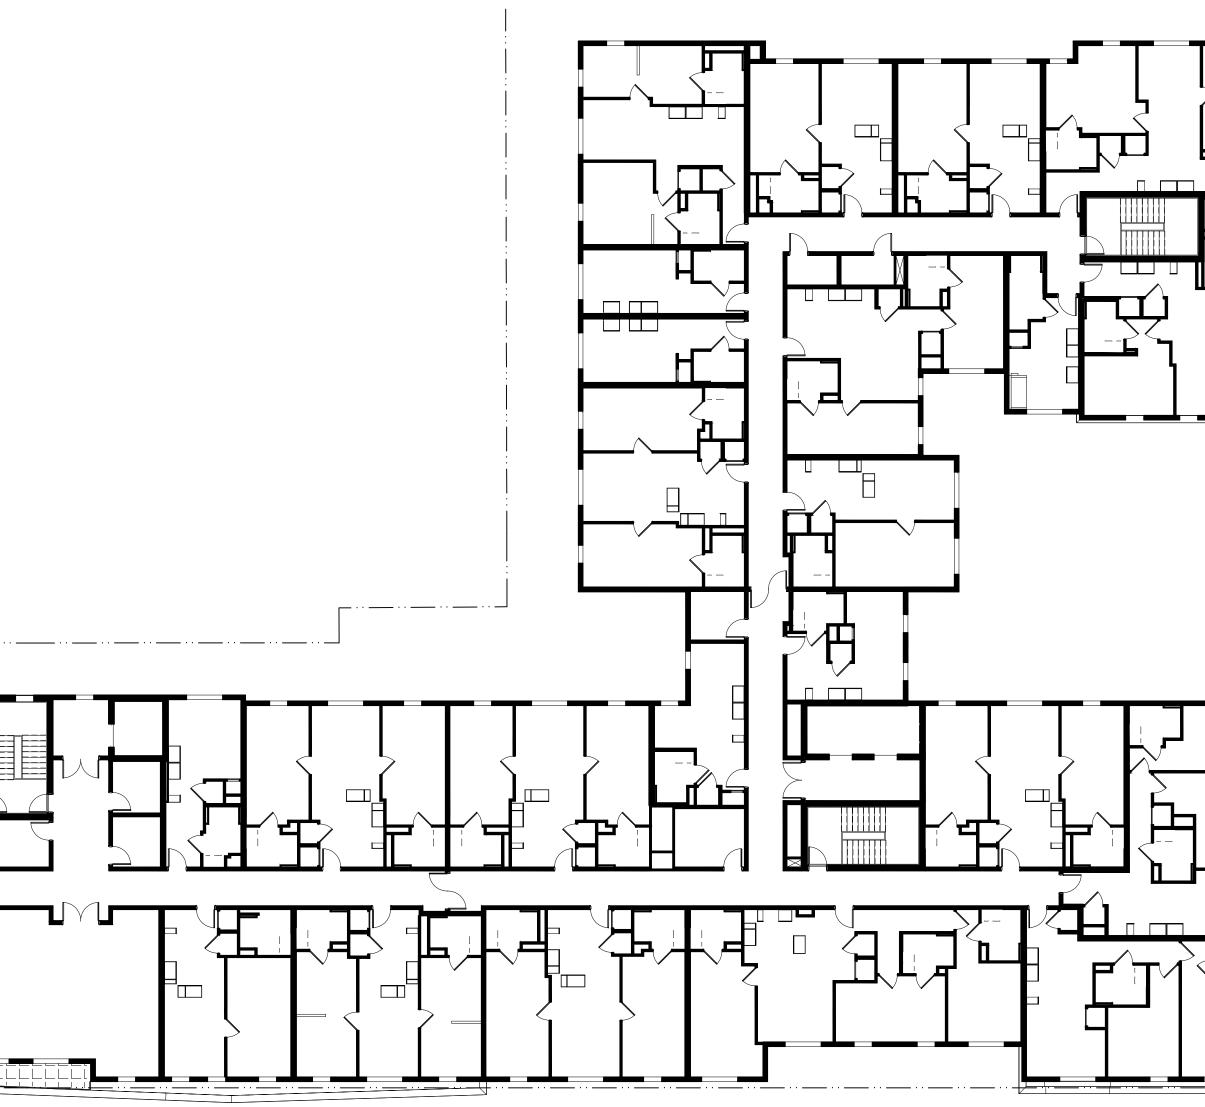

	REVISIONS Image: State of the s
	BERKELEY PLAZA 2065 KITTREDGE STREET BERKELEY, CALIFORNIA
GRAPHIC SCALE (IN FEET) (IN FEET)	NUMBER NUMBER NUMBER DESIGNED: DESIGNED: DESIGNED: DATE 9-23-21 SCALE SHEET L23 SHEET



SPECIMEN ACCENT TREES IN RAISED PLANTERS CERCIS OCCIDENTALIS (WESTERN REDBUD)

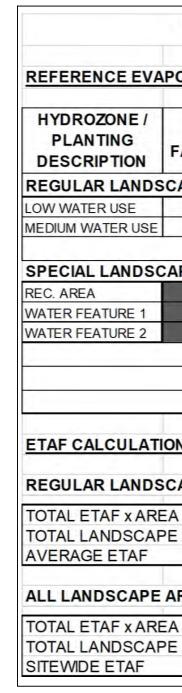

æ

 (\circ)



PROJEC

 GRC ROC

CITY REQUIREMENT THAT LANDSCAPE AREA EQUALS 40% OF USABLE PRIVATE OPEN SPACE TOTAL AREA OF LANDSCAPE PROVIDED EQUALS 21.5% OF USABLE PRIVATE OPEN SPACE

BOTANICAL NAME TREES:	COMMON NAME	MATURE SIZE(H'xW')	SIZE	WUCOLS WATER USE	NATIVE	COUNT
STREET TREE (CITY-APPROVED)		SEE PLAN		MED	NO	9
CERCIS OCCIDENTALIS (LOW-BRANCHIN	NG) WESTERN REDBUD	18'x18'	36" BOX	LOW	YES	6
SHRUBS:						
*+CALYCANTHUS OCCIDENTALIS	SPICE BUSH	8'x5'	5 GA	LOW	YES	11
+ERIOGONUM ARBORESCENS	BUCKWHEAT	4'x4'	5 GA	LOW	YES	15
*+SALVIA CLEVE. 'WINNIFRED GILLMAN'	CALIFORNIA BLUE SAGE	3'x5'	5 GA	LOW	YES	33
TEUCRIUM 'COMPACTA'	DWARF GERMANDER	3'x3'	5 GA	LOW	NO	8
PERENNIALS / GRASSES:						
* +ACHILLEA MILLEFOLIUM	COMMON YARROW	1'x2'	1 GA	LOW	YES	86
ERIGERON GLAUCUS	BEACH ASTER	1'x2.5'	1 GA	LOW	YES	36
*FESTUCA CALIFORNICA	CALIFORNIA FESCUE	2'x3'	5 GA	LOW	YES	8
*JUNCUS PATENS	CALIFORNIA GRAY RUSH	1.5'x3'	1 GA	LOW	YES	41
*MUHLENBERGIA RIGENS	DEER GRASS	4'x4'	5 GA	LOW	YES	14
+PENSTEMON HETEROPHYLLUS	FOOTHILL PENSTEMON	3'x2'	1 GA	LOW	YES	44

POLLINATOR PLANTS NOTE: 64% OF PLANT PALETTE IS NATIVE POLLINATOR SPECIES (189 OF 296 SPECIMENS)


+ DENOTES PLANT SPECIES RECOMMENDED AS POLLINATOR PLANT IN NORTHERN CALIFORNIA

* DENOTES PLANT SPECIES SELECTED FROM THE ALAMEDA COUNTY APPENDIX B STORMWATER MEASURES PLANT LIST

Bioretention Planters

Solutions to manage on-structure Stormwater Filtration Materials: GFRC Concrete, Weathering or Mild Steel with Powder-Coated Finish



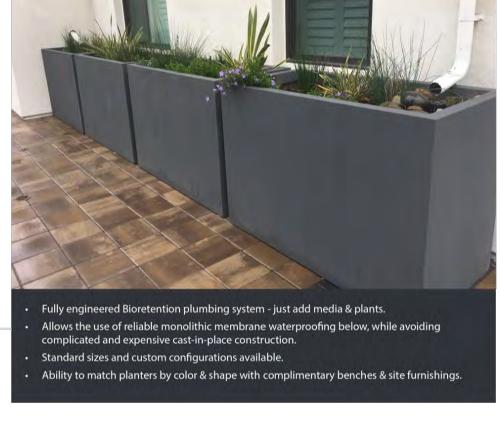

PREFABRICATED BIORETENTION PLANTERS TOURNESOL SITEWORKS FIBERGLASS

WATER	REFFICI	ENT LAN	DSCA	PE WORK	SHEET	
POTRANSPIRA	TION (ETo):	41.8				
PLANT FACTOR (PF)	IRRIGATION METHOD	IRRIGATION EFFICIENCY (IE)	ETAF (PF / IE)	LANDSCAPE AREA (sq. ft.)	ETAF x AREA	ESTIMATED TOTAL WATER USE (ETWU)
CAPE AREAS:						
0.3	DRIP	0.81	0.3703703	1,862	689.6294986	17872.4
0.5	BUBBLER	0.81	0.6172839	90	55.555551	1439.8
			TOTALS:	1952	745	
APE AREAS:						
	The second se		0	0	0	
			0	0	0	
			0	0	0	
			TOTALS:	0	0	
					ETWU TOTAL:	19,312
		MAXIMUMA	LLOWED	WATER ALLOW	ANCE (MAWA):	22,765
DNS:						
CAPE AREAS:						
A	745		NOTE AV	FRAGE ETAF F	OR REGULAR LA	NDSCAPE
E AREA	1,952				BELOW FOR RE	
	0.38				OW FOR NON-RE	
AREAS:			ANEAS.			
A	745					
E AREA	1,952					
	0.38					


GENERAL NOTES:

1. ALL PLANTING SHALL BE WATERED BY FULLY AUTOMATIC, WATER-CONSERVING IRRIGATION SYSTEM. 2. ALL PLANTING AREAS, EXCEPT FOR STORMWATER TREATMENT PLANTERS, SHALL RECEIVE A 3" LAYER OF FIRBARK MULCH DRESSING. 3. STORMWATER TREATMENT PLANTERS SHALL RECEIVE A 2" DEEP LAYER OF 1-3/8"Ø DECORATIVE RIVER-WASHED GRAVEL.

T PRIVATE USABLE LAN	DSCAPE OPEN SP.	ACE	
OUND LEVEL OF LEVEL	<u>TOTAL AREA</u> 4,481 SF 2,742 SF	LANDSCAPE AREA 835 SF 722 SF	
	7,223 SF	1,557 SF	





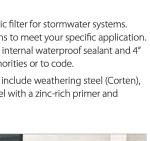



BUILT-IN PLANTERS



PREFABRICATED PLANTERS TOURNESOL 'WILSHIRE' COLLECTION COLOR: BRONZE




BIKE RACKS COLUMBIA CASCADE LOOP RACK WITH GALVANIZED FINISH






ARTIFICIAL FIBERGLASS PEBBLE FURNITURE (LARGE AND SMALL) FROM NATURE WORKS, ENGLAND

A Signature Starta Alt
BERKELEY PLAZA 2065 KITTREDGE STREET BERKELEY, CALIFORNIA
RECOMMENDED PLANT LIST, SITE AMENITY IMAGES
DESIGNED: DRAWN: CHECKED: JOB NO: DATE
9-23-21 SCALE
L3

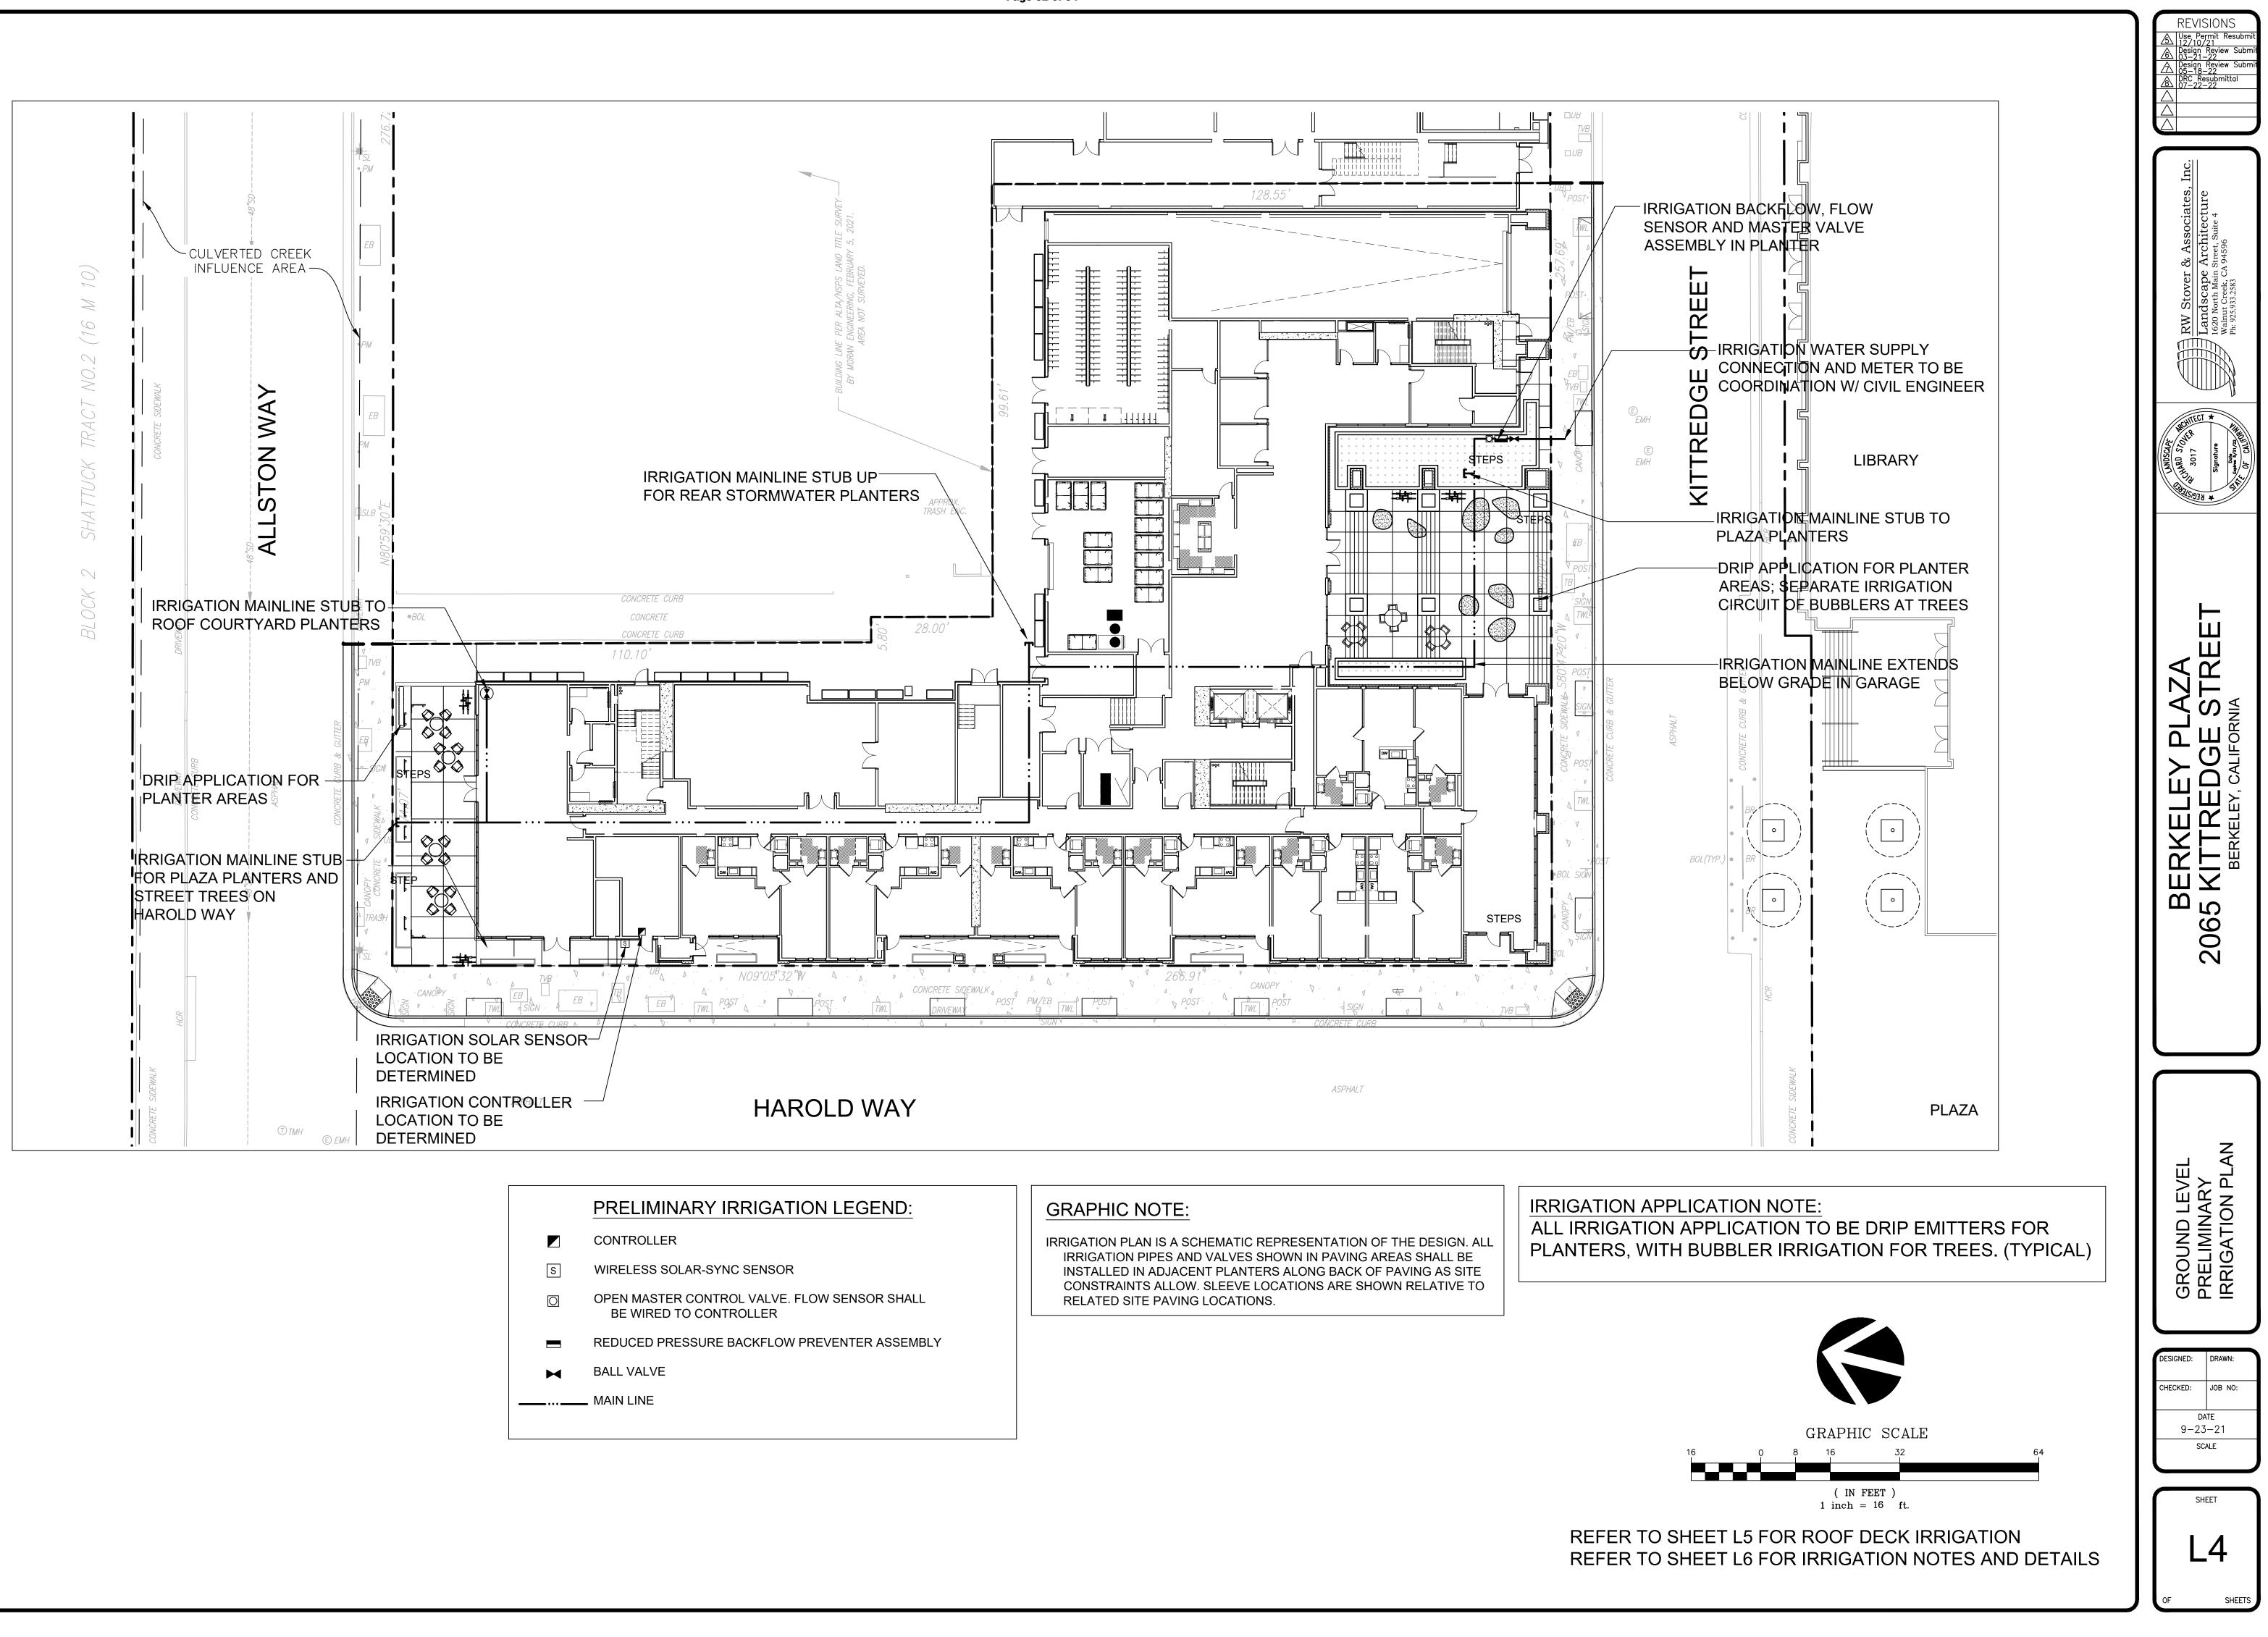

	PRELIM
	CONTROLLE
S	WIRELESS
\bigcirc	OPEN MAST BE WIRE
	REDUCED P
\mathbf{M}	BALL VALVE
	MAIN LINE

ROOF COURTYARD IRRIGATION-TO EXTEND FROM MAINLINE STUB-UP IN RAISED PLANTER

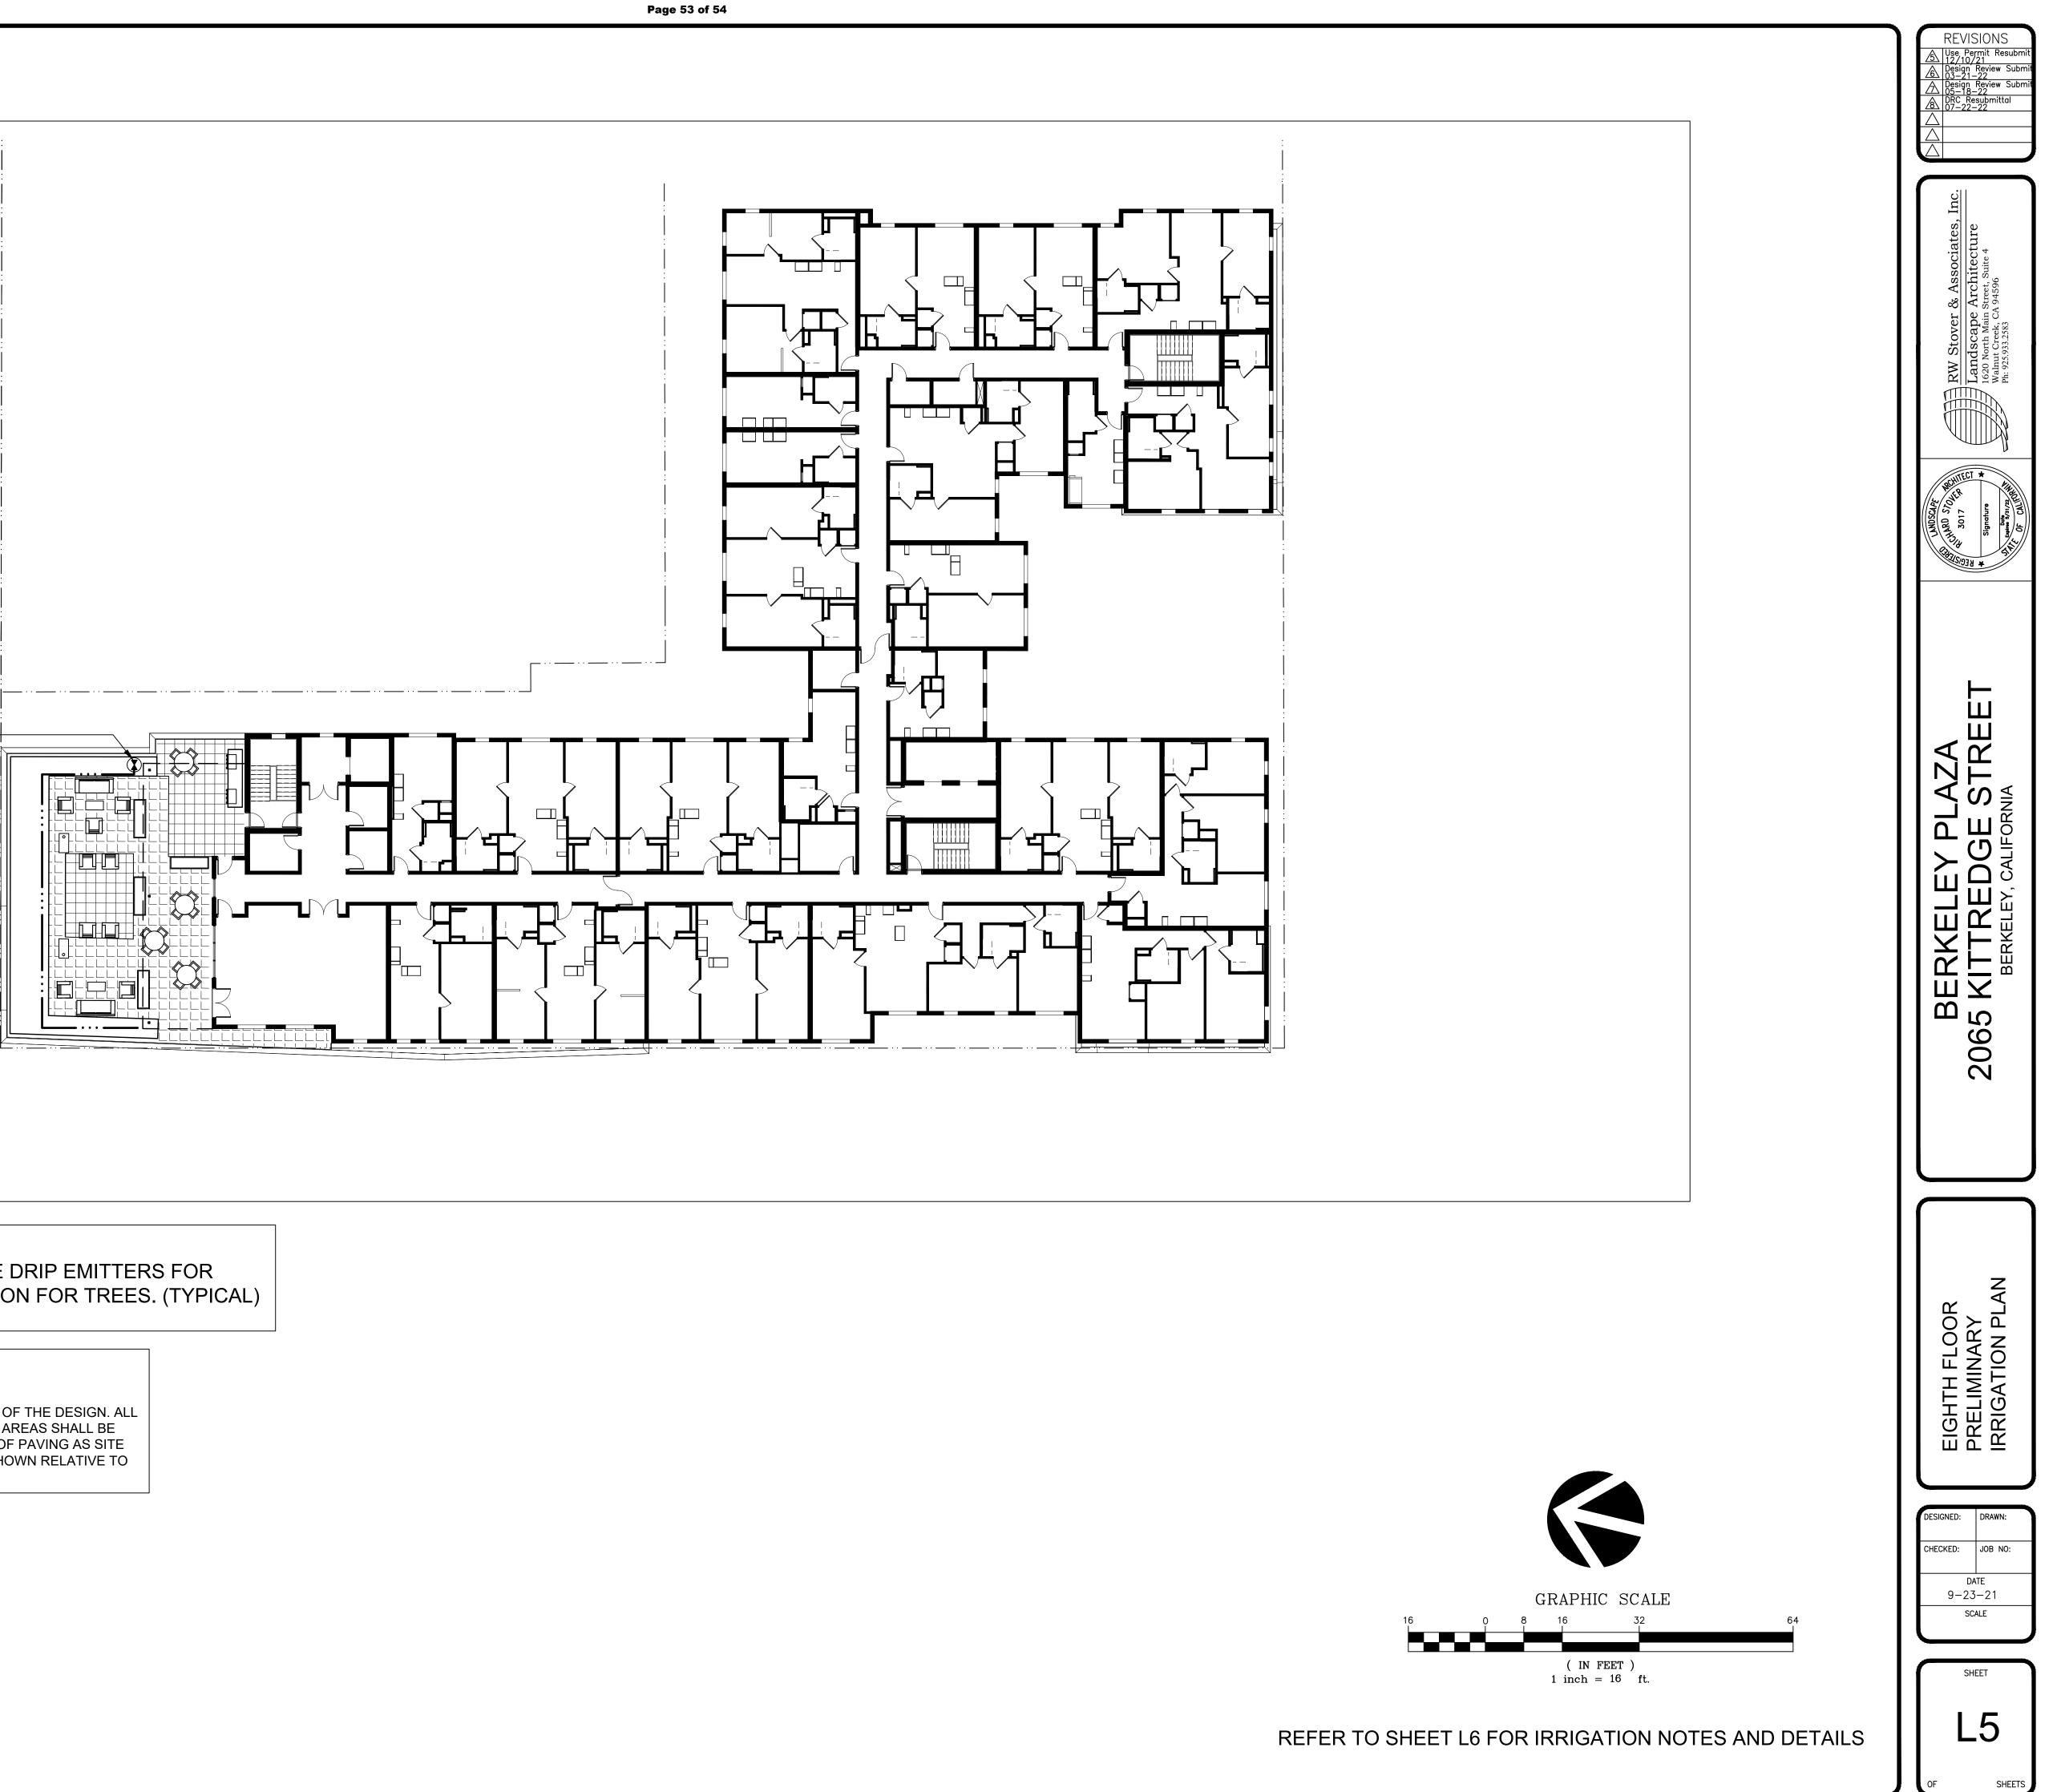



IRRIGATION APPLICATION NOTE:

ALL IRRIGATION APPLICATION TO BE DRIP EMITTERS FOR PLANTERS, WITH BUBBLER IRRIGATION FOR TREES. (TYPICAL)

GRAPHIC NOTE:


IRRIGATION PLAN IS A SCHEMATIC REPRESENTATION OF THE DESIGN. ALL IRRIGATION PIPES AND VALVES SHOWN IN PAVING AREAS SHALL BE INSTALLED IN ADJACENT PLANTERS ALONG BACK OF PAVING AS SITE CONSTRAINTS ALLOW. SLEEVE LOCATIONS ARE SHOWN RELATIVE TO RELATED SITE PAVING LOCATIONS.

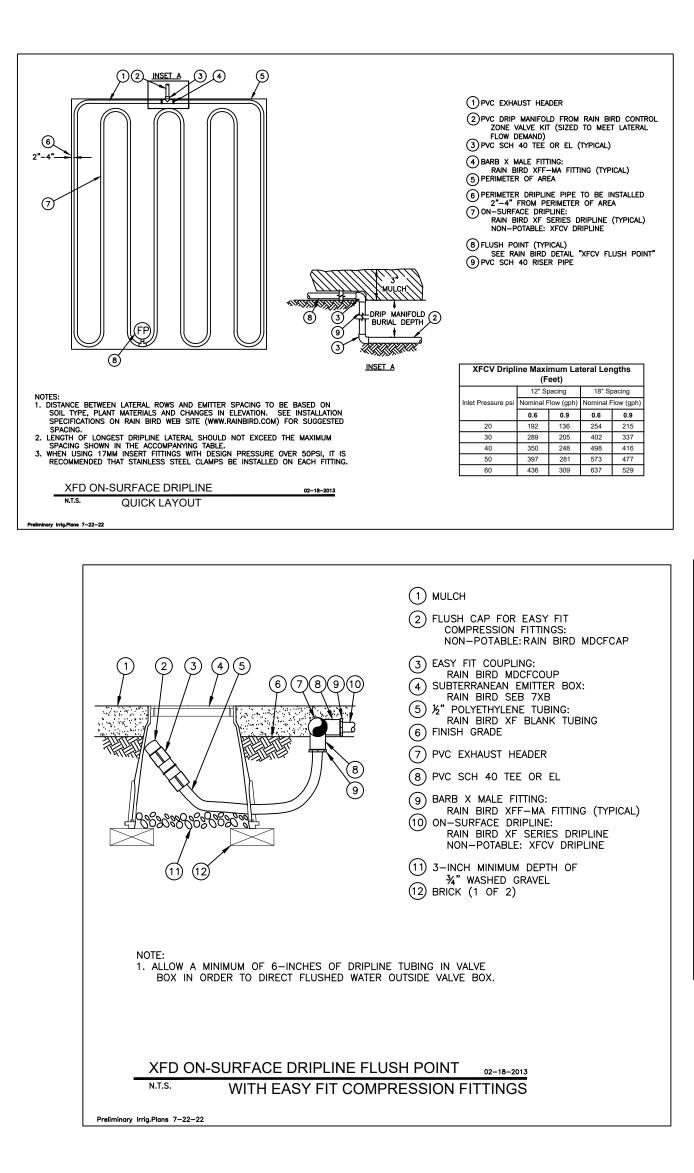


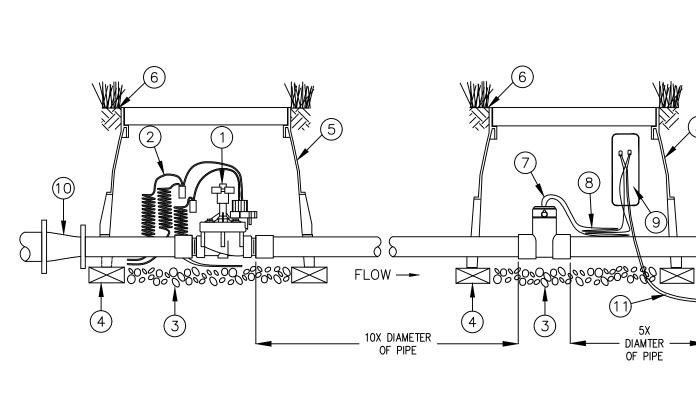

MASTER CONTROL VALVE AND FLOW SENSOR


QUICK-COUPLING VALVE

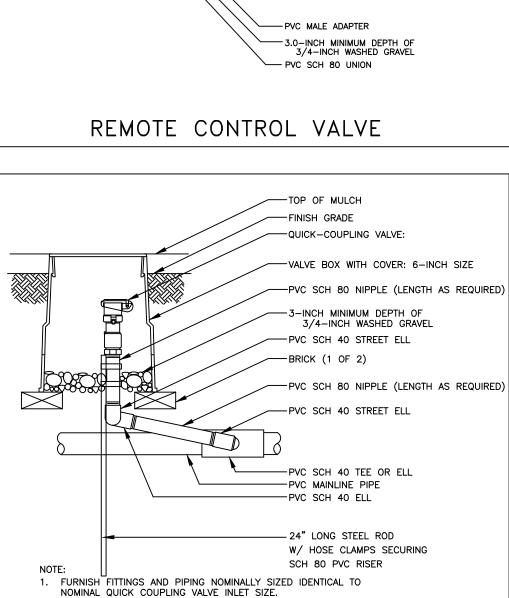


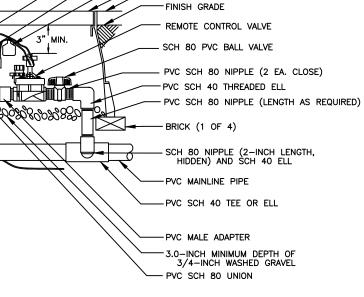


-TOP OF MULCH


WATER PROOF CONNECTION (1 OF 2)

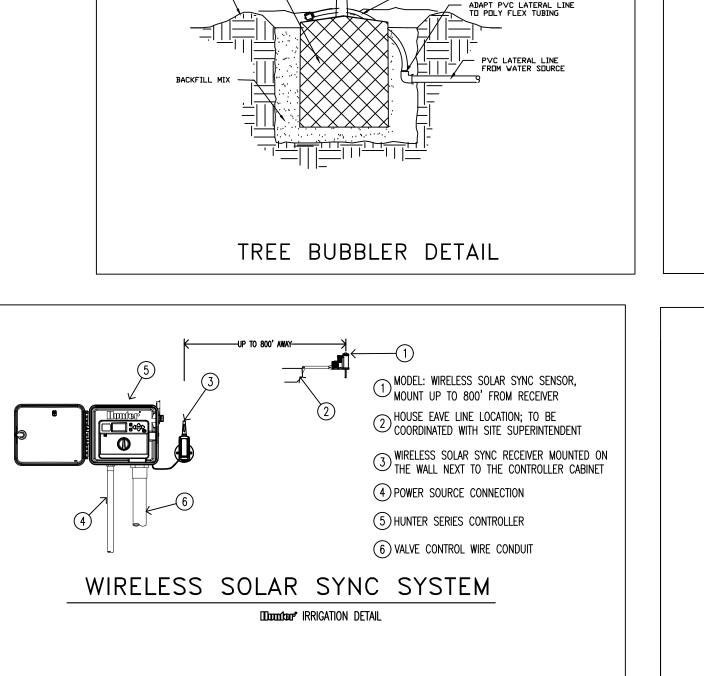

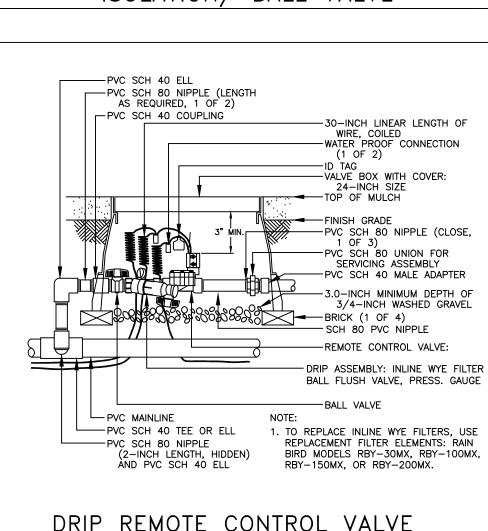

ISOLATION/ BALL VALVE

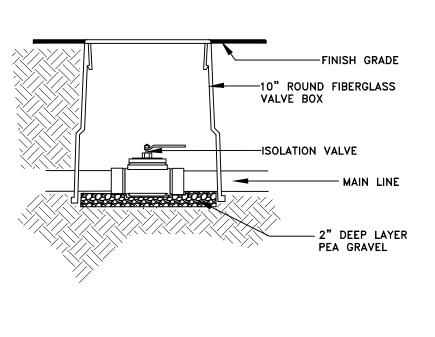

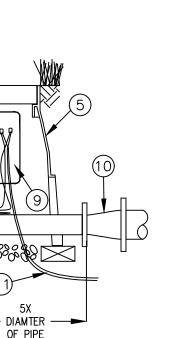

(1)

2

4

5

(9)

(10)

MASTER CONTROL VALVE

3 3.0-INCH MINIMUM DEPTH OF 3/4-INCH

VALVE BOX WITH COVER - 12-INCH SIZE

8 FLOW SENSOR WIRES; LEAVE 36-INCHES OF

PREFORMED SUPER SERVISEAL WATERPROOF

(36-INCH LOOP)

WASHED GRAVEL

BRICK (1 OF 4)

WIRE IN VALVE BOX

CONCENTRIC REDUCER

(1) PE-CABLE TO CONTROLLER ASSEMBLY

WIRE SPLICE KIT

6 FINISH GRADE

7 FLOW SENSOR

WIRE TO SATELLITE CONTROLLER SPARE STATION

FLOOD BUBBLER ON 1/2 POLY FLEX PIPE WITHIN WATERING BASIN

------ TREE TRUNK

RODTBALL: CONTAINER STOCK OR BALL & BURLAP —

> PLANT WATER BASIN SURROUND

IRRIGATION NOTES:

GENERAL NOTES: DO NOT WILLFULLY INSTALL THE IRRIGATION SYSTEM AS SHOWN ON THE DRAWINGS WHEN IT IS OBVIOUS IN THE FIELD THAT OBSTRUCTIONS, GRADE DIFFERENCES OR DIFFERENCES IN AREA DIMENSIONS EXIST THAT MIGHT NOT HAVE BEEN CONSIDERED IN THE DESIGN OF THE SYSTEM. SUCH OBSTRUCTIONS OR DIFFERENCES SHOULD BE BROUGHT TO THE ATTENTION OF THE LANDSCAPE ARCHITECT. NOTIFY LANDSCAPE ARCHITECT OF ANY ASPECTS OF LAYOUT. WHICH WILL PROVIDE INCOMPLETE OR INSUFFICIENT WATER COVERAGE OF PLANT MATERIAL AND DO NOT PROCEED UNTIL THE INSTRUCTIONS ARE OBTAINED. IN THE EVENT THIS NOTIFICATION IS NOT PERFORMED, THE IRRIGATION CONTRACTOR SHALL ASSUME FULL RESPONSIBILITY FOR ANY REVISIONS NECESSARY. IT IS THE RESPONSIBILITY OF THE IRRIGATION CONTRACTOR TO FAMILIARIZE HIMSELF WITH ALL THE GRADE DIFFERENCES, LOCATION OF WALKS, RETAINING WALLS, ETC. PRIOR TO CONSTRUCTIONS. IT SHALL BE THE CONTRACTOR'S RESPONSIBILITY TO PROTECT IN PLACE (BY ALL MEANS NECESSARY) ALL EXISTING UTILITIES UNLESS OTHERWISE SPECIFIED ON THE PANS, CITY STANDARD DRAWINGS, SPECIFICATIONS, SPECIFIC NOTES & DETAIL DRAWINGS AND THE SOILS REPORT TAKE PRECEDENCE OVER GENERAL DRAWINGS AND PLANS UNLESS OTHERWISE DIRECTED ANY DEVIATION FROM APPROVED PLANS DURING CONSTRUCTION WILL REQUIRE 48 HOURS PRIOR NOTICE TO THE LANDSCAPE ARCHITECT. AT LEAST ONE SET OF PLANS SHALL BE ON THE SITE AT ALL TIMES FOR INSPECTION. IRRIGATION CONTRACTOR SHALL COMPLY WITH ALL STATE. COUNTY AND CITY LAWS AND ORDINANCES: AND REGULATIONS OF THE DEPARTMENT OF INDUSTRIAL RELATIONS, O.S.H.A. AND INDUSTRIAL ACCIDENT COMMISSION RELATING TO THE SAFETY AND CHARACTER OF WORK EQUIPMENT AND LABOR PERSONNEL. THE IRRIGATION CONSULTANT ASSUMES NO RESPONSIBILITY BEYOND THE ADEQUACY OF THE DESIGN CONTAINED HEREIN.

DRAWINGS: DUE TO THE SCALE OF DRAWINGS, IT IS NOT POSSIBLE TO INDICATE ALL OFFSETS, FITTINGS, SLEEVES, ETC., WHICH MAY BE REQUIRED. THE CONTRACTOR SHALL ALSO CAREFULLY INVESTIGATE THE STRUCTURAL AND FINISHED CONDITIONS AFFECTING ALL OF HIS WORK, PLAN HIS WORK ACCORDINGLY AND FURNISH SUCH FITTINGS, ETC. AS MAY BE NECESSARY TO MEET SUCH CONDITIONS. DRAWINGS ARE GENERALLY DIAGRAMMATIC AND INDICATIVE OF THE WORK TO BE INSTALLED. THE WORK SHALL BE INSTALLED IN SUCH A MANNER AS TO AVOID CONFLICTS BETWEEN IRRIGATION SYSTEM, PLANTING AND ARCHITECTURAL FEATURES. ALL PIPING, VALVES, ETC. SHOWN WITHIN PAVED AREAS ARE FOR DESIGN CLARIFICATION ONLY AND SHALL BE INSTALLED IN PLANTING AREAS WHERE POSSIBLE.

CONTROLLER: IRRIGATION CONTRACTOR IS TO PROGRAM TIMING OF STATIONS ON CONTROLLER TO IRRIGATE IN THE MOST EFFICIENT, WATER CONSERVING MANNER POSSIBLE. IT IS THE RESPONSIBILITY OF THE LANDSCAPE MAINTENANCE CONTRACTOR AND/OR THE OWNER TO PROGRAM THE IRRIGATION CONTROLLERS TO PROVIDE THE MINIMUM AMOUNT OF WATER NEEDED TO SUSTAIN PROPER PLANT HEALTH. THIS INCLUDES MAKING ADJUSTMENTS TO THE PROGRAM FOR SEASONAL WEATHER CHANGES, PLANT MATERIAL NEEDS, WATER REQUIREMENTS, CHANGES IN ELEVATION, SUN, SHADE AND WIND EXPOSURES. CONTRACTOR SHALL ASSUME RESPONSIBILITY FOR ANY DAMAGE, EROSION, PUDDLING, ETC. DUE TO IMPROPER PROGRAMMING. ELECTRICAL CONTRACTOR TO SUPPLY 120-VOLT A.C. (2.5 AMP) SERVICE & DISCONNECT, JUNCTION BOX AND CONDUIT, AS NECESSARY, TO CONTROLLER LOCATION. IRRIGATION CONTRACTOR TO MAKE FINAL CONNECTION FROM ELECTRICAL STUB-OUT TO CONTROLLER. INSTALL NEW 9-VOLT DURACELL BATTERY(S) IN EACH CONTROLLER (IF REQUIRED) TO RETAIN PROGRAM IN MEMORY DURING TEMPORARY POWER FAILURES. CONTROLLER SHALL HAVE GROUND WIRE AS PER MANUFACTURER'S INSTRUCTIONS.

VALVES: BACKFLOW DEVICE, ISOLATION AND CONTROL VALVE LOCATIONS SHOWN ARE DIAGRAMMATIC. INSTALL IN GROUNDCOVER / SHRUB AREAS AT THE EDGES OF THE PLANTING AREAS SO AS TO NOT INTERFERE WITH PLANT HOLE EXCAVATION. INSTALL VALVE BOXES 12 INCHES FROM AND PERPENDICULAR TO: WALKS, CURBS, ETC. AND EACH BOX SHALL BE 12 INCHES APART. THE SHORT SIDE OF VALVE BOX SHALL BE PARALLEL TO WALK, CURB, ETC. INSTALL (1) VALVE PER RECTANGULAR BOX INLINE WITH THE LENGTH OF THE BOX. LOCATE QUICK COUPLING VALVES 2 INCHES FROM HARDSCAPE AREA.

WIRING: CONTROL WIRES SHALL BE U.L. APPROVED FOR DIRECT BURIAL IN GROUND, COPPER SIZE #14-1. COMMON GROUND WIRE SHALL HAVE WHITE INSULATION JACKET. CONTROL WIRE SHALL HAVE INSULATION JACKET OF COLOR OTHER THAN WHITE. SPLICING SHALL BE DONE WITH 3M #3570 SCOTCHLOK SEAL PACKS. SPLICING OF 24-VOLT WIRES WILL NOT BE PERMITTED EXCEPT IN VALVE BOXES. LEAVE A 24 INCH COIL OF EXCEL WIRE AT EACH SPLICE AND AT 100 FEET ON CENTER ALONG WIRE RUN. TAPE WIRE IN BUNDLES AT 10 FEET ON CENTER. NO TAPING PERMITTED IN SLEEVES. INSTALL A CONTROL WIRE FOR EACH EXTRA STATION LEFT ON THE CONTROLLER AND A SPARE CONTROL WIRE OF A DIFFERENT COLOR ALONG THE ENTIRE MAIN LINE. LOOP 24 INCHES OF EXCESS WIRE INTO EACH SINGLE VALVE BOX AND INTO ONE VALVE BOX IN EACH GROUP OF VALVES.

ON-GRADE DRIP LINE SYSTEM: ALL DRIP LINE TO BE SET ON GRADE IN PARALLEL ROWS AS REQUIRED TO PROVIDE COMPLETE COVERAGE OF GROUND COVER AREAS AS WELL AS SHRUB PLANTING. EMITTERS PROVIDE 0.90 GALLONS PER HOUR FLOW (APPROXIMATELY 1.0 GALLON PER 100 LINEAR FEET OF DRIP LINE). DESIGN LIMITS RECOMMEND NOT EXCEEDING 200 FEET OF TUBING FOR ANY SINGLE LENGTH. STAKE TUBING TO GRADE WITH GALVANIZED TIE-DOWN STAKES AT 3 FT. (MAX.) SPACING. PROVIDE XF DRIPLINE INSERT FITTINGS FOR ALL CONNECTIONS. PROVIDE REMOVABLE THREADED END CAPS AT THE TERMINUS OF EACH DRIP LINE LENGTH FOR EASY FLUSHING OF SYSTEM.

PIPING/TRENCHING: INSTALL MAIN LINE PIPING WITH CONCRETE THRUST BLOCKS AS PER MANUFACTURER'S RECOMMENDATION. MAIN AND LATERAL LINES SHALL BE SURROUNDED WITH A MINIMUM OF 2" OF SAND OR ROCK FREE SOIL. PIPE SEALANT COMPOUND SHALL BE RECTOR SEAL T+2, PERMATEX 51 OR LASCO #905305. PRESSURE THE MAIN LINE @ 150 PSI FOR 2 HOURS AND THE LATERAL LINES @ 100 PSI FOR 2 HOURS, WHERE IT IS NECESSARY TO EXCAVATE ADJACENT TO EXISTING TREES, THE CONTRACTOR SHALL USE ALL POSSIBLE CARE TO AVOID INJURY TO TREES, AND TREE ROOT SYSTEMS. EXCAVATION IN AREA WHERE TWO (2) INCH AND LARGER ROOTS EXIST SHALL BE DONE BY HAND. CUT ROOTS ONE (1) INCH AND LARGER IN DIAMETER SHALL BE PAINTED WITH TWO COATS OF TREE SEAL, OR EQUAL. TRENCHES ADJACENT TO TREES SHOULD BE CLOSED WITHIN TWENTY-FOUR (24) HOURS; AND WHERE THIS IS NOT POSSIBLE, THE SIDE OF THE TRENCH ADJACENT TO THE TREE SHALL BE KEPT SHADED WITH WET BURLAP OR CANVAS.

SLEEVES: THE IRRIGATION CONTRACTOR SHALL COORDINATE WITH THE GENERAL CONTRACTOR AND OTHER SUBCONTRACTORS FOR THE LOCATION AND THE INSTALLATION OF SLEEVES, CONDUIT OR PIPE THROUGH WALLS, UNDER ROADWAYS, PAVING, STRUCTURES, ETC. PRIOR TO CONSTRUCTION. IN ADDITION TO THE SLEEVES AND CONDUITS SHOWN ON THE DRAWINGS, THE IRRIGATION CONTRACTOR SHALL BE RESPONSIBLE FOR THE COORDINATION AND/OR INSTALLATION OF SLEEVES AND CONDUITS OF SUFFICIENT SIZE UNDER ALL PAVED AREAS.

IRRIGATION SYSTEM: THE IRRIGATION SYSTEM IN CURRENTLY POTABLE, SET UP FOR POSSIBLE RETROFIT TO RECYCLED WATER SOURCE IN FUTURE. DESIGN IS BASED ON A MINIMUM OPERATING PRESSURE (PSI) AND A FLOW DEMAND (GPM) AS NOTED ON PLAN. THE IRRIGATION CONTRACTOR SHALL VERIFY WATER PRESSURE PRIOR TO CONSTRUCTION. REPORT ANY DIFFERENCE BETWEEN THE WATER PRESSURE INDICATED ON THE DRAWINGS AND THE ACTUAL PRESSURE READING AT THE IRRIGATION POINT-OF CONNECTION TO THE LANDSCAPE ARCHITECT. FAILURE TO DO SO WILL RESULT IN THE CONTRACTOR BEING RESPONSIBLE FOR ANY NECESSARY CHANGES DUE TO THIS DIFFERENCE.

GUARANTEE: ALL CONSTRUCTION, PARTS AND PRODUCTS BY THE LANDSCAPE CONTRACTOR AND/OR HIS SUBCONTRACTORS SHALL BE GUARANTEED FOR ONE (1) FULL YEAR AFTER THE BEGINNING OF THE MAINTENANCE PERIOD. THE CONTRACTOR SHALL REPLACE (AT NO EXPENSE TO THE OWNER) ANY AND ALL IRRIGATION PRODUCTS THAT ARE IN AN UNACCEPTABLE CONDITION FOR THE TIME OF USE. REPLACEMENT OF ANY ITEMS SHALL MATCH ORIGINAL DESCRIPTION OF ITEM(S) ON CONSTRUCTION PLANS AND SHALL BE INSTALLED PER SPECIFICATION. THE CONTRACTOR SHALL NOT BE HELD LIABLE FOR LOSS OF IRRIGATION PARTS OR PRODUCTS DUE TO VANDALISM, ACCIDENTAL CAUSES, OR ACTS OF NEGLECT BY OTHERS THAN THE CONTRACTOR, HIS AGENTS OR EMPLOYEES.

DO NOT BID, ORDER MATERIALS OR INSTALL ANY OR ALL OF SYSTEM BEFORE READING THE IRRIGATION NOTES IN THEIR ENTIRETY. THE CONTRACTOR SHALL ASSUME FULL RESPONSIBILITY FOR ALL CHANGES, REVISIONS AND OR ADDITIONS TO SYSTEM DUE TO FAILURE TO DO SO.

